Piqua High School I Indian Trail Piqua, Ohio 45356

PLUMBING LEGEND AND GENERAL NOTES


FIRST FLOOR OVERALL DATA PLAN - NEW WORK

DESIGN TEAM

ARCHITECT:



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WALL / SYMBOL LEGEND EXISTING WALLS/FINISHES TO BE REMOVED EXISTING WALL TO REMAIN (CMU, UNLESS NOTED OTHERWISE) NEW METAL STUD FRAME WALL NEW CMU WALL

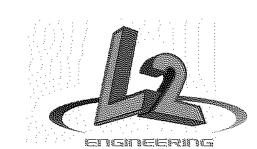M-I —

WALL TYPE KEY



NEW CONSTRUCTION KEY NOTE

DEMOLITION KEY NOTE



REFLECTED CEILING KEY NOTE WINDOW TYPE KEY



DOOR TYPE KEY



ELEVATION TAG

PROJECT TITLE SHEET G1.2OVERALL BUILDING KEY FLOOR PLANS / CODE REVIEW

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ABBREVIATIONS

GAUGE

ADAAG	AMERICANS WITH DISABILITIES	GYP BD	GYPSUM BOARD
	ACT ACCESSIBILITY GUIDELINES	GC	GENERAL CONTRACTOR
AFF ABOVE FINISH FLOOR		HM	HOLLOW METAL
ALUM	ALUMINUM	HT	HEIGHT
BLKG	BLOCKING	HOR	HORIZONTAL
BET	BETWEEN	MAX	MAXIMUM
BRG	BEARING	MECH	MECHANICAL
	BOTTOM	MO	MASONRY OPENING
BTM CIP	CAST IN PLACE	MTD	MOUNTED
		MTL	METAL
CL	CENTERLINE	NIC	NOT IN CONTRACT
CLG	CEILING	NTS	NOT TO SCALE
CT	CERAMIC TILE	OC	ON CENTER
CLR COL	CLEAR	OPG	OPENING
CPT	COLUMN CARPET	PTD	PAINTED
CONC	CONCRETE	RAD	RADIUS
CMU	CONCRETE MASONRY UNIT	REF	REFRIGERATOR
CONT	CONTINUOUS	REQ'D	REQUIRED
CJ	CONTROL JOINT	RD	ROOF DRAIN
DF	DRINKING FOUNTAIN	QT	QUARRY TILE
DIA	DIAMETER	RO	ROUGH OPENING
DS	DOWNSPOUT	ATC	ACOUSTIC TILE CEILING
DTL	DETAIL	SIM	SIMILAR
DW	DISH WASHER	SM	SHEET METAL
ELEV	ELEVATION	SPEC	SPECIFICATION
EQ	EQUAL	55	STAINLESS STEEL
FD .	FLOOR DRAIN	5 Q	SQUARE
FDN	FOUNDATION	STL	STEEL
FE	FIRE EXTINGUISHER	T.O.	TOP OF
FF	FINISH FLOOR	TYP	TYPICAL
FIN	FINISH(ED)	UFAS	UNIFORM FEDERAL ACCESSIBILITY STANDARD
FRT	FIRE RETARDANT TREATED	WRB	WEATHER RESISTIVE BARR
FSE	FOOD SERVICE EQUIPMENT	MME	WELDED WIRE FABRIC
FT6	FOOTING		
FV	FIELD VERIFY		

ALLOWANCES

THE FOLLOWING CASH ALLOWANCES ARE TO BE INCLUDED IN THE TOTAL BID AMOUNT FOR THE PROJECT. REFER TO THE BID FORM AND SPEC SECTION OF OO FOR ADDITIONAL INFORMATION. UNUSED ALLOWANCES WILL BE CREDITED BACK TO THE OWNER AT THE END OF THE PROJECT.

\$200,000

\$10,000 \$35,000

PROJECT CONTINGENCY ALLOWANCE 2. PERMIT ALLOWANCE
3. DOOR HARDWARE / CORES

GROUP ARCHITECTS 7945 Washingtor Woods Drive Dayton, Ohio 45459 O: 937.610.3440 F: 937.610.3441 JONATHAN **ROBERT** SCHAAF Jonathan Robert Schaaf #14503 Expiration Date 12/31/2023

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2022 Project $\frac{1}{2}$

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UNIT PRICES

UNIT PRICES FOR THE FOLLOWING WORK SCOPE ITEMS SHALL BE INCLUDED WITH THE BID

UP-3 REMOVE EXISTING, RE-POINT MORTAR JOINT IN EXISTING MASONRY, PER LINEAR FOOT

UP-5 REMOVE EXISTING, INSTALL NEW 8" CMU BLOCK, EACH UP-6 INSTALL THRU-PENETRATION FIRE STOP FOR ELECTRICAL CONDUIT / MC CABLE / EMT

PENETRATION THRU RATED CMU WALL ASSEMBLY, EACH UP-7 INSTALL THRU-PENETRATION FIRE STOP FOR DATA CABLING PENETRATION THRU

RATED CMU WALL ASSEMBLY, EACH UP-8 INSTALL THRU-PENETRATION FIRE STOP FOR PLUMBING SUPPLY PIPING PENETRATION

THRU RATED CMU WALL ASSEMBLY, EACH UP-9 INSTALL THRU-PENETRATION FIRE STOP FOR PLUMBING DRAIN / WASTE / VENT PIPING

SUBMISSION. REFER TO BID FORM AND SPEC SECTION OI OO OO.

UP-I REMOVE AND REPLACE SEALANT JOINT, PER LINEAR FOOT UP-2 PREP AND PAINT EXISTING CMU WALL, PER SQUARE FOOT

UP-4 REMOVE EXISTING, INSTALL NEW 6" CMU BLOCK, EACH

PENETRATION THRU RATED CMU WALL ASSEMBLY, EACH UP-IO INSTALL / REPAIR EXISTING SPRAY APPLIED FIRESAFING AT ROOF DECK AND ROOF STRUCTURAL FRAMING MEMBERS, PER SQUARE FOOT

THE PLANS AND SPECIFICATIONS ARE INTENDED TO DEPICT THE GENERAL SCOPE, LAYOUT AND QUALITY OF WORKMANSHIP REQUIRED. THE DOCUMENTS ARE NOT AN 'INSTRUCTION MANUAL' TO EXECUTE THE WORK NOR ARE THEY INTENDED TO SHOW OR DESCRIBE IN DETAIL EVERY ITEM NECESSARY FOR THE PROPER INSTALLATION OF THE WORK. THE MEANS AND METHODS REQUIRED TO EXECUTE THE WORK DESCRIBED IS THE SOLE RESPONSIBILITY OF THE CONTRACTOR. THE CONTRACTOR SHALL INCLUDE THE ANCILLARY WORK REQUIRED, WHETHER EXPLICITLY STATED OR NOT, FOR THE PROPER COMPLETION OF THE WORK AS INTENDED. THE CONTRACTOR IS REQUIRED TO MEET OR EXCEED BUILDING CODE REQUIREMENTS, APPLICABLE INDUSTRY STANDARDS, ASTM STANDARDS, AND/OR MANUFACTURER INSTALLATION REQUIREMENTS AS THEY RELATE TO THE WORK.

THE PLANS AND SPECIFICATIONS REPRESENT A SINGLE COMPLETE DESIGN PACKAGE INDICATING THE INTENDED SCOPE OF THE PROJECT IN ITS ENTIRETY. AS SUCH, THE PROJECT IS STRUCTURED TO BE AWARDED TO A SINGLE PRIME CONTRACTOR. THE DOCUMENTS DO NOT DELINEATE BID PACKAGES OR ASSIGN RESPONSIBILITIES TO ANY SUBSEQUENT SUBCONTRACTORS, DICTATE CONSTRUCTION SEQUENCING, NOR PROVIDE COORDINATION BETWEEN ANY 'TRADES'. SUCH ACTIVITIES ARE THE RESPONSIBILITY OF THE HOLDER OF THE CONSTRUCTION CONTRACT. IN THE EVENT OF A DISCREPANCY WITHIN THE DRAWINGS OR BETWEEN THE DRAWINGS AND THE SPECIFICATIONS, THE MORE STRINGENT REQUIREMENT REPRESENTED IN THE DOCUMENTS SHALL PREVAIL.

GENERAL CONTRACT BID/CONSTRUCTION PACKAGE IS INCLUSIVE OF ALL WORK OUTLINED IN THE CONTRACT DOCUMENTS ACROSS ALL DISCIPLINES AND INCLUDING ALL TRADES/CONTRACTORS LISTED, UNLESS SPECIFICALLY EXCLUDED AS NOTED IN THE DOCUMENTS AS "BY OWNER". WORK SCOPE INCLUDES BUT IS NOT LIMITED TO ALL PRODUCTS, LABOR, AND COORDINATION REQUIRED FOR A COMPLETE INSTALLATION AND RESULTING IN A FULLY FUNCTIONING FACILITY CONFORMING TO THE DESIGN SPECIFICATIONS AND ALL APPLICABLE BUILDING CODES.

Project Number 2021-203 Date January 24, 2022

PROJECT TITLE SHEET

Sheet Number

Sheet Title

Print Record


10/11/21 PRELIMINARY


12/07/21 DESIGN REVIEW

CONSTRUCTION

11/16/21 REVIEW

01/11/22 REVIEW 01/24/22 BID SET/

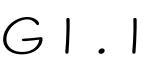

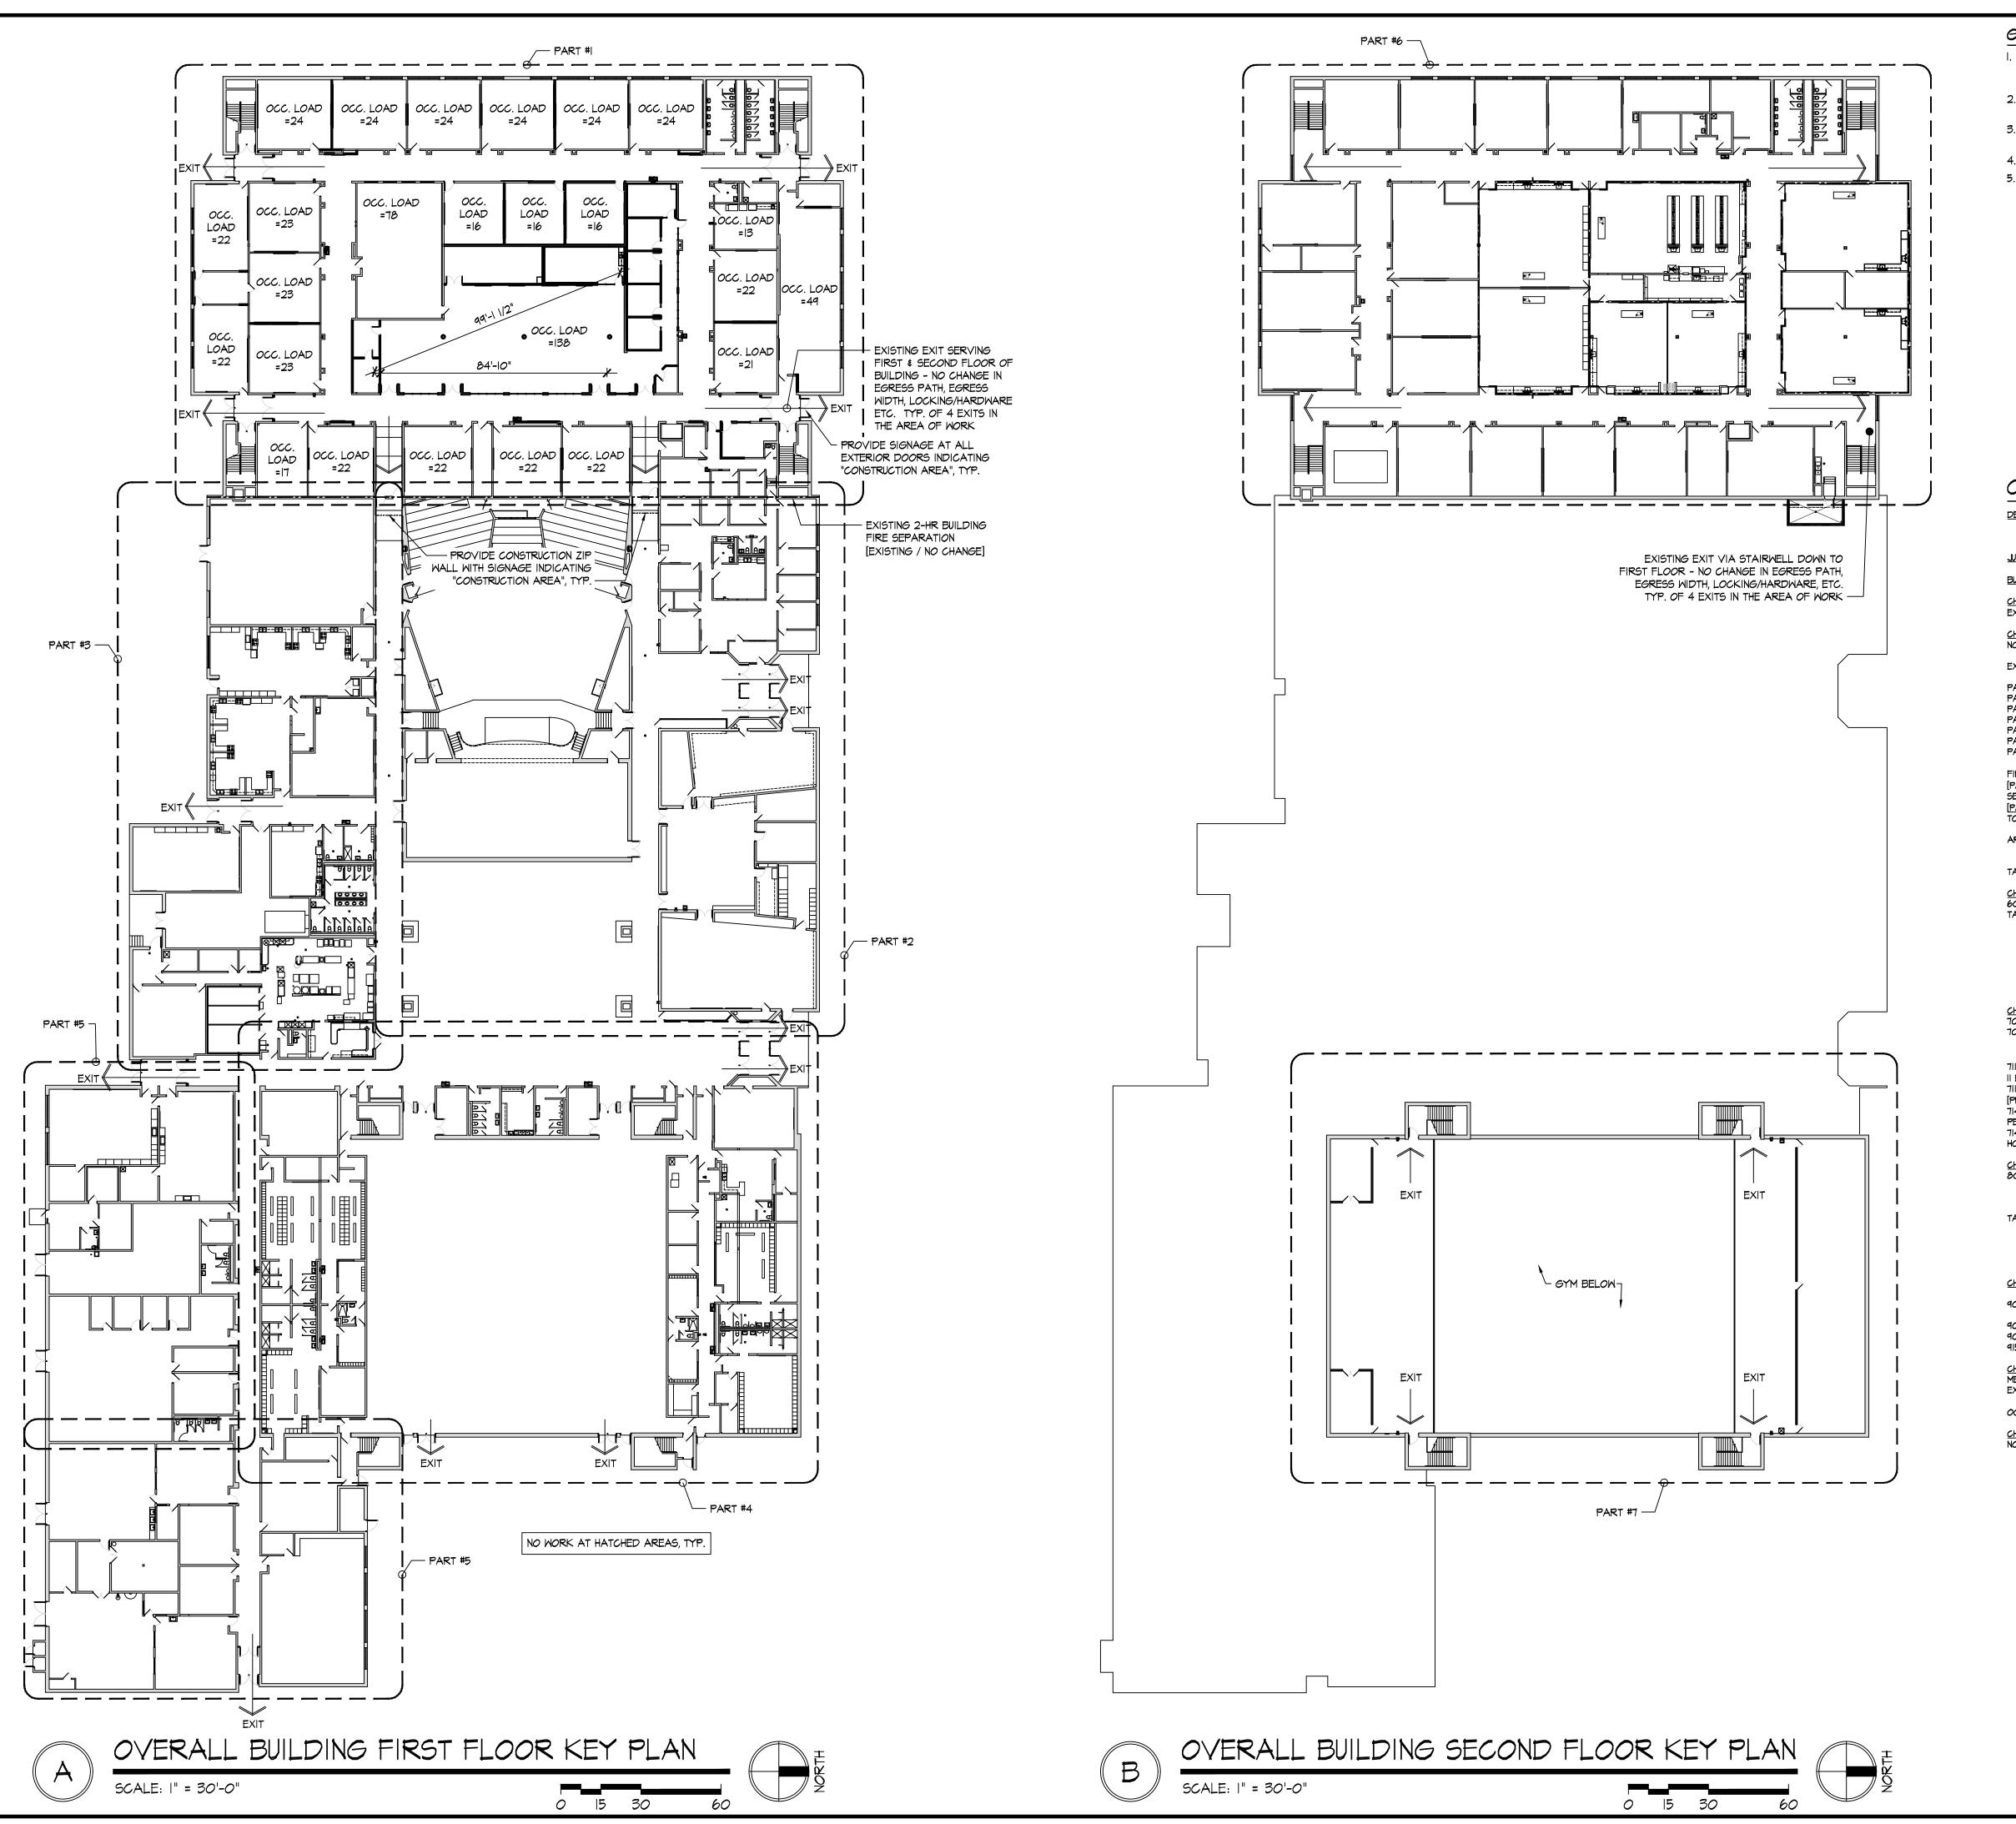

GENERAL NOTES

I. NO CHANGE IN EXITS - INCLUDING DOOR LOCATIONS, WIDTHS OR TRAVEL DISTANCE. ALL EXIT DOORS ARE BEING REPLACED WITH THE SAME OR GREATER WIDTH AS ORIGINAL.

2. MAINTAIN EXISTING FIRE EXTINGUISHERS - LOCATIONS, CABINETS, ETC. COORDINATE WITH FIRE DEPARTMENT.

3. MAINTAIN EXISTING FIRE ALARM SYSTEM - MODIFY/UPGRADE DEVICES, ETC. AS

REQ'D BY WORK [DELEGATED DESIGN].

4. BUILDING IN NON-SUPPRESSED - EXISTING CONDITION. NO CHANGE.

5. MAINTAIN EXISTING/UPGRADE EMERGENCY LIGHTING/EXIT SIGNS AS INDICATED..

Dayton, Ohio 45459 O: 937.610.3440 F: 937.610.3441 JONATHAN ROBERT SCHAAF Jonathan Robert Schaaf #14503

GROUP

ARCHITECTS

7945 Washingtor

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Expiration Date 12/31/2023

CODE REVIEW

<u>DESCRIPTION:</u> ALTERATIONS TO A PORTION OF PIQUA HIGH SCHOOL FOR AN INTERIOR ALTERATIONS PROJECT AT PART I, DOOR/ HARDWARE REPLACEMENT

CITY OF PIQUA, MIAMI COUNTY JURISDICTION: BUILDING CODE: 2017 OHIO BUILDING CODE [OBC]:

CHAPTER 5: GENERAL BUILDING HEIGHT AND AREA

EXISTING BUILDING AREA:

PART | = 36,645 SF PART 2 = 35,536 SF

PART 6 = 36,826 SF PART 7 = 11,574 SF

ROOF CONSTRUCTION = 0 HOUR

PART I: 36,645 SF

TABLE 508.4: NO SEPARATION REQUIREMENT BETWEEN E AND A USES

CHAPTER 6: TYPES OF CONSTRUCTION
602.3: CONSTRUCTION TYPE: II B, NON COMBUSTIBLE TABLE 601: FIRE RESISTANCE RATING REQUIREMENTS FOR BUILDING ELEMENTS PRIMARY STRUCTURAL FRAME = 0 HOUR EXTERIOR BEARING WALLS = 0 HOUR INTERIOR BEARING WALLS = O HOUR EXTERIOR NON-BEARING WALLS - REFER TO TABLE 602 INTERIOR NON-BEARING WALLS = O HOUR

CONSTRUCTION - CORRIDOR WALLS] 711.2.3: SUPPORTING CONSTRUCTION IS NOT REQUIRED TO BE FIRE RATED PER EXCEPTION I, [TYPE II B CONSTRUCTION, INCIDENTAL USE NOT EXCEEDING I HOUR] 711.2.4.5: HORIZONTAL ASSEMBLIES FOR INCIDENTAL USE AREA, PER TABLE 509 = 1 HOUR

714.4.1.2: THRU-PENETRATION FIRESTOP SYSTEM: 'F' OR 'T' RATING OF NOT LESS THAN THE HORIZONTAL ASSEMBLY PENETRATED

803.I.I: INTERIOR WALL AND CEILING FINISH MATERIALS

CLASS A = FLAME SPREAD INDEX 0-25, SMOKE DEVELOPED INDEX 0-450 CLASS B = FLAME SPREAD INDEX 26-75, SMOKE DEVELOPED INDEX 0-450 CLASS C = FLAME SPREAD INDEX 76-200, SMOKE DEVELOPED INDEX 0-450
TABLE 803.II: INTERIOR WALL AND CEILING FINISH REQUIREMENTS USE 'E', NONSPRINKLERED INTERIOR EXIT STAIRWAYS/ EXIT PASSAGEWAYS: CLASS A

CHAPTER 9: FIRE PROTECTION SYSTEMS

915.2.3: USE 'E' - CARBON MONOXIDE DETECTORS REQUIRED IN CLASSROOMS

CHAPTER IO: MEANS OF EGRESS MEANS OF EGRESS, NO CHANGE

CHAPTER 29: PLUMBING SYSTEMS NO CHANGES

THROUGHOUT. NO CHANGE TO BUILDING AREA, HEIGHT, EGRESS, ETC.

CHAPTER 3: USE AND OCCUPANCY CLASSIFICATION EXISTING USE GROUP - 'E' EDUCATION [NO CHANGE OF USE]

NO CHANGE TO EXISTING BUILDING HEIGHT / AREA

PART 3 = 16,455 SF PART 4 = 27,441 SF PART 5 = 21,770 SF

FIRST FLOOR AREA (BUILDING FOOTPRINT) [PARTS 1, 2, 3, 4, \$5] = 137,847 SF SECOND FLOOR AREA [PARTS 6 & 7] = 48,400 SI TOTAL BUILDING AREA = 186,247 SF

AREA OF WORK THIS PROJECT:

FLOOR CONSTRUCTION = O HOUR

<u>CHAPTER 7:</u> FIRE-RESISTANCE RATED CONSTRUCTION
107.3.7 FIRE BARRIERS AS SEPARATION FOR INCIDENTAL USE AREA, PER TABLE 509 = 1 HOUR
108.1: FIRE PARTITIONS - CORRIDOR WALLS PER OBC 1020.1 = 1 HOUR [SUPPORTING CONSTRUCTION NOT REQUIRED TO BE FIRE RATED PER 108.4, TYPE II B

[PROVIDED WITH EXISTING CONCRETE FLOOR ASSEMBLY]
714.3.1.2: THRU-PENETRATION FIRESTOP SYSTEM: "F" RATING OF NOT LESS THAN THE WALL

CHAPTER &: INTERIOR FINISHES

CORRIDORS / ENCLOSURE FOR EXIT ACCESS STAIRS: CLASS B ROOMS AND ENCLOSED SPACES: CLASS C

903.2.3: SPRINKLER - NONE EXISTING, EXISTING NON-CONFORMING CONDITION, NO CHANGE

906: PORTABLE FIRE EXTINGUISHERS PROVIDED - NO CHANGE 907.2.3: USE 'E' - FIRE ALARM SYSTEM PROVIDED, ALTERED AS REQ'D BY WORK.

EXITS, NO CHANGE: II EXITS TOTAL - EXISTING [4 EXITS PROVIDED FROM EACH SECOND FLOOR - EXISTING] OCCUPANT LOAD, NO CHANGE

Print Record 10/11/21 PRELIMINARY 12/07/21 DESIGN REVIEW

Project Number

01/11/22 REVIEW

01/24/22 BID SET/

CONSTRUCTION

2021-203


Date January 24, 2022

Sheet Title

OVERALL BUILDING KEY FLOOR PLANS CODE REVIEW

Sheet Number

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ACCESSIBILITY SIGNAGE NOTES:

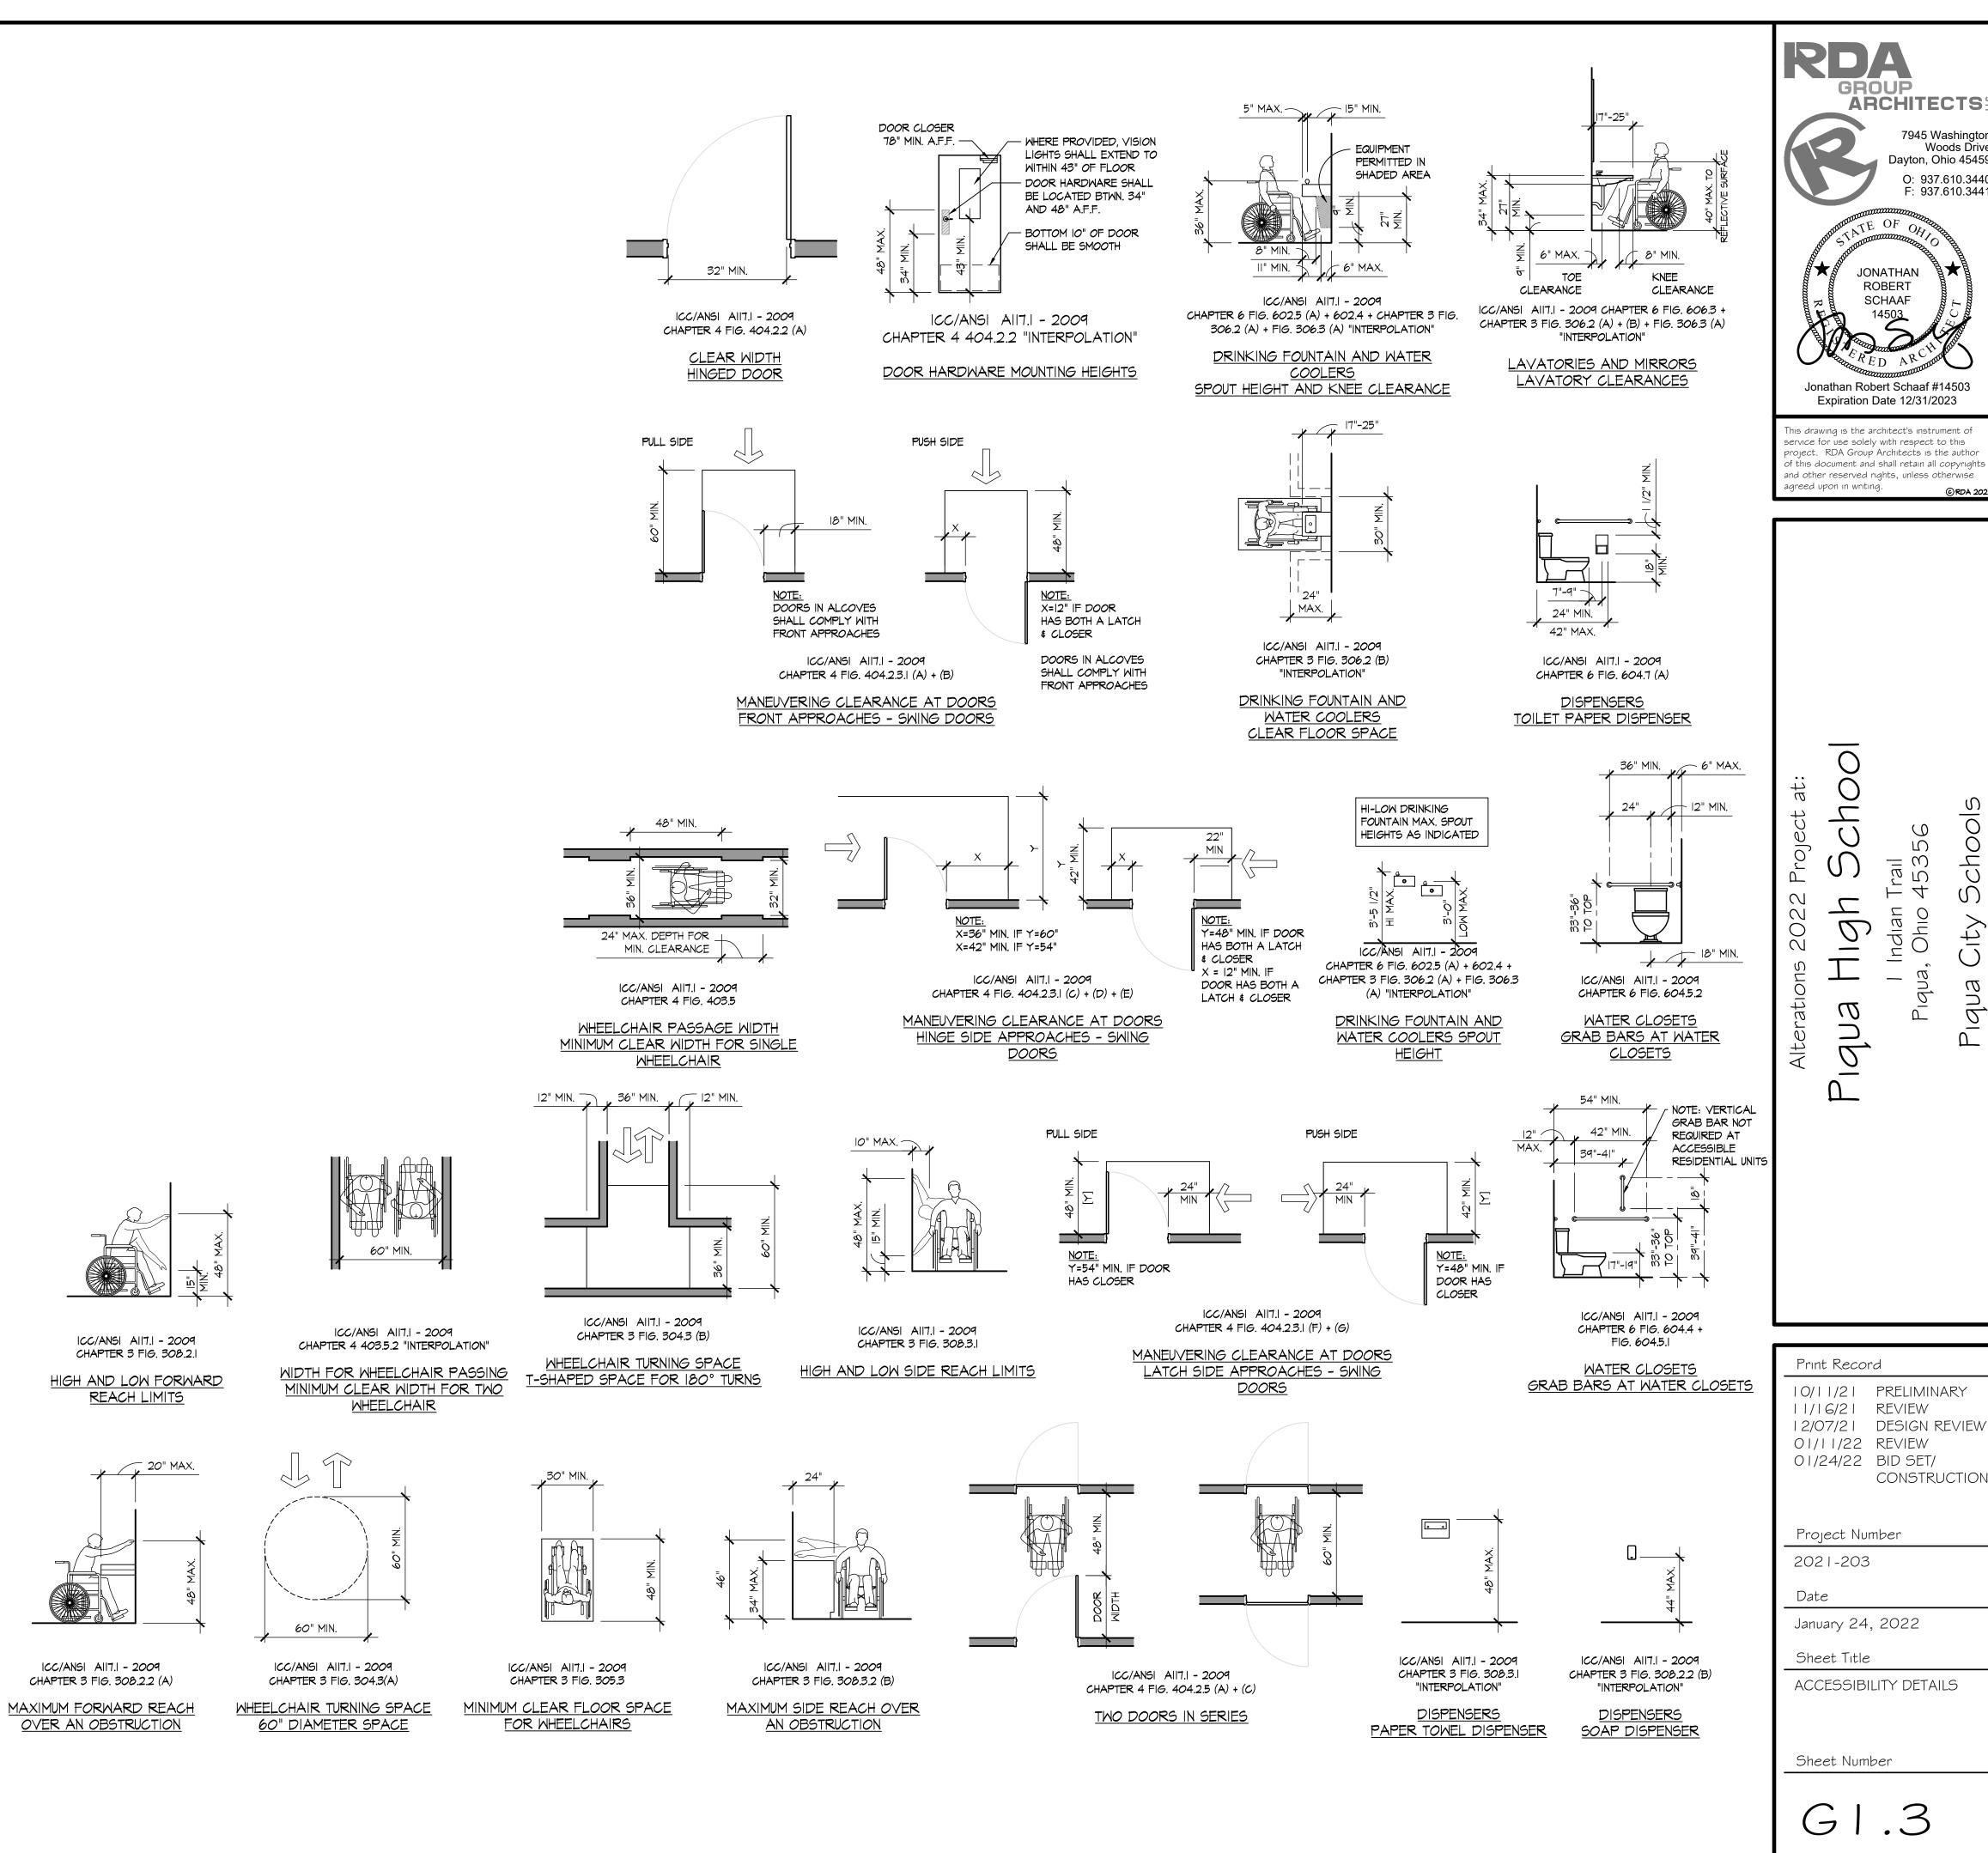LETTERS AND NUMBERS ON SIGNS SHALL HAVE A WIDTH-TO

RAISED AND BRAILLE CHARACTERS AND PICTORIAL SYMBOL SIGNS (PICTOGRAMS):

ACCOMPANIED WITH GRADE BRAILLE. RAISED CHARACTERS

IN. (50 MM). PICTOGRAMS SHALL BE ACCOMPANIED BY THE

THE CHARACTERS AND BACKGROUND OF SIGNS SHALL BE EGGSHELL, MATTE, OR OTHER NON-GLARE FINISH. CHARACTERS AND SYMBOLS SHALL CONTRAST WITH THEIR BACKGROUND WITH EITHER LIGHT CHARACTERS ON A DARK BACKGROUND OR DARK

WHERE PERMANENT IDENTIFICATION IS PROVIDED FOR ROOMS AND SPACES, SIGNS SHALL BE INSTALLED ON THE WALL

ADJACENT TO THE LATCH SIDE OF THE DOOR. WHERE THERE IS NO WALL SPACE TO THE LATCH SIDE OF THE DOOR, INCLUDING AT

ADJACENT WALL. MOUNTING LOCATION FOR SUCH SIGNAGE SHALL BE SO THAT A PERSON MAY APPROACH WITHIN 3 IN. (76 MM) OF

DOUBLE LEAF DOORS, SIGNS SHALL BE PLACED ON THE NEAREST

SIGNAGE WITHOUT ENCOUNTERING PROTRUDING OBJECTS OR

STANDING WITHIN THE SWING OF THE DOOR. MOUNTING HEIGHT

SHALL BE 60 IN. (1525 MM) ABOVE THE FINISH FLOOR TO THE

FACILITIES AND ELEMENTS REQUIRED TO BE IDENTIFIED AS ACCESSIBLE BY SECTION 4.1 OF THE A.D.A.A.G. SHALL USE THE

INTERNATIONAL SYMBOL OF ACCESSIBILITY.

EQUIVALENT VERBAL DESCRIPTION PLACED DIRECTLY BELOW

THE PICTOGRAM. THE BORDER DIMENSION OF THE PICTOGRAM

SHALL BE AT LEAST 5/8 IN. (16 MM) HIGH, BUT NO HIGHER THAN 2

LETTERS AND NUMERALS SHALL BE RAISED 1/32 IN., UPPER CASE,

STROKE-WIDTH-TO-HEIGHT RATIO BETWEEN 1:5 AND 1:10.

SONS SERIF OR SIMPLE SERIF TYPE AND SHALL BE

HEIGHT RATIO BETWEEN 3:5 AND I:1 AND A

SHALL BE 6 IN. (152 MM) MINIMUM OF HEIGHT.

CHARACTERS ON A LIGHT BACKGROUND.

CHARACTER PROPORTION:

FINISH AND CONTRAST:

MOUNTING LOCATION AND HEIGHT:

CENTERLINE OF THE SIGN.

SYMBOLS OF ACCESSIBILITY:

ACCESSIBILITY SIGNAGE DETAILS

WOMEN

TOILET ROOM WALL MOUNTED SIGN

MEN

2.72

INTERNATIONAL SYMBOL OF

<u>ACCESSIBILITY</u>

6" MIN

RESTROOM

TOILET ROOM DOOR

MOUNTED SIGN

- ACCESSIBLE SIGNAGE

PER OBC III AND

ICC AIIT.I-2009

SECTION 703

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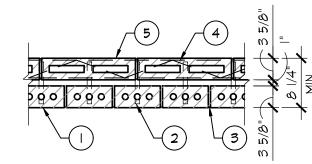
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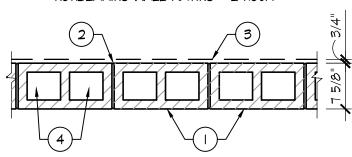
Woods Drive

DESIGN NO. U902 BEARING WALL RATING - 4 HOUR




- I. CLAY FACE BRICKS 3 5/8" WIDE BY 2 1/4" HIGH BY 8" LONG.
- 2. BRICK TIES 3/4" WIDE, 7" LONG CORRUGATED 26 MSG GALVANIZED STEEL. SPACED ONE AT EACH BRICK IN EVERY SECOND COURSE OF BLOCKS.
- 3. MORTAR BRICK AND BLOCKS LAID IN FULL BED OF MORTAR NOM. 3/8" THICK OF NOT LESS THAN 2-1/4 AND NOT MORE THAN 3-1/2 PARTS CLEAN SHARP SAND TO I PART PORTLAND CEMENT AND NOT MORE THAN 50 PERCENT HYDRATED LIME. VERTICAL JOINTS STAGGERED.
- REINFORCEMENT PARALLEL AND DIAGONAL RODS, O.150" MIN. DIAMETER WITH WELDED JOINTS A MAX. 16" O.C. PLACED THE WIDTH OF CONCRETE BLOCK WALL IN EVERY SECOND COURSE OF BLOCKS ALTERNATELY WITH BRICK TIES.
- CONCRETE BLOCKS VARIOUS DESIGNS CLASSIFICATION D-2 [2-h]. SEE CONCRETE BLOCKS CATEGORY FOR LIST OF ELIGIBLE MANUFACTURERS.

DESIGN NO. U905 BEARING WALL RATING - 2 HOUR NONBEARING WALL RATING - 2 HOUR



- CONCRETE BLOCKS VARIOUS DESIGNS. CLASSIFICATION D-2 (2HOUR).
- MORTAR BLOCKS LAID IN FULL BED OF MORTAR, NOM. 3/8" THICK, OF NOT LESS THAN 2 1/4 AND NOT MORE THAN 3 1/2 PARTS OF CLEAN SHARP SAND TO 1 PART PORTLAND CEMENT (PROPORTIONED BY VOLUME) AND NOT MORE THAN 50 PERCENT HYDRATED LIME (BY CEMENT VOLUME). VERTICAL JOINTS STAGGERED.
- PORTLAND CEMENT STUCCO OR GYPSUM PLASTER ADD 1/2 HOUR TO CLASSIFICATION IF USED. WHERE COMBUSTIBLE MEMBERS ARE FRAMED IN WALL PLASTER OR STUCCO MUST BE APPLIED ON THE FACE OPPOSITE FRAMING TO ACHIEVE A MAX. CLASSIFICATION OF I 1/2 HOUR. ATTACHED TO CONCRETE BLOCKS (ITEM I).
- LOOSE MASONRY FILL IF ALL CORE SPACES ARE FILLED WITH LOOSE DRY EXPANDED SLAG, EXPANDED CLAY OR SHALE (ROTARY KILN PROCESS), WATER REPELLANT VERMICULITE MASONRY FILL INSULATION, OR SILICONE TREATED PERLITE LOOSE FILL INSULATION ADD 2 HOUR TO CLASSIFICATION.
- 5. FOAMED PLASTIC* (OPTIONAL NOT SHOWN) 1 1/2" THICK MAX., 4' WIDE SHEATHING ATTACHED TO CONCRETE BLOCKS (ITEM I)
- 5A. BUILDING UNITS AS AN ALTERNATE TO ITEM 5, MIN. I" THICK POLYISOCYANURATE COMPOSITE FOAMED PLASTIC INSULATION BOARDS, NOM. 48" x 48" x 96".


DESIGN NO. U906 BEARING WALL RATING - 2 HOUR

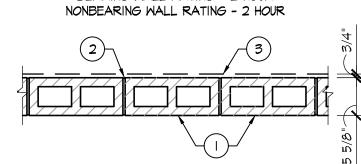



- CONCRETE BLOCKS NOMINAL 6 BY 8 BY 16 IN, HOLLOW OR SOLID. VARIOUS DESIGNS CLASSIFICATION D-2 (2HOUR).
- 2. MORTAR BLOCKS LAID IN FULL BED OF MORTAR, NOM. 3/8" THICK, OF NOT LESS THAN 2 1/4 AND NOT MORE THAN 3 1/2 PARTS OF CLEAN SHARP SAND TO 1 PART PORTLAND CEMENT (PROPORTIONED BY VOLUME) AND NOT MORE THAN 50 PERCENT HYDRATED LIME (BY CEMENT VOLUME). VERTICAL JOINTS STAGGERED.
- PORTLAND CEMENT STUCCO OR GYPSUM PLASTER ADD 1/2 HOUR TO CLASSIFICATION IF USED. WHERE COMBUSTIBLE MEMBERS ARE FRAMED IN WALL PLASTER OR STUCCO MUST BE APPLIED ON THE FACE OPPOSITE FRAMING TO ACHIEVE A MAX. CLASSIFICATION OF 1 1/2 HOUR. ATTACHED TO CONCRETE BLOCKS
- FOAMED PLASTIC* (OPTIONAL NOT SHOWN) 1 1/2" THICK MAX., 4' WIDE SHEATHING ATTACHED TO CONCRETE BLOCKS (ITEM I)
- 4A. <u>BUILDING UNITS</u> AS AN ALTERNATE TO ITEM 5, MIN. I" THICK POLYISOCYANURATE COMPOSITE FOAMED PLASTIC INSULATION BOARDS, NOM. 48" x 48" x 96".


NEW 60 MINUTE FIRE RESISTANCE RATED ALUMINUM STOREFRONT SYSTEM PER MANUFACTURER D-H-T-W-60 RATED GLAZING WINDOW PANEL, TEMPERED | M-I | FIRE RATED GLASS WALL


- 6" CMU WALL

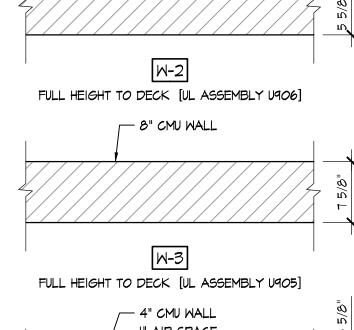

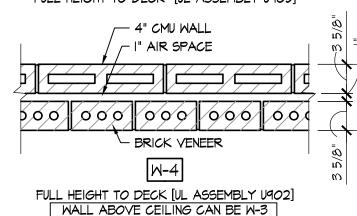

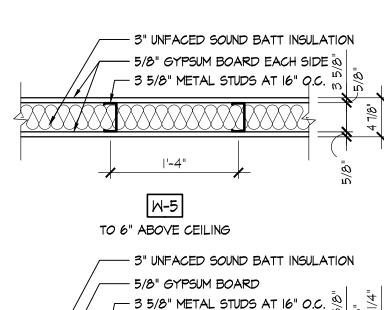


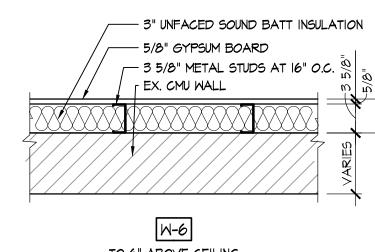

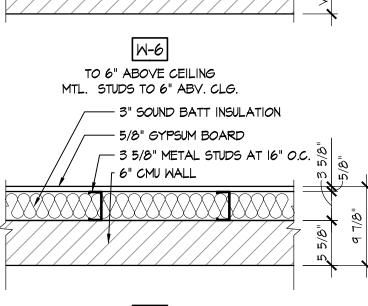


CMU FULL HEIGHT TO DECK MTL. STUDS TO 6" ABV. CLG.

SCALE: |" = |'-0"

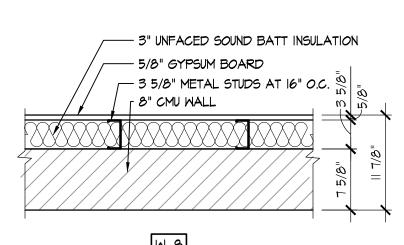


CMU FULL HEIGHT TO DECK [UL ASSEMBLY U905] MTL. STUDS TO 6" ABV. CLG.

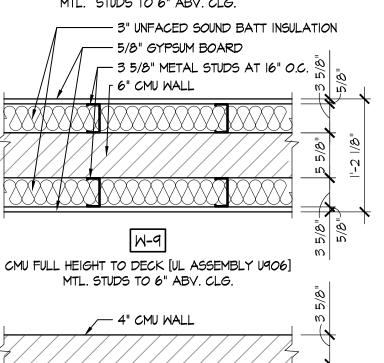


EXISTING CMU WALL

CMU TO ONE COURSE ABOVE CEILING

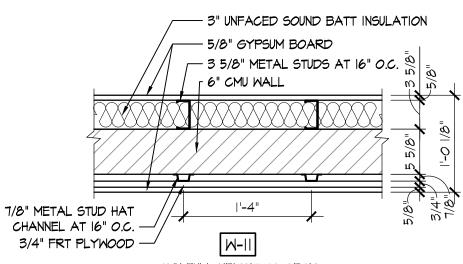

CMU FULL HEIGHT TO DECK MTL. STUDS TO 6" ABV. CLG.

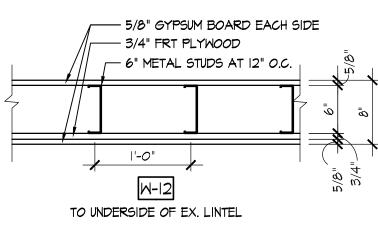

NOTE: MATCH WALL THICKNESS OF EX. MASONRY WALL ABOVE

DIVISION I - GENERAL PROJECT REQUIREMENTS

I.I. TRASH / DEBRIS: I.I.I. CONTRACTOR SHALL PROVIDE ALL REQUIRED TRASH DUMPSTERS, HAULING, ETC. AS REQ'D

FOR THE PROJECT. LOCATE IN A LOCATION APPROVED BY OWNER. I.I.2. THE JOB SITE IS TO BE KEPT CLEAN DURING CONSTRUCTION. CONTRACTOR SHALL PERIODICALLY AND PROMPTLY REMOVE ALL DEBRIS FROM SITE AT THEIR EXPENSE IN A LEGAL MANNER. INCLUSIVE OF ALL BOXES, CRATES, OR TRASH OF INSTALLED ITEMS, INCLUDING DISPLAY FIXTURES AND HARDWARE SUPPLIED BY THE CONTRACTOR OR OTHERS.

1.1.3. FINAL CLEANING: PROVIDE FINAL CLEANING PRIOR TO FINAL INSPECTION. I.2. PROJECT STAGING AREA: AT OWNER DIRECTION

I.3. CONTRACTOR SHALL FOLLOW APPLICABLE GENERAL CONDITIONS REQUIREMENTS AS ESTABLISHED ON THE LATEST EDITION OF AIA DOCUMENT A-201.

1.4.1. THE CONTRACTOR SHALL BE RESPONSIBLE FOR CONSTRUCTION SAFETY; COMPLIANCE TO BE IN ACCORDANCE WITH ALL STATE, FEDERAL, AND O.S.H.A. REGULATIONS. THE ARCHITECT AND THE CONTRACTORS ARE NOT RESPONSIBLE FOR ANY DAMAGES RESULTING FROM THE NEGLECT OF TIMELY AND RESPONSIBLE MAINTENANCE OF THE PROJECT BY THE OWNER AFTER PROJECT COMPLETION.

I.4.2. ALL FIRE EXITS ARE TO REMAIN CLEAR AND OPEN DURING ALL PHASES OF CONSTRUCTION IF APPLICABLE.

1.4.3. TEMPORARY PROTECTION / BARRICADES: ERECT ALL NECESSARY TEMPORARY PROTECTION AND BARRICADES TO ALLOW CONTINUED USE OF THE FACILITY. COORDINATE WITH OWNER AS NECESSARY.

1.4.4. FIRE PREVENTION: PROVIDE FIRE EXTINGUISHERS AT THE JOBSITE. 1.4.4.1. PROVIDE FIRE WATCH FOR ALL HOT WORK ACTIVITIES INCLUDING CUTTING, WELDING, AND OTHER CONSTRUCTION OPERATIONS THAT ARE CAPABLE OF

1.5. PRODUCTS:

1.5.1. CONTRACTOR TO INSTALL ALL MATERIALS, APPLIANCES, ETC. ACCORDING TO MANUFACTURERS SPECIFICATIONS, RECOMMENDATIONS, AND INSTRUCTIONS, WHETHER A COMPLETE SYSTEM OR A COMPONENT PART OF A COMPLETE CONSTRUCTION SYSTEM. 1.5.2. ALL FINAL FINISHES AND SELECTIONS SHALL BE COORDINATED WITH THE PROJECT TEAM.

COORDINATE ALL REQUIREMENTS OF FINISH SELECTIONS, AND CORRELATION BETWEEN FINISHES, TRIM COMPONENTS, ETC. PROVIDE MOCKUPS OF WORK/FINISHES AS APPLICABLE TO ENSURE CONFORMANCE WITH THE DESIGN INTENT. ALL WORK, FINISHES, FIXTURES, AND ACCESSORIES SHALL BE IN FULL COMPLIANCE WITH

ADAAG/ANSI REQUIREMENTS. ENSURE THAT ALL MATERIALS AND ACCESSORIES ARE PROVIDED TO ENSURE COMPLIANCE. 1.5.4. ITEMS MAY BE REFERRED TO AS SINGULAR, OR PLURAL ON THE DRAWINGS AND

SPECIFICATIONS CONTRACTOR IS RESPONSIBLE FOR DETERMINING QUANTITY OF EACH ITEM REQUIRED.

I.6. PERMITS: I.6.I. ALL WORK SHALL CONFORM TO THE 2017 OHIO BUILDING CODE, AND ALL OTHER LOCAL GOVERNING CODES AND ORDINANCES HAVING THE AUTHORITY BEARING ON THE PERFORMANCE OF THE WORK, AND SHALL BE COMPLETED TO THE HIGHEST STANDARDS OF CRAFTSMANSHIP BY EACH RESPECTIVE TRADE. CONTRACTOR SHALL PAY FOR ALL REQUIRED PERMITS. WORK SHALL NOT BEGIN UNTIL ALL NECESSARY PERMITS ARE OBTAINED

1.6.2. THE GENERAL CONTRACTOR SHALL VERIFY ALL PERMITS HAVE BEEN APPROVED BY APPROPRIATE AGENCIES PRIOR TO START OF CONSTRUCTION. NO CONSTRUCTION OR FABRICATION OF ANY ITEMS SHALL BEGIN UNTIL THE CONTRACTOR HAS RECEIVED ALL PLANS AND ANY DOCUMENTATION FROM ALL OF THE PERMITTING AND REGULATORY AUTHORITIES. FAILURE OF THE CONTRACTOR TO FOLLOW THIS PROCEDURE SHALL CAUSE THE CONTRACTOR TO ASSUME FULL RESPONSIBILITY FOR ANY SUBSEQUENT MODIFICATION OF THE WORK MANDATED BY AN REGULATORY AUTHORITY.

THE ARCHITECT SHALL NOT BE RESPONSIBLE FOR ADDITIONAL CONSTRUCTION COST RESULTING FROM WORK STARTED PRIOR TO OBTAINING ALL GOVERNING AGENCIES

I.6.4. IT SHALL BE THE RESPONSIBILITY OF THE GENERAL CONTRACTOR AS HOLDER OF PERMITS TO NOTIFY THE BUILDING OFFICIAL WHEN WORK IS READY FOR INSPECTION. REQUESTS SHALL BE IN ACCORDANCE WITH REQUIREMENTS OF GOVERNING JURISDICTION. INSPECTORS SHALL HAVE COMPLETE ACCESS TO ALL WORK. RECORDS OF INSPECTIONS SHALL BE MAINTAINED ON THE JOB SITE IN ACCORDANCE WITH REQUIREMENTS AND FORMAT OF GOVERNING JURISDICTION. THE CONTRACTOR SHALL BE RESPONSIBLE FOR ALL FEES REQUIRED BY INSPECTIONS, EXCEPT FOR INSPECTIONS MADE BY OWNER OR IT'S AGENTS. I.6.4.I. CONTRACTOR SHALL MAINTAIN A COPY OF APPROVED PERMIT DRAWINGS ON-SITE FOR INSPECTION PURPOSES. COORDINATE WITH BUILDING DEPARTMENT.

1.7.1. THE GENERAL CONTRACTOR IS RESPONSIBLE FOR ALL COORDINATION BETWEEN SUB-CONTRACTORS, SUPPLIERS, AND VENDORS BASED ON THE ENTIRE SET OF DOCUMENTS. NO ADDITIONAL COMPENSATION WILL BE DUE TO A CONTRACTOR FOR ISSUES RESULTING FROM THE USE OF AN INCOMPLETE SET OF CONSTRUCTION DOCUMENTS. THE CONTRACTOR SHALL NOTIFY THE ARCHITECT IMMEDIATELY IN WRITING OF INCONSISTENCIES OR DISCREPANCIES BETWEEN CONTRACT DOCUMENTS, DRAWINGS, SPECIFICATIONS, ETC.

1.7.2. COORDINATION AMONG ALL TRADES IS MANDATORY. ANY COST CHANGES RESULTING FROM THE LACK OF COORDINATION, SHALL BE BORNE BY THE CONTRACTOR CREATING

1.7.3. GENERAL CONTRACTOR SHALL PROVIDE A FULL SET OF CONSTRUCTION DOCUMENTS TO ALL SUBCONTRACTORS. ALL CROSS-REFERENCING SHALL BE THE SOLE RESPONSIBILITY OF THE GENERAL CONTRACTOR.

1.7.4. THE ABBREVIATION N.I.C. INDICATES WORK AND / OR MATERIALS NOT IN THE CONTRACT OF THE GENERAL CONTRACTOR. THIS SHALL NOT RELIEVE THE G.C. OF THE RESPONSIBILITY OF COORDINATION.

I.S. DIMENSIONING CONVENTIONS:

1.8.1. DO NOT SCALE DRAWINGS 1.8.2. CONTRACTOR TO FIELD VERIFY ALL DIMENSIONS & CONDITIONS.

I.8.3. EXISTING WALLS / FINISHES - DIMENSIONED TO FACE OF EXISTING FINISHES.

1.8.4. <u>NEW WALLS</u> - DIMENSIONED TO THE FACE OF CONCRETE, CMU, OR FACE OF STUD I.S.5. REFER TO DRAWINGS NOTES AND DETAILS FOR ANY SPECIAL NOTES THAT GOVERN

DIVISION 2 - EXISTING CONDITIONS

VERIFICATION OF EXISTING CONDITIONS / ACCEPTANCE OF CONDITIONS

I.I.I. DO NOT SCALE DRAWINGS.

CONTRACTOR AND ALL SUBCONTRACTORS ARE RESPONSIBLE FOR VERIFYING ALL DIMENSIONS AND INFORMATION IN THESE DRAWINGS GOVERNING THEIR SCOPE OF THE WORK.

ALL ERRORS, OMISSIONS, AND INCONSISTENCIES IN THESE DRAWINGS WHICH ARE DISCOVERED ARE TO BE REPORTED IN WRITING TO THE ARCHITECT IMMEDIATELY, BEFORE PROCEEDING WITH THE WORK. ANY SITE OR JOB CONDITIONS (INCLUDING ADVERSE SOIL BEARING CONDITIONS) THAT ARISE AND CAUSE THE CONTRACTOR TO VARY FROM THE CONTRACT DOCUMENTS SHALL BE ANALYZED BY AND ARE THE RESPONSIBILITY OF THE CONTRACTOR IF THEY ARE NOT REPORTED TO THE ARCHITECT BEFORE PROCEEDING WITH

THE CONTRACTOR SHALL BE RESPONSIBLE TO FULLY EXAMINE AND BECOME FAMILIAR WITH THE SITE BEFORE COMMENCING THE WORK. THE CONTRACTOR SHALL VERIFY ALL DIMENSIONS AS WELL AS VERIFY THE CONDITIONS AND NATURE OF THE CONSTRUCTION, MATERIALS, AND AVAILABLE UTILITIES AND STRUCTURAL ELEMENTS AND TO NOTIFY THE ARCHITECT IN WRITING OF ANY AND ALL DISCREPANCIES BETWEEN THE SAID EXISTING CONDITIONS AND THE CONTRACT DOCUMENTS.

1.1.5. IT SHALL BE THE JOINT RESPONSIBILITY OF THE GENERAL CONTRACTOR AND ALL SUBCONTRACTORS AND SUPPLIERS OF MATERIALS TO SECURE ALL NECESSARY ADAPTATIONS TO SAME AS REQUIRED FOR THEIR RESPECTIVE WORK PRIOR TO ORDERING, FABRICATION, OR INSTALLATION OF ANY MATERIALS, EQUIPMENT, OR COMPONENTS WHICH ARE TO BE INTEGRATED INTO THE WORK OF THIS PROJECT

THE CONTRACTOR SHALL CONTACT CLIENT, OR THE ARCHITECT OF RECORD, REGARDING ALL QUESTIONS OR DISCREPANCIES. COMMUNICATION WITH THE ARCHITECT'S CONSULTANTS. OR REGULATORY AGENCIES SHALL NOT BE CONSIDERED VALID AND ANY CHANGES IN WORK, ADDITIONAL COSTS, APPROVALS, OR NON APPROVALS DUE TO SUCH COMMUNICATION SHALL BE THE CONTRACTOR'S RESPONSIBILITY. SHOULD ADDITIONAL ENGINEERING OR INVESTIGATIVE WORK BE REQUIRED DUE TO SITE OR ENVIRONMENTAL CONDITIONS, THE CONTRACTOR SHALL NOTIFY THE ARCHITECT IMMEDIATELY. ENGINEERING SERVICES REQUIRED FOR CHANGES OR MODIFICATIONS IN THESE DOCUMENTS SHALL BE SECURED BY

I.I.T. ANY PART OR PARTS OF THE EXISTING BUILDING STRUCTURE (IN PART OR IN WHOLE) THAT SHOWS SIGNS OF ROTTING, VANDALISM, WATER DAMAGE, PEST DAMAGE, OR ANY OTHER DETERIORATION THAT MAY CAUSE THAT PART OR PARTS TO NOT COMPLY WITH ANY EXISTING APPLICABLE GOVERNMENT BUILDING CODES AND STANDARDIZED CONSTRUCTION PRACTICES SHALL BE BROUGHT TO THE ATTENTION OF THE ARCHITECT AND OWNER IMMEDIATELY UPON DISCOVERY.

I.I.S. WHERE NEW CONSTRUCTION IS TO BE SUSPENDED FROM THE EXISTING STRUCTURE, THE GENERAL CONTRACTOR SHALL VERIFY THAT THE EXISTING STRUCTURE HAS THE CAPACITY TO SUPPORT SUCH NEW ASSEMBLIES.

I.2. PROTECTION / CUTTING AND PATCHING: I.2.I. CONTRACTOR SHALL PROTECT EXISTING CONSTRUCTION AND RESTORE ALL FINISH

SURFACES TO THEIR ORIGINAL CONDITION WHERE DAMAGED. 1.2.2. CONTRACTOR SHALL PROVIDE ALL FLOOR LEVELING, PATCHING, AND REMEDIAL REPAIRS AS REQUIRED BY THE SCOPE OF WORK. REPAIRS INCLUDE, BUT ARE NOT LIMITED TO, WORK

SPACES AND TO PREPARE EXISTING SURFACES FOR NEW FINISHES. I.2.3. FIT WORK TIGHT TO ADJACENT ELEMENTS. MAINTAIN INTEGRITY OF WALL, CEILING, AND/OR FLOOR CONSTRUCTION, COMPLETELY SEAL VOIDS.

REFINISH SURFACES TO MATCH ADJACENT FINISHES, UNLESS NOTED OTHERWISE. 1.2.5. CONTRACTOR SHALL PROVIDE AND INSTALL ANY AND ALL ACCESS PANELS AS REQUIRED. CONTRACTOR TO PROVIDE AND / OR MAINTAIN FIRE RATED ASSEMBLIES WHERE SHOWN, OR

REQUIRED TO PROVIDE A SMOOTH AND EVEN TRANSITION BETWEEN NEW AND EXISTING

AS REQUIRED. I.3. SALVAGED ITEMS: AS DIRECTED BY OWNER.

GROUP **ARCHITECTS** 7945 Washingto Woods Drive Dayton, Ohio 45459 O: 937.610.3440 F: 937.610.3441 TE OF . JONATHAN ROBERT SCHAAF 14503 Jonathan Robert Schaaf #14503 Expiration Date 12/31/2023

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Print Record 10/11/21 PRELIMINARY 11/16/21 REVIEW 12/07/21 DESIGN REVIEW

01/11/22 REVIEW

01/24/22 BID SET/

CONSTRUCTION

Project Number 2021-203

Date January 24, 2022

Sheet Title

WALL TYPES

Sheet Number

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UL ASSEMBLIES

NOT THE RESPONSIBILITY OF THE PRODUCT ITSELF.

RATED MASONRY WALL PENETRATION

PENETRATION TYPE

METALLIC CONDUIT

4" POR SMALLER EMT CONDUIT

METALLIC CONDUIT

4"Φ OR SMALLER STEEL CONDUIT

NON-METALLIC CONDUIT

2" POR SMALLER SCHEDULE 40 PVC

METALLIC PIPE/COPPER PIPE/TUBE

4" OR SMALLER TYPE L OR HEAVIER TUBING

METALLIC PIPE/COPPER PIPE/TUBE

4" POR SMALLER REGULAR OR HEAVIER PIPE

NON-METALLIC PIPE/TUBE [OBC 709.6.2]

2" POR SMALLER SCHEDULE 40 PVC/CPVC

NON-METALLIC PIPE/TUBE [OBC 709.6.2]

2"Φ OR SMALLER SCHEDULE 40 PVC/CPVC

CABLE/WIRE W/ NON-COMB. JACKET/INSUL

MAX. 4 COPPER CONDUCTOR NO. 2 AWG

OR SMALLER ALUM OR STEEL

ARMORED/MTL. CLAD CABLE

NON-COMBUSTIBLE PIPES/TUBES/VENTS

6" MAX. TYPE L OR HEAVIER COPPER TUBE

NON-COMBUSTIBLE PIPES/TUBES/VENTS

6" MAX. REGULAR OR HEAVIER COPPER PIPE

NON-COMBUSTIBLE PIPES/TUBES/VENTS

24" MAX. SCH IO OR HEAVIER STEEL PIPE

NON-COMBUSTIBLE PIPES/TUBES/VENTS

24" MAX. CAST OR DUCTILE IRON PIPE

CABLE/WIRE W/ COMBUSTIBLE JACKET/INSUL

MAX. NO. 10 AWG COPPER MULTI CONDUCTOR

[NM] CABLE W/ PVC INSUL MAX 50 PAIR NO. 24

AWG COPPER TELEPHONE CABLE W/ PVC INSUL

COMBUSTIBLE PIPES/TUBES/VENTS

4" MAX. SCH 40 PVC/CPVC [DWV] PIPING

COMBUSTIBLE PIPES/TUBES/VENTS

4" MAX. SCH 40 PVC/ABS/FRPP

COMBUSTIBLE PIPES/TUBES/VENTS

4" PSCH 40 PVC [DWV] PIPING

SCHEDULE 80 POLYPROPYLENE PIPING

2"Φ OR SMALLER

REQUIRED BY INSPECTOR.

CONTRACTOR SHALL VERIFY CONDITIONS AND APPLICABLE THRU

PENETRATION DETAILS. ALL PENETRATIONS IN FIRE RESISTIVE RATED

ASSEMBLIES [WALLS, FLOOR-CEILING, ETC.] SHALL BE APPROPRIATELY

REQUIREMENTS AND PROVIDE ANY ADDITIONAL DOCUMENTATION AS

SEALED IN ACCORDANCE WITH UL ASSEMBLIES. LABEL PENETRATIONS WITH

INSTALLER INFORMATION AND APPLICABLE UL ASSEMBLY PER INSPECTOR

PRODUCTS IDENTIFIED IN THE THRU-PENETRATION ASSEMBLY SCHEDULE ARE

REQUIREMENTS OF THE OHIO BUILDING CODE. BY SIGNING AND SEALING THIS

SELECTION OF THE PROJECT IN MEETING THE REQUIREMENTS OF THE OBC, BUT

IN THE DIRECT RESULT OF THE PRODUCT'S MANUFACTURER IN DESIGNING,

TESTING, AND GAINING APPROVAL FOR THE PRODUCT MEETING THE

DOCUMENT, THE ARCHITECT IS ACCEPTING RESPONSIBILITY FOR THE

LOCATION PENETRATION ASSEMBLY TEST

W-J-1014

W-J-2013

W-J-1020

W-J-2013

W-J-3041

M-J-1031

W-J-2094

W-J-2021

CMU WALLS

U905 & U906

NOTE: ANY ROOF PENETRATIONS SHALL BE COORDINATED WITH RDA PRIOR TO WORK COMMENCING. CONTRACTOR SHALL CONTRACT WITH KREMER ROOFING TO ACCOMPLISH ANY ROOF REPAIR/NEW FLASHING/TIE IN, ETC. ROOF IS CURRENTLY UNDER WARRANTY WITH US PLY & ANY WORK MUST BE ACCOMPLISHED FOLLOWING US PLY DETAILS.

CONTRACTOR SHALL X-RAY SLAB PRIOR TO ANY SAWCUTTING OF EXISTING SLAB. ANY DAMAGE TO EXISTING UNDERSLAB UTILITIES DURING SAWCUTTING SHALL BE REPAIRED/REPLACED AT CONTRACTORS EXPENSE.

> WALK-OFF **V-3**

109

116

117

107

(10)

±10'-6"

DEMOLITION GENERAL NOTES

INCLUDING ANY ANCILLARY ITEMS.

- PROVIDE ALL DEMOLITION REQUIRED BY WORK 2. REMOVE ALL MATERIALS & FINISHES REQUIRED TO PERFORM SCHEDULED WORK
- 3. SALVAGE ALL ITEMS AS DIRECTED BY OWNER OR AS NOTED IN THE DRAWINGS. COORDINATE ALL REQUIREMENTS FOR REINSTALLATION OF SALVAGED ITEMS. PROVIDE REPLACEMENT PARTS/COMPONENTS TO ALLOW COMPLETE INSTALLATION. 4. PROTECT/COVER ALL FINISHES, MATERIALS, ELECTRONICS, & EQUIPMENT SCHEDULED TO REMAIN FROM DAMAGE DURING CONSTRUCTION. CONTRACTOR SHALL REPAIR
- 5. PROVIDE ALL NECESSARY TEMPORARY BRACING AND SHORING DURING DEMOLITION AND CONSTRUCTION WORK.
- 6. REMOVE ALL MISC. ITEMS, CONDUITS, WIRES, ETC. FROM SURFACES & CAVITIES AS REQ'D TO PERFORM WORK. SOME ITEMS INDICATED ON REPAIR FLOOR PLANS ALI5. ALSO REFER TO PME DRAWINGS.
- 7. PROVIDE ALL PREP WORK FOR NEW FINISHES AND PROPOSED WORK.

ANY DAMAGED FINISHES TO LIKE NEW CONDITION.

8. COORDINATE WITH P/M/E DRAWINGS FOR ADDITIONAL DEMOLITION REQUIREMENTS. PROPERLY TERMINATE/ CAP EXISTING UTILITIES BACK TO NEAREST BRANCH AS APPLICABLE.

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- 9. MODIFY EX. FIRE ALARM SYSTEM AS REQUIRED BY WORK. COORD. W/ ELEC. DWGS. WORK TO BE ACCOMPLISHED BY SCHOOL'S PREFERRED VENDOR [SECURCOM] AS PART OF DELEGATED DESIGN
- IO. CONTRACTOR TO FOLLOW ALL APPLICABLE EPA REQUIREMENTS RELATED TO LEAD BASED PAINT FOR RENOVATION, REPAIR, AND PAINTING. MAINTAIN ALL REQUIRED CERTIFICATIONS.
- AFTER REMOVAL OF EX. FLOOR FINISHES, INSPECT & PREP EX. CONC. SLAB AS REQ'D TO PERMIT INSTALL OF NEW FLOOR SYSTEM. VERIFY ALL TRANSITIONS / CONDITIONS BETWEEN FLOORING SYSTEMS. FEATHER / LEVEL UP AS REQ'D FOR A SMOOTH, ACCESSIBLE TRANSITION.
- 12. REMOVE ALL EX. INTERIOR SIGNAGE & WALL MOUNTED ITEMS.
 - 13. REMOVE ALL EX. TACK STRIPS & MISC. WALL MOUNTED ITEMS. REMOVE EX. DATA CABLING TO CEILING LINE AT AREAS OF DEMOLITION - SALVAGE FOR POTENTIAL REUSE, LABEL DEMO LOCATION & ROOM NUMBER. COORDINATE WITH

 - 15. REPAIR/REPOINT EXISTING CMU/MASONRY WALLS AS REQ'D FROM REMOVAL OF WALL MOUNTED ITEMS. F.V. EXACT REQUIREMENTS.
- 16. CONTRACTOR SHALL PROVIDE FILTRATION MEDIA AT RETURN AIR DEVICES TO PROTECT EXISTING DUCTWORK.
- 18. ALL LOOSE FURNITURE, EQUIPMENT, DESKS, LAB TABLES, CHAIRS, FILE CABINETS, ETC. WILL BE REMOVED/RELOCATED BY OWNER PRIOR TO THE START OF WORK.
- 19. ALL EXISTING EQUIPMENT WILL BE REMOVED BY OWNER AT THE BEGINNING OF THE
- 20. REPAIR ALL EXISTING WALL MOLD AT EXISTING ATC WHERE SURFACE MOUNTED
- CONDUITS, PANDUITS, ETC. HAVE BEEN REMOVED.
- 9. REMOVE EXISTING SMART BOARDS. REMOVE PROJECTOR AND TURN OVER TO OWNER. 10. REMOVE EXISTING LOCKERS & WOOD LOCKER BASE COMPLETE.

3. REMOVE EXISTING DOOR, FRAME, & HARDWARE [SALVAGE EX. WOOD DOORS]

5. MODIFY EX. FLOOR CLEAN-OUT, FLOOR DRAIN, ELECTRICAL FLOOR BOX, ETC. HEIGHT

- II. REMOVE EXISTING LOCKERS COMPLETE. MAINTAIN EXISTING LOCKER BASE IN PLACE FOR NEW LOCKERS.
- 12. REMOVE CMU FOR INSTALLATION OF NEW DOOR. SAWCUT & REMOVE SLAB AS REQ'D AT DOOR THRESHOLD. REFER TO DOOR SCHEDULE. REFER TO STRUCTURAL FOR
- 13. NOT USED
- 14. EXISTING BUILDING COLUMN TO REMAIN.

4. EXISTING FLOOR FINISH AND BASE TO REMAIN.

7. REMOVE EXISTING TACKBOARDS.

8. REMOVE EXISTING WINDOW COMPLETE.

AS REQ'D TO ACCOMMODATE NEW FLOOR FINISH.

6. REMOVE EXISTING MARKERBOARDS/CHALKBOARDS.

- 15. REMOVE EXISTING COLUMN. PATCH/REPAIR EXISTING CONCRETE SLAB AS REQ'D TO MATCH EX. ADJACENT SLAB. PREP FOR NEW FLOOR FINISHES.
- 16. EXISTING DOOR TO REMAIN. PREP FOR REPAIR, REFINISHING, & NEW HARDWARE PER


17. REMOVE EX. STOREFRONT DOORS & GLAZING SYSTEM COMPLETE. PREP OPENING AS

- REQ'D FOR NEW STOREFRONT SYSTEM. REFER TO ELECTRICAL FOR ALL ELECTRIC / DATA / SECURITY CABLING SCOPE OF WORK. MOTE: FRP & HM FRAMES. 18. REMOVE EX. SURFACE MOUNTED AND RECESSED ELECTRICAL / DATA DEVICES AS
- INDICATED. COORDINATE WITH ELECTRICAL DRAWINGS. REPAIR / REPLACE CMU 19. REMOVE EXISTING PLUMBING FIXTURES AND ACCESSORIES COMPLETE. TERMINATE/MODIFY/REROUTE EXISTING SUPPLY & SANITARY LINES AS REQ'D BY NEW
- WORK. REFER TO PLUMBING DRAWINGS.
- 20. REMOVE EXISTING DRINKING FOUNTAIN & STAINLESS STEEL WALL PLATE.
- 21. REMOVE EX. CASEWORK/CABINETRY COMPLETE. 22. EXISTING MASONRY WALLS TO REMAIN.
- 23. MODIFY/REPAIR EXISTING WALL/FINISHES TO MEET NEW CMU WALL.
- 24. EXISTING WINDOW TO REMAIN.
- 25. REMOVE EXISTING OPERABLE PARTITION PANELS, TRACK, & ACCESSORIES COMPLETE. PATCH CONCRETE SLAB AND CMU WALLS AS REQ'D. EXISTING BEAM ABOVE TO
- 26. EX. FIRE EXTINGUISHER CABINET TO REMAIN.
- 27. REMOVE ELECTRICAL FLOOR BOXES THIS ROOM. COORDINATE WITH ELECTRICAL
- DRAWINGS. PATCH / REPAIR CONCRETE SLAB AS REQ'D. 28. REMOVE EXISTING PARTIAL HEIGHT CMU WALL.
- 29. REMOVE PLUMBING PIPING. REFER TO PLUMBING DRAWINGS.
- 30. EXISTING ELECTRICAL PANEL. REFER TO ELECTRICAL DRAWINGS.
- 31. REMOVE EXISTING EQUIPMENT AND TURN OVER TO OWNER AS DIRECTED.
- 32. REMOVE EXISTING DEMOUNTABLE PARTITION AND ASSOCIATED HARDWARE COMPLETE.
- 33. REMOVE AND SALVAGE EXISTING BOOKCASES. TURN OVER TO OWNER. 34. SAWCUT & REMOVE EXISTING 5" CONCRETE SLAB THIS AREA AS REQ'D BY NEW
- PLUMBING/ELECTRICAL WORK. REFER TO PME DRAWINGS & SLAB PLAN. LAYOUT
- INDICATED IS SCHEMATIC ONLY F.V. CONDITIONS AND ROUTING AS APPLICABLE. 35. SAWCUT & REMOVE PORTION OF EX. CMU WALL AS INDICATED. REFER TO PROPOSED
- FLOOR PLANS NEW WORK THIS AREA.
- 36. REMOVE EXISTING DISPLAY/TROPHY CASE COMPLETE.
- 37. CONTRACTOR TO PROVIDE TEMPORARY PROTECTION [ZIP WALL] THIS LOCATION. 38. EXISTING GATE TO REMAIN.
- 39. REMOVE EXISTING WALL MOUNTED WALL HEATER AND THERMOSTAT COMPLETE. CAP/TERMINATE UTILITIES AS REQ'D. REFER TO PME DRAWINGS.
- 40. REMOVE EX. DOOR & HARDWARE. EX. FRAME TO REMAIN. PREP FOR NEW DOOR, REFINISHING EX. FRAME, & NEW HARDWARE PER PROPOSED PLANS.
- 41. EXISTING ELEVATOR NO WORK.
- 42. REMOVE EXISTING STEEL WALL MOUNTED HANDRAILS.

HAZARDOUS MATERIALS NOTES


HAZARDOUS MATERIALS MAY EXIST ON THIS PROJECT. IF ANY WORK PERSON ENCOUNTERS ANY MATERIAL WHICH THEY SUSPECT MAY BE HAZARDOUS OR TOXIC, THEY SHALL IMMEDIATELY ADVISE THE OWNER. THE CONTRACTOR SHALL TAKE IMMEDIATE AND APPROPRIATE ACTION TO PROTECT THE BUILDING USERS AND WORKERS IN ACCORDANCE W/ FEDERAL, STATE, AND LOCAL LAWS, CODES AND REGULATIONS. THE ARCHITECT AND ARCHITECT'S CONSULTANTS SHALL HAVE NO RESPONSIBILITY FOR THE DISCOVERY, PRESENCE, HANDLING, REMOVAL OR DISPOSAL OF OR EXPOSURE OF PERSONS TO HAZARDOUS MATERIALS IN ANY FORM AT THE PROJECTS SITE, INCLUDING BUT NOT LIMITED TO $\,$ ASBESTOS, ASBESTOS PRODUCTS POLYCHLORINATED BIPHENYL (PCB) OR OTHER TOXIC SUBSTANCES

- I. THE CONTRACTOR IS HEREBY ADVISED THAT RDA GROUP ARCHITECTS, LLC. IS NOT A DESIGN PROFESSIONAL IN THE DETERMINATION OF THE PRESENCE OF HAZARDOUS MATERIALS, NOR IS RDA A DESIGN PROFESSIONAL INVOLVED IN MAKING RECOMMENDATIONS REGARDING THE TESTING, REMOVAL, ENCAPSULATION OR OTHER CORRECTIVE MEASURES PERTAINING TO HAZARDOUS MATERIALS.
- 2. IF THE WORK WHICH IS TO BE PERFORMED UNDER THE CONTRACT INTERFACES IN ANY WAY W/ THE EXISTING COMPONENTS WHICH CONTAIN HAZARDOUS MATERIALS IT IS THE CONTRACTORS RESPONSIBILITY TO CONTACT THE OWNER'S ENVIRONMENTAL CONSULTANT REGARDING THE PROPER MEANS & METHODS TO BE UTILIZED IN DEALING W/ HAZARDOUS MATERIALS.
- 3. BY EXECUTION OF THE CONTRACT FOR CONSTRUCTION, THE CONTRACTOR HEREBY AGREES TO BRING NO CLAIM FOR NEGLIGENCE, BREACH OF CONTRACT, INDEMNITY OR OTHERWISE AGAINST THE ARCHITECT, HIS PRINCIPLES, EMPLOYEES, AGENTS OR CONSULTANTS IF SUCH A CLAIM IN ANY WAY WOULD INVOLVE THE INVESTIGATION OF OR REMEDIAL WORK RELATED TO HAZARDOUS MATERIALS IN THE PROJECT.
- 4. BY EXECUTION OF THE CONTRACT FOR CONSTRUCTION, THE CONTRACTOR FURTHER AGREES TO DEFEND, INDEMNIFY AND HOLD THE ARCHITECT, HIS PRINCIPLES, EMPLOYEES, AGENTS OR CONSULTANTS HARMLESS FROM ANY SUCH ASBESTOS OF OTHER HAZARDOUS MATERIALS RELATED CLAIMS THAT MAY BE BROUGHT BY THE CONTRACTOR'S SUBCONTRACTORS, SUPPLIERS OR OTHER THIRD PARTIES WHO MAY BE ACTING UNDER THE DIRECTION OF THE CONTRACTOR PURSUANT TO THIS

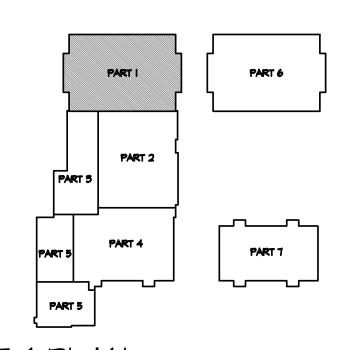

KEY PLAN

NOT TO SCALE

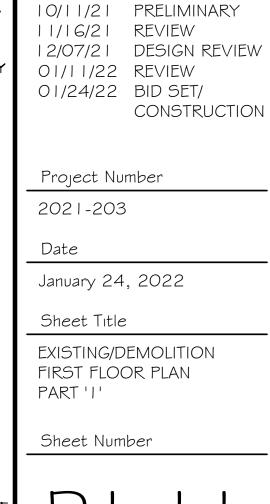

Print Record

GROUP

TE OF .

JONATHAN

ROBERT

SCHAAF

Jonathan Robert Schaaf #14503

Expiration Date 12/31/2023

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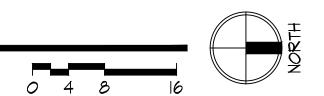
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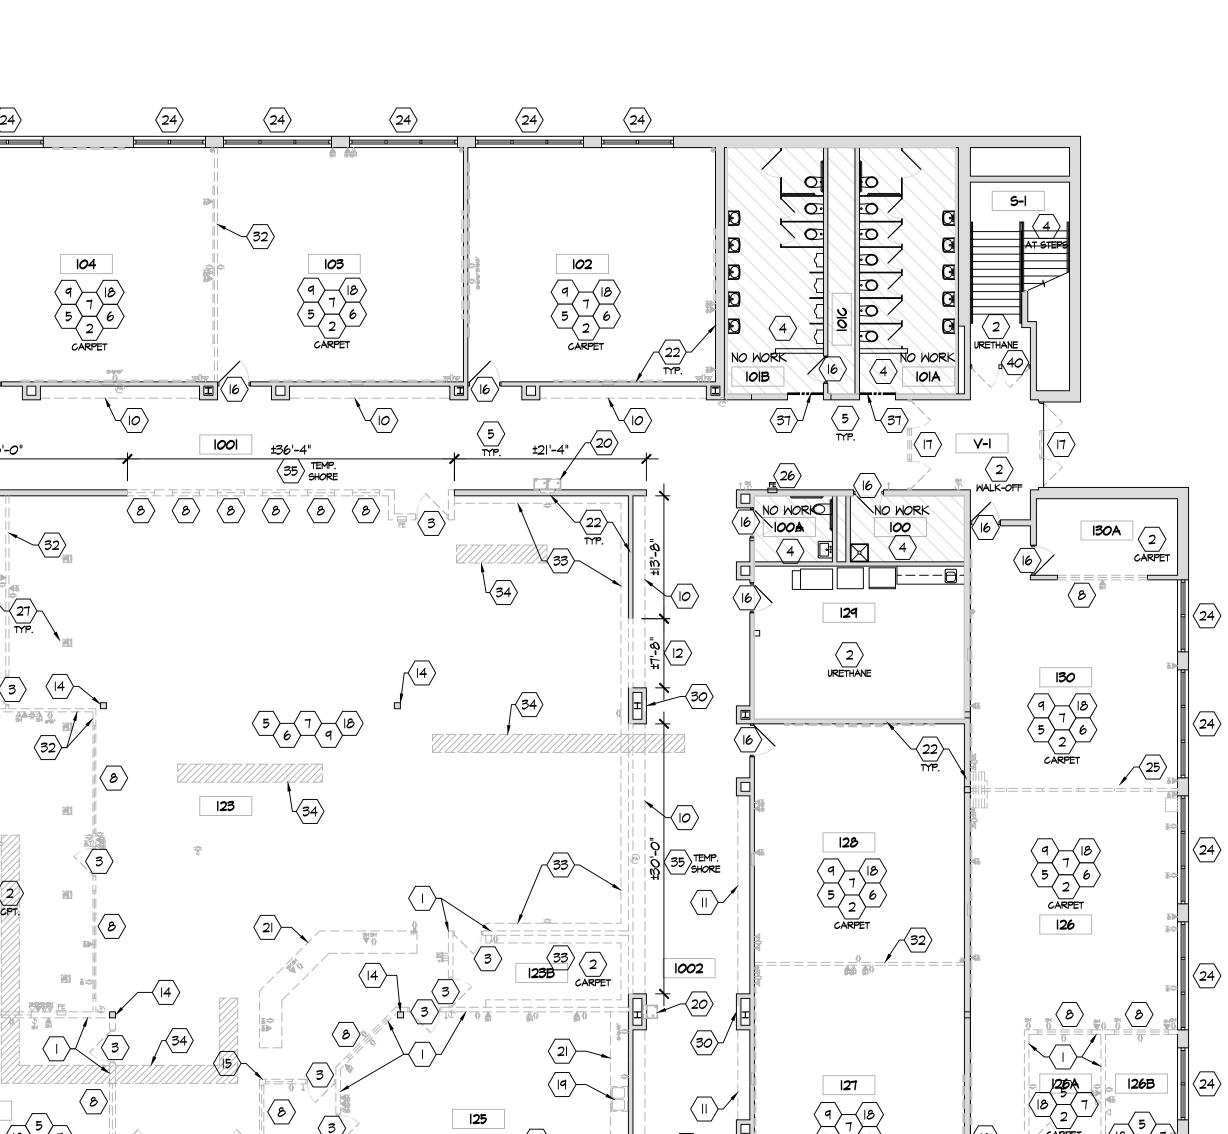


(#) DEMOLITION PLAN KEY NOTES REMOVE CMU WALL COMPLETE AS INDICATED. PATCH WALL SURFACES. PATCH 2. REMOVE EXISTING FLOOR FINISH AND BASE COMPLETE TO CONCRETE SLAB. PREP SLAB AS REQ'D FOR NEW FLOOR FINISH.

OWNER WILL CHANGE OUT ALL AIR FILTERS AT THE COMPLETION OF THE PROJECT.

CONTRACTOR SHALL COORDINATE AS REQ'D.


21. ELECTRICAL DEMOLITION SHOWN FOR REFERENCE ONLY. COORDINATE WITH ELECTRICAL DRAWINGS FOR ADDITIONAL DEMOLITION REQUIREMENTS.



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(#) DEMOLITION RCP KEY NOTES

- 2. EXISTING ACOUSTIC TILE CEILING SYSTEM TO REMAIN. REPLACE ANY DAMAGED
 - CEILING TILES.

REMOVE EXISTING ACOUSTIC TILE CEILING SYSTEM COMPLETE AS INDICATED THIS

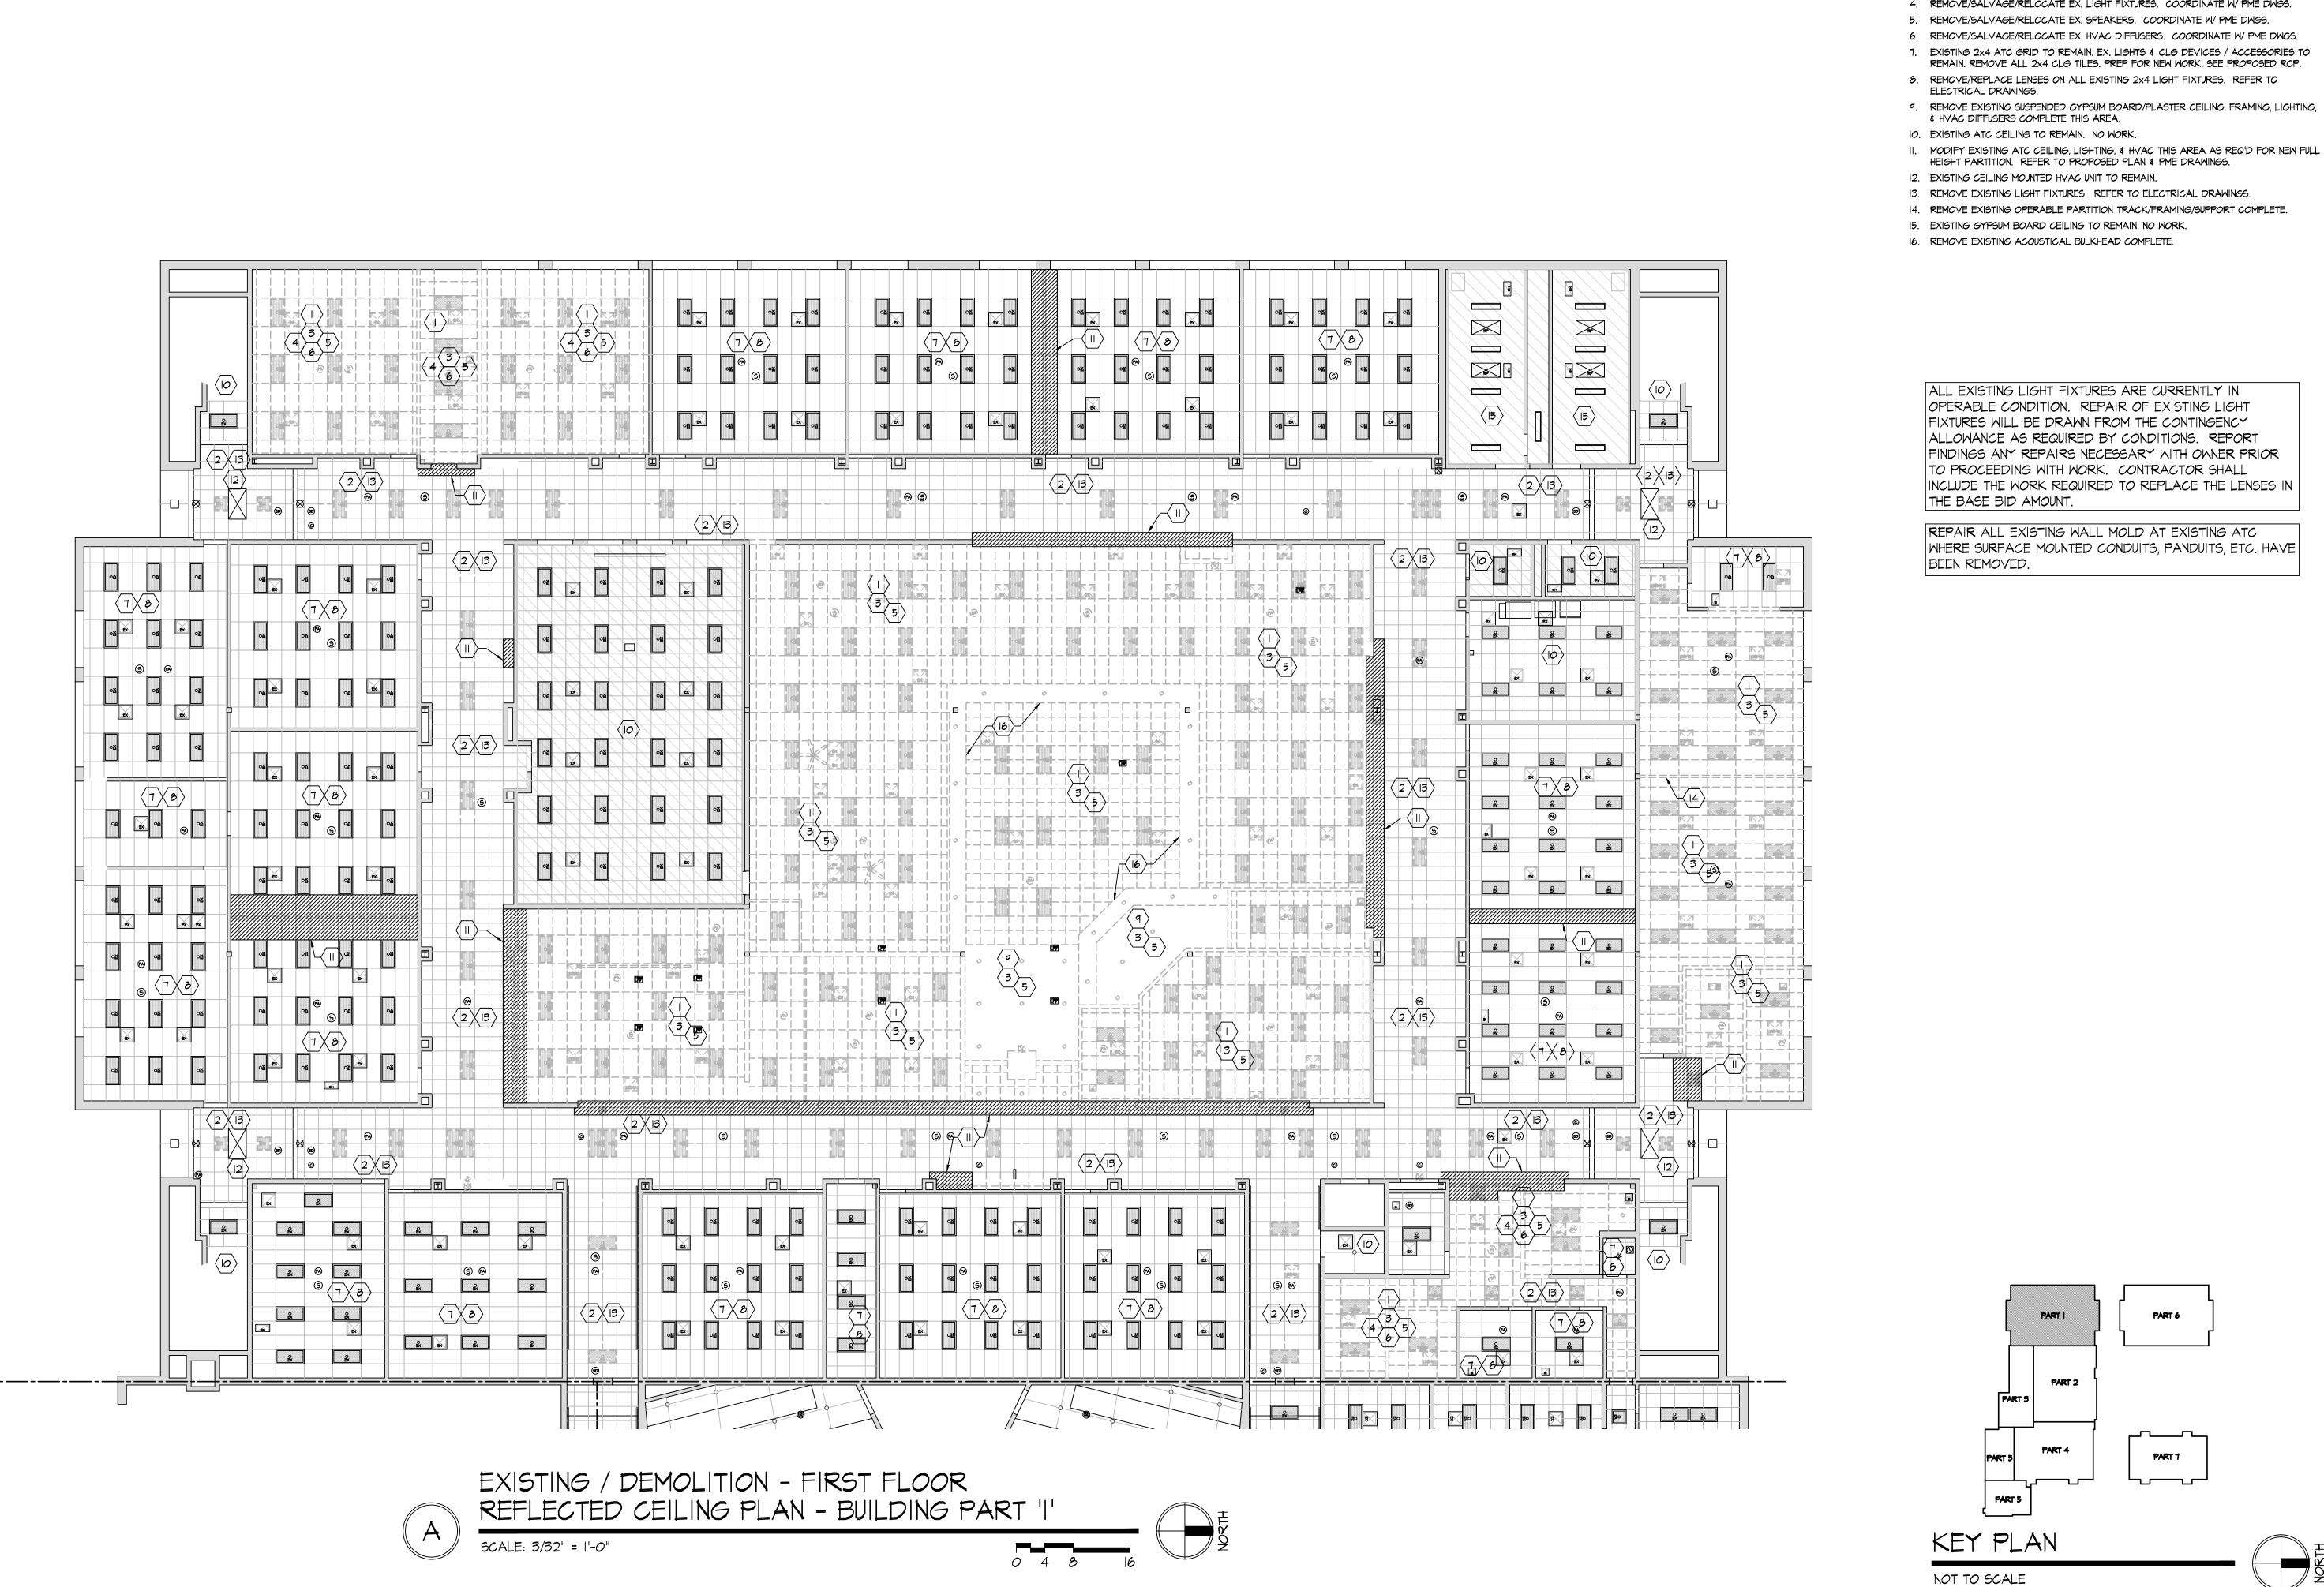- 3. REMOVE/SALVAGE/RELOCATE EX. FIRE ALARM DEVICES. COORDINATE W/ PME DWGS.
- 4. REMOVE/SALVAGE/RELOCATE EX. LIGHT FIXTURES. COORDINATE W/ PME DWGS. 5. REMOVE/SALVAGE/RELOCATE EX. SPEAKERS. COORDINATE W/ PME DWGS.
- 6. REMOVE/SALVAGE/RELOCATE EX. HVAC DIFFUSERS. COORDINATE W/ PME DWGS.
- 7. EXISTING 2x4 ATC GRID TO REMAIN. EX. LIGHTS & CLG DEVICES / ACCESSORIES TO REMAIN. REMOVE ALL 2x4 CLG TILES. PREP FOR NEW WORK. SEE PROPOSED RCP.
- 8. REMOVE/REPLACE LENSES ON ALL EXISTING 2x4 LIGHT FIXTURES. REFER TO ELECTRICAL DRAWINGS. 9. REMOVE EXISTING SUSPENDED GYPSUM BOARD/PLASTER CEILING, FRAMING, LIGHTING,
- # HVAC DIFFUSERS COMPLETE THIS AREA. IO. EXISTING ATC CEILING TO REMAIN. NO WORK
- HEIGHT PARTITION. REFER TO PROPOSED PLAN & PME DRAWINGS.
- 12. EXISTING CEILING MOUNTED HVAC UNIT TO REMAIN.
- 13. REMOVE EXISTING LIGHT FIXTURES. REFER TO ELECTRICAL DRAWINGS.
- 14. REMOVE EXISTING OPERABLE PARTITION TRACK/FRAMING/SUPPORT COMPLETE.
- 15. EXISTING GYPSUM BOARD CEILING TO REMAIN. NO WORK.
- 16. REMOVE EXISTING ACOUSTICAL BULKHEAD COMPLETE.





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ALL EXISTING LIGHT FIXTURES ARE CURRENTLY IN OPERABLE CONDITION. REPAIR OF EXISTING LIGHT FIXTURES WILL BE DRAWN FROM THE CONTINGENCY ALLOWANCE AS REQUIRED BY CONDITIONS. REPORT FINDINGS ANY REPAIRS NECESSARY WITH OWNER PRIOR TO PROCEEDING WITH WORK. CONTRACTOR SHALL INCLUDE THE WORK REQUIRED TO REPLACE THE LENSES IN THE BASE BID AMOUNT.

REPAIR ALL EXISTING WALL MOLD AT EXISTING ATC WHERE SURFACE MOUNTED CONDUITS, PANDUITS, ETC. HAVE BEEN REMOVED.

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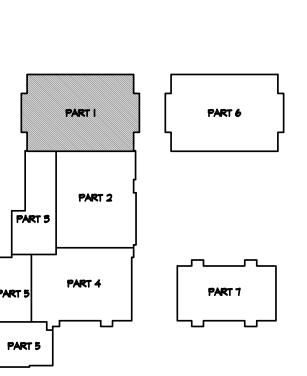
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KEY PLAN

Project Number 2021-203 Date January 24, 2022 Sheet Title

EXISTING/DEMOLITION FIRST FLOOR REFLECTED CEILING PLAN PART 'I'

Sheet Number

Print Record


10/11/21 PRELIMINARY

01/11/22 REVIEW

01/24/22 BID SET/

11/16/21 REVIEW 12/07/21 DESIGN REVIEW

CONSTRUCTION

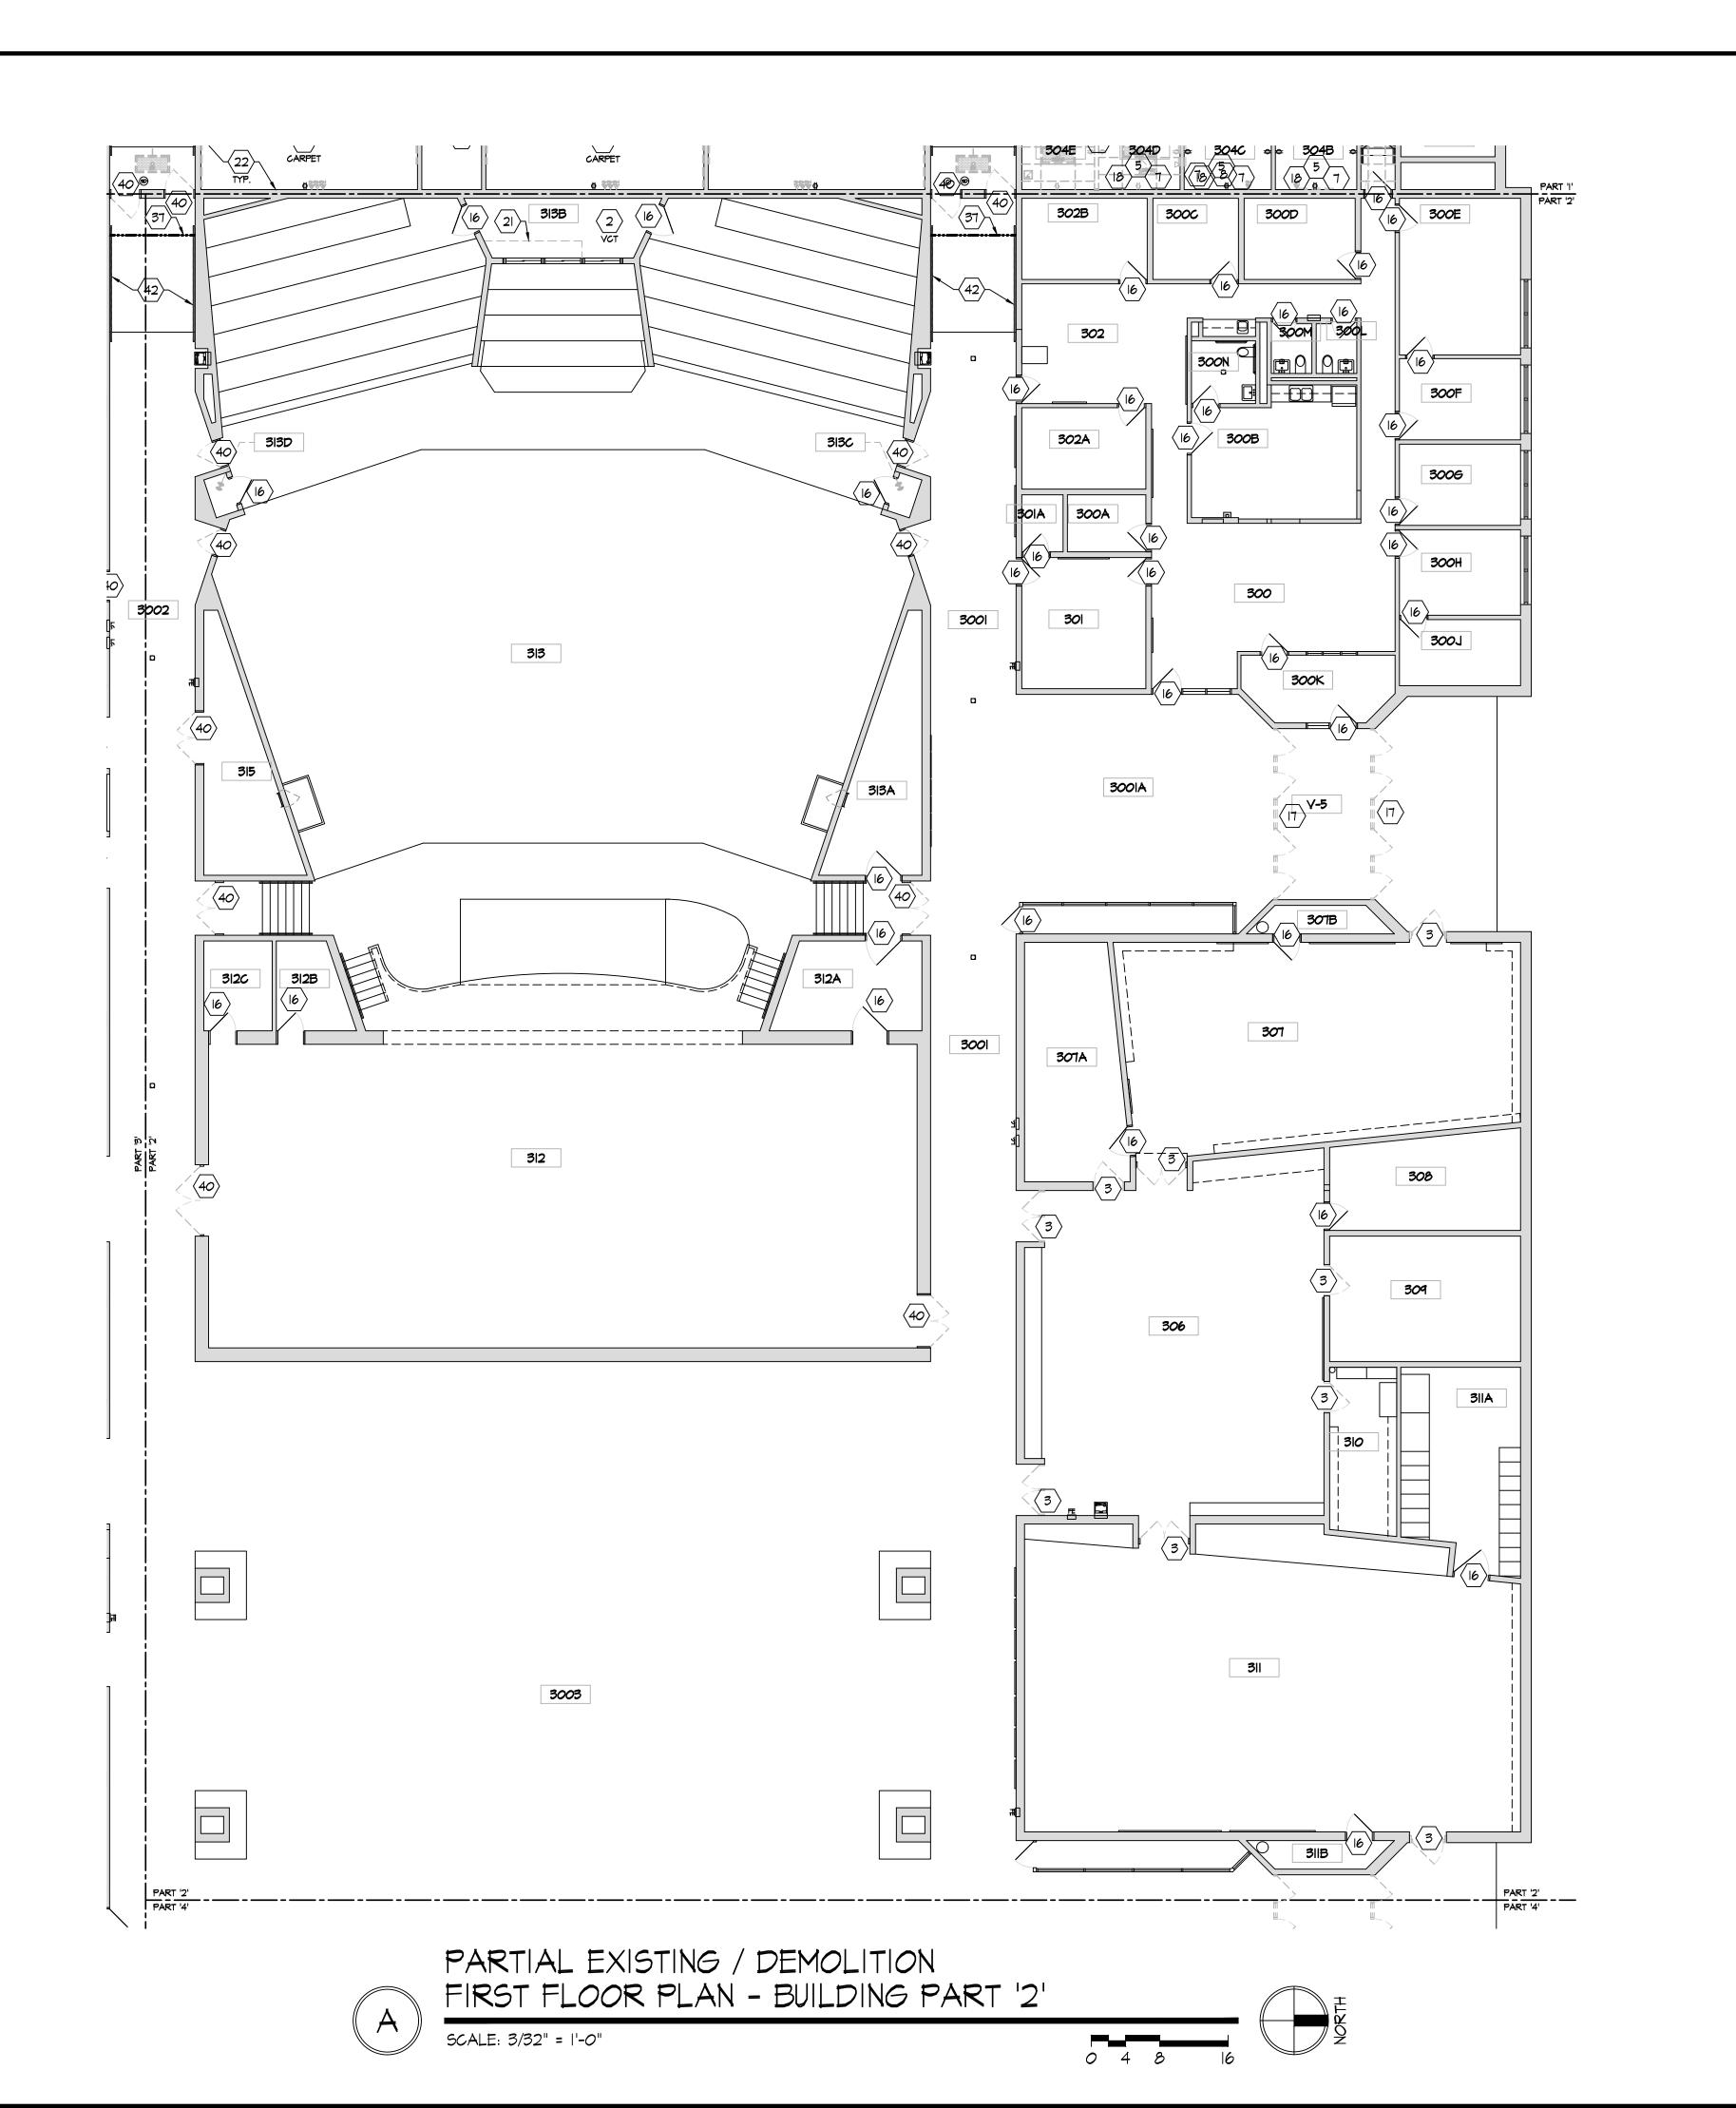

(#) DEMOLITION PLAN KEY NOTES

REMOVE CMU WALL COMPLETE AS INDICATED. PATCH WALL SURFACES. PATCH CONCRETE SLAB AS REQ'D.

- 2. REMOVE EXISTING FLOOR FINISH AND BASE COMPLETE TO CONCRETE SLAB. PREP SLAB AS REQ'D FOR NEW FLOOR FINISH.
- 3. REMOVE EXISTING DOOR, FRAME, & HARDWARE [SALVAGE EX. WOOD DOORS]
- 4. EXISTING FLOOR FINISH AND BASE TO REMAIN.
- 5. MODIFY EX. FLOOR CLEAN-OUT, FLOOR DRAIN, ELECTRICAL FLOOR BOX, ETC. HEIGHT AS REQ'D TO ACCOMMODATE NEW FLOOR FINISH.
- 6. REMOVE EXISTING MARKERBOARDS/CHALKBOARDS.
- 7. REMOVE EXISTING TACKBOARDS.
- 8. REMOVE EXISTING WINDOW COMPLETE.
- 9. REMOVE EXISTING SMART BOARDS. REMOVE PROJECTOR AND TURN OVER TO OWNER. 10. REMOVE EXISTING LOCKERS & WOOD LOCKER BASE COMPLETE.
- II. REMOVE EXISTING LOCKERS COMPLETE. MAINTAIN EXISTING LOCKER BASE IN PLACE FOR NEW LOCKERS.
- 12. REMOVE CMU FOR INSTALLATION OF NEW DOOR. SAWCUT & REMOVE SLAB AS REQ'D AT DOOR THRESHOLD. REFER TO DOOR SCHEDULE. REFER TO STRUCTURAL FOR
- 13. NOT USED
- 14. EXISTING BUILDING COLUMN TO REMAIN.
- 15. REMOVE EXISTING COLUMN. PATCH/REPAIR EXISTING CONCRETE SLAB AS REQ'D TO MATCH EX. ADJACENT SLAB. PREP FOR NEW FLOOR FINISHES.
- 16. EXISTING DOOR TO REMAIN. PREP FOR REPAIR, REFINISHING, & NEW HARDWARE PER


17. REMOVE EX. STOREFRONT DOORS & GLAZING SYSTEM COMPLETE. PREP OPENING AS

- REQ'D FOR NEW STOREFRONT SYSTEM. REFER TO ELECTRICAL FOR ALL ELECTRIC / DATA / SECURITY CABLING SCOPE OF WORK. MOTE: FRP & HM FRAMES. 18. REMOVE EX. SURFACE MOUNTED AND RECESSED ELECTRICAL / DATA DEVICES AS
- INDICATED. COORDINATE WITH ELECTRICAL DRAWINGS. REPAIR / REPLACE CMU 19. REMOVE EXISTING PLUMBING FIXTURES AND ACCESSORIES COMPLETE.
- TERMINATE/MODIFY/REROUTE EXISTING SUPPLY & SANITARY LINES AS REQ'D BY NEW WORK. REFER TO PLUMBING DRAWINGS.
- 20. REMOVE EXISTING DRINKING FOUNTAIN & STAINLESS STEEL WALL PLATE.
- 21. REMOVE EX. CASEWORK/CABINETRY COMPLETE.
- 22. EXISTING MASONRY WALLS TO REMAIN. 23. MODIFY/REPAIR EXISTING WALL/FINISHES TO MEET NEW CMU WALL.
- 24. EXISTING WINDOW TO REMAIN.
- 25. REMOVE EXISTING OPERABLE PARTITION PANELS, TRACK, \$ ACCESSORIES COMPLETE. PATCH CONCRETE SLAB AND CMU WALLS AS REQ'D. EXISTING BEAM ABOVE TO
- 26. EX. FIRE EXTINGUISHER CABINET TO REMAIN.
- 27. REMOVE ELECTRICAL FLOOR BOXES THIS ROOM. COORDINATE WITH ELECTRICAL DRAWINGS. PATCH / REPAIR CONCRETE SLAB AS REQ'D.
- 28. REMOVE EXISTING PARTIAL HEIGHT CMU WALL.
- 29. REMOVE PLUMBING PIPING. REFER TO PLUMBING DRAWINGS.
- 30. EXISTING ELECTRICAL PANEL. REFER TO ELECTRICAL DRAWINGS.
- 31. REMOVE EXISTING EQUIPMENT AND TURN OVER TO OWNER AS DIRECTED.
- 32. REMOVE EXISTING DEMOUNTABLE PARTITION AND ASSOCIATED HARDWARE COMPLETE.
- 33. REMOVE AND SALVAGE EXISTING BOOKCASES. TURN OVER TO OWNER.
- 34. SAWCUT & REMOVE EXISTING 5" CONCRETE SLAB THIS AREA AS REQ'D BY NEW
- PLUMBING/ELECTRICAL WORK. REFER TO PME DRAWINGS & SLAB PLAN. LAYOUT INDICATED IS SCHEMATIC ONLY - F.V. CONDITIONS AND ROUTING AS APPLICABLE.
- 35. SAWCUT & REMOVE PORTION OF EX. CMU WALL AS INDICATED. REFER TO PROPOSED FLOOR PLANS NEW WORK THIS AREA.
- 36. REMOVE EXISTING DISPLAY/TROPHY CASE COMPLETE.
- 37. CONTRACTOR TO PROVIDE TEMPORARY PROTECTION [ZIP WALL] THIS LOCATION. 38. EXISTING GATE TO REMAIN.
- 39. REMOVE EXISTING WALL MOUNTED WALL HEATER AND THERMOSTAT COMPLETE. CAP/TERMINATE UTILITIES AS REQ'D. REFER TO PME DRAWINGS.
- 40. REMOVE EX. DOOR \$ HARDWARE. EX. FRAME TO REMAIN. PREP FOR NEW DOOR, REFINISHING EX. FRAME, & NEW HARDWARE PER PROPOSED PLANS.
- 41. EXISTING ELEVATOR NO WORK.
- 42. REMOVE EXISTING STEEL WALL MOUNTED HANDRAILS.



7945 Washingtor Woods Drive Dayton, Ohio 45459 O: 937.610.3440 F: 937.610.3441

ARCHITECTS

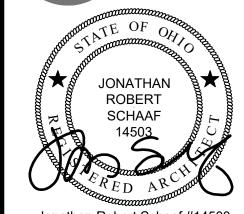

Jonathan Robert Schaaf #14503 Expiration Date 12/31/2023

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CONSTRUCTION

11/16/21 REVIEW

01/11/22 REVIEW 01/24/22 BID SET/

Project Number

January 24, 2022

EXISTING/DEMOLITION FIRST FLOOR PLAN

2021-203


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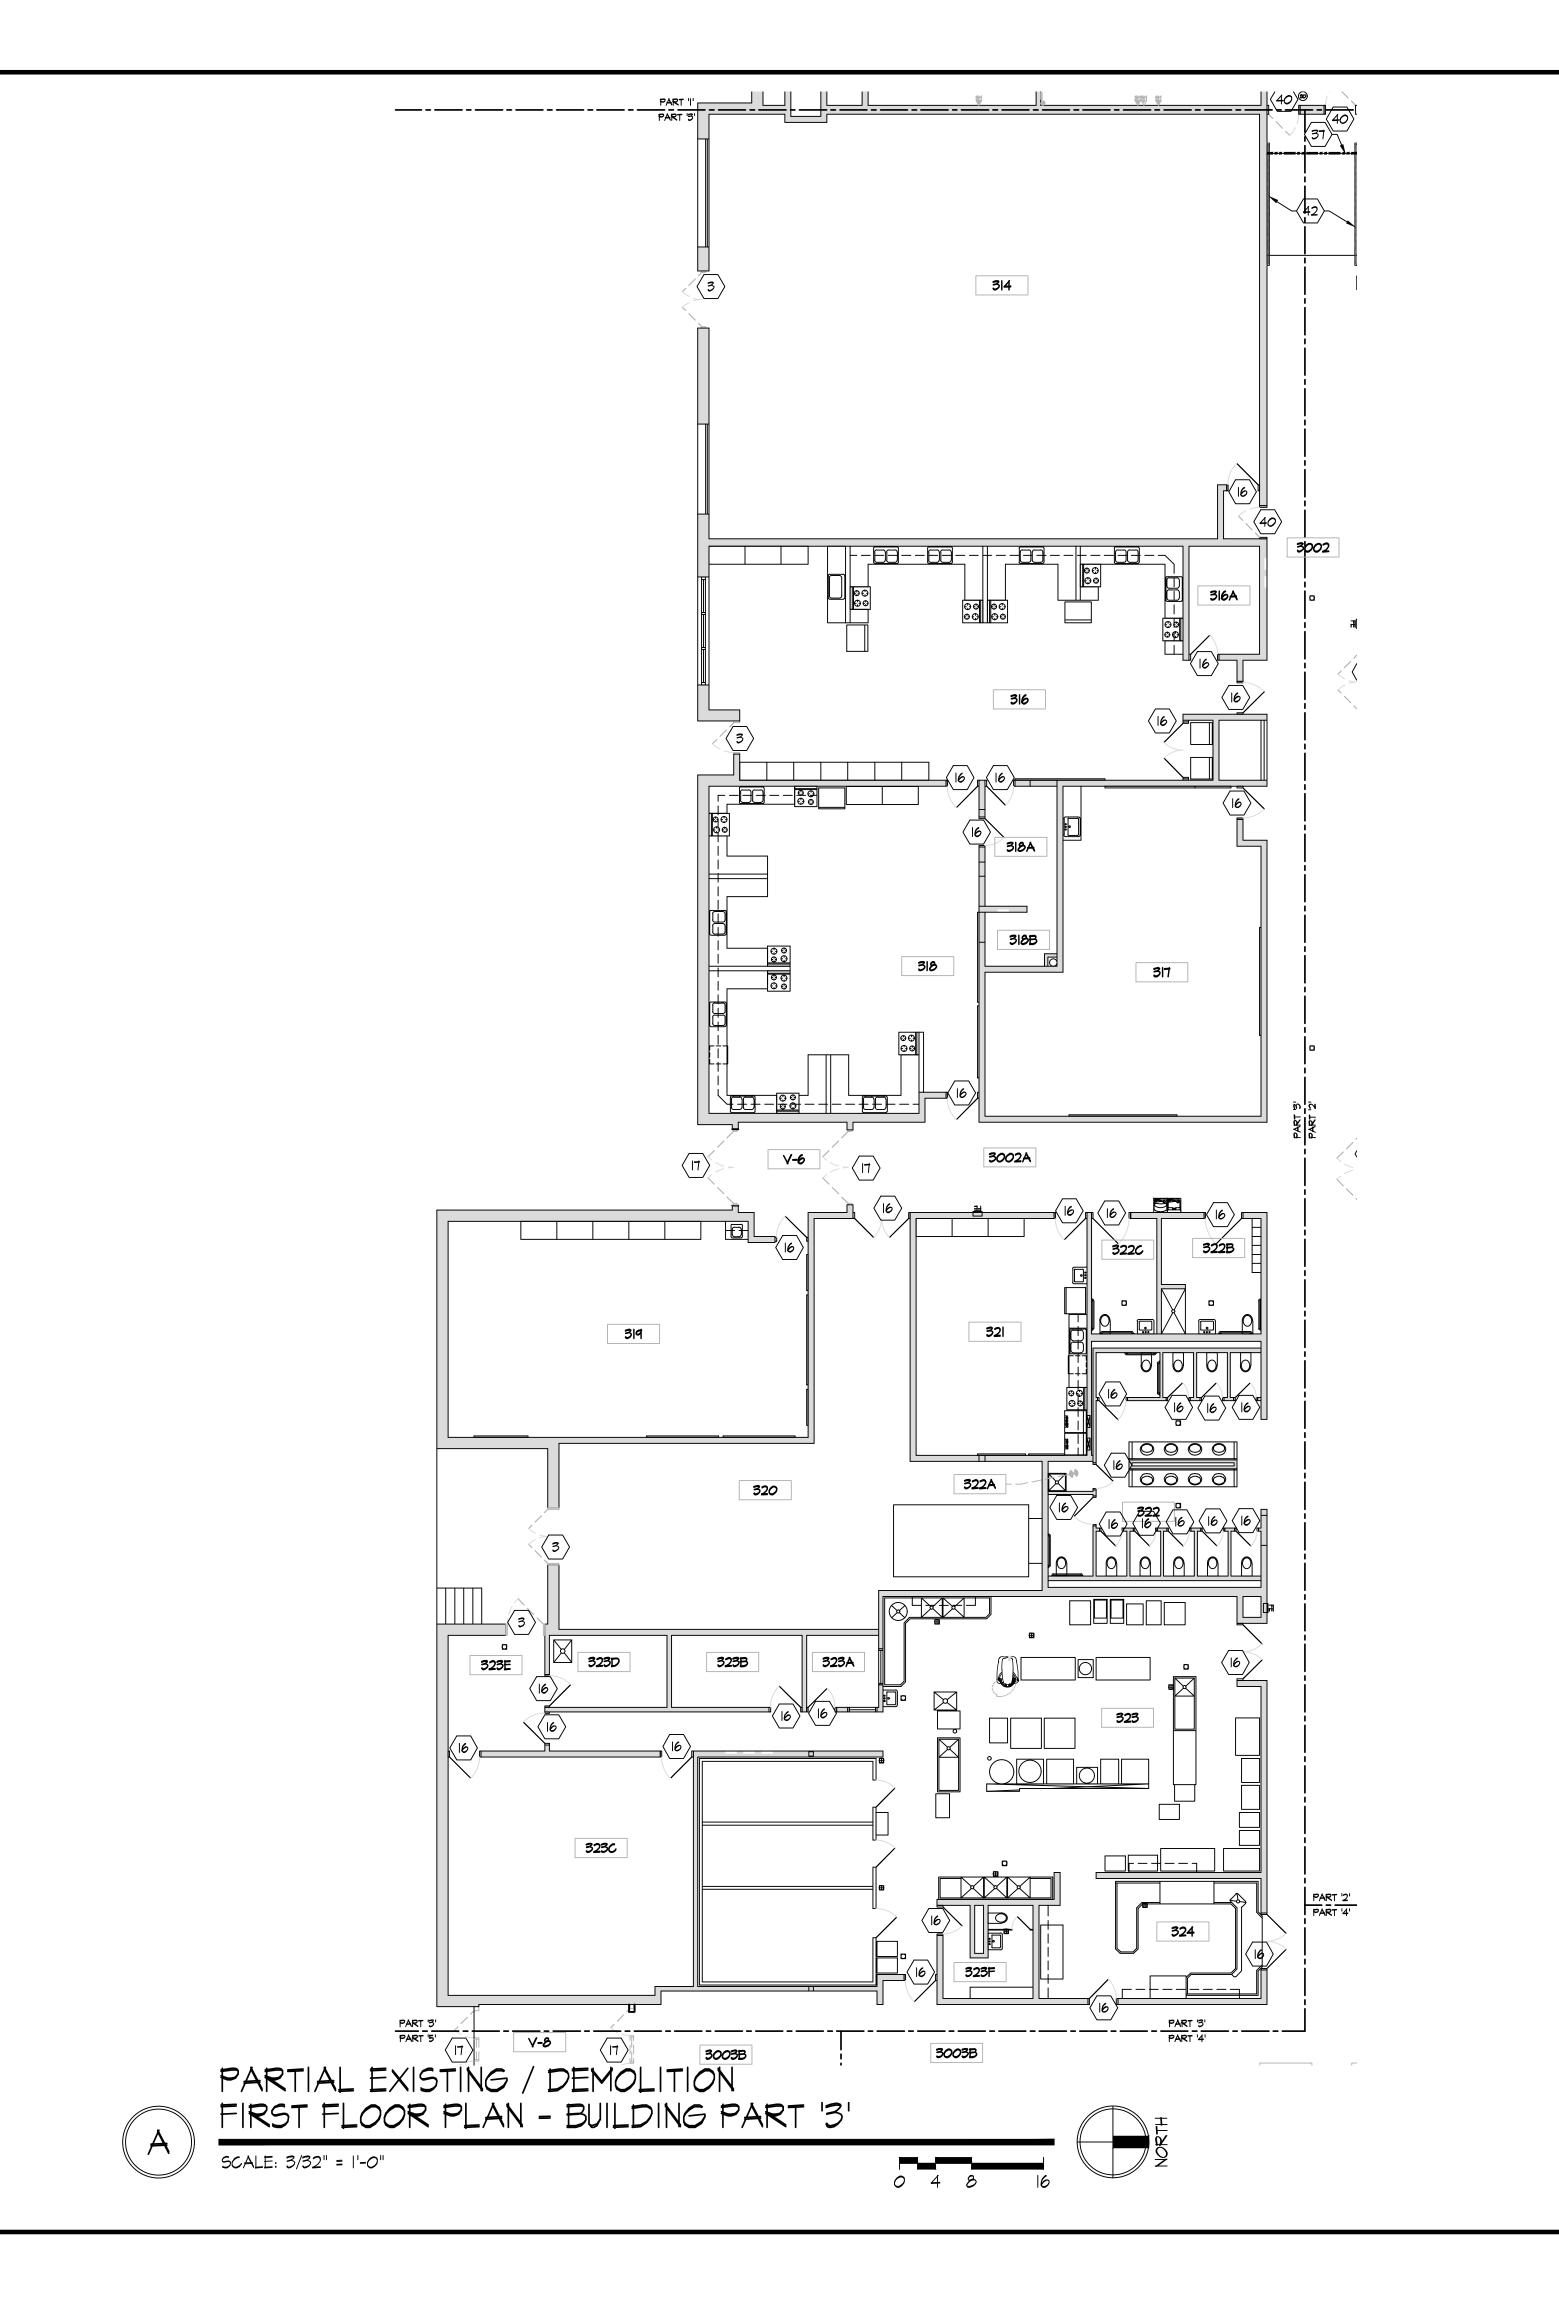
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NOT TO SCALE

PART '2' Sheet Number



(*) DEMOLITION PLAN KEY NOTES

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- 12. REMOVE CMU FOR INSTALLATION OF NEW DOOR. SAWCUT & REMOVE SLAB AS REQ'D AT DOOR THRESHOLD. REFER TO DOOR SCHEDULE. REFER TO STRUCTURAL FOR
- 13. NOT USED
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- 16. EXISTING DOOR TO REMAIN. PREP FOR REPAIR, REFINISHING, & NEW HARDWARE PER
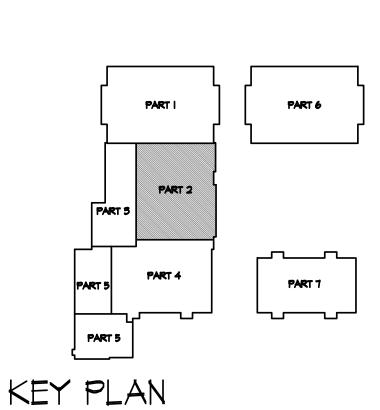
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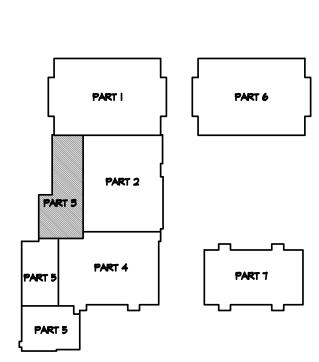
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KEY PLAN

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Sheet Number

Print Record

10/11/21 PRELIMINARY

12/07/21 DESIGN REVIEW

CONSTRUCTION

11/16/21 REVIEW

01/11/22 REVIEW 01/24/22 BID SET/

Project Number

January 24, 2022


EXISTING/DEMOLITION FIRST FLOOR PLAN

2021-203

Sheet Title

PART '3'

Date

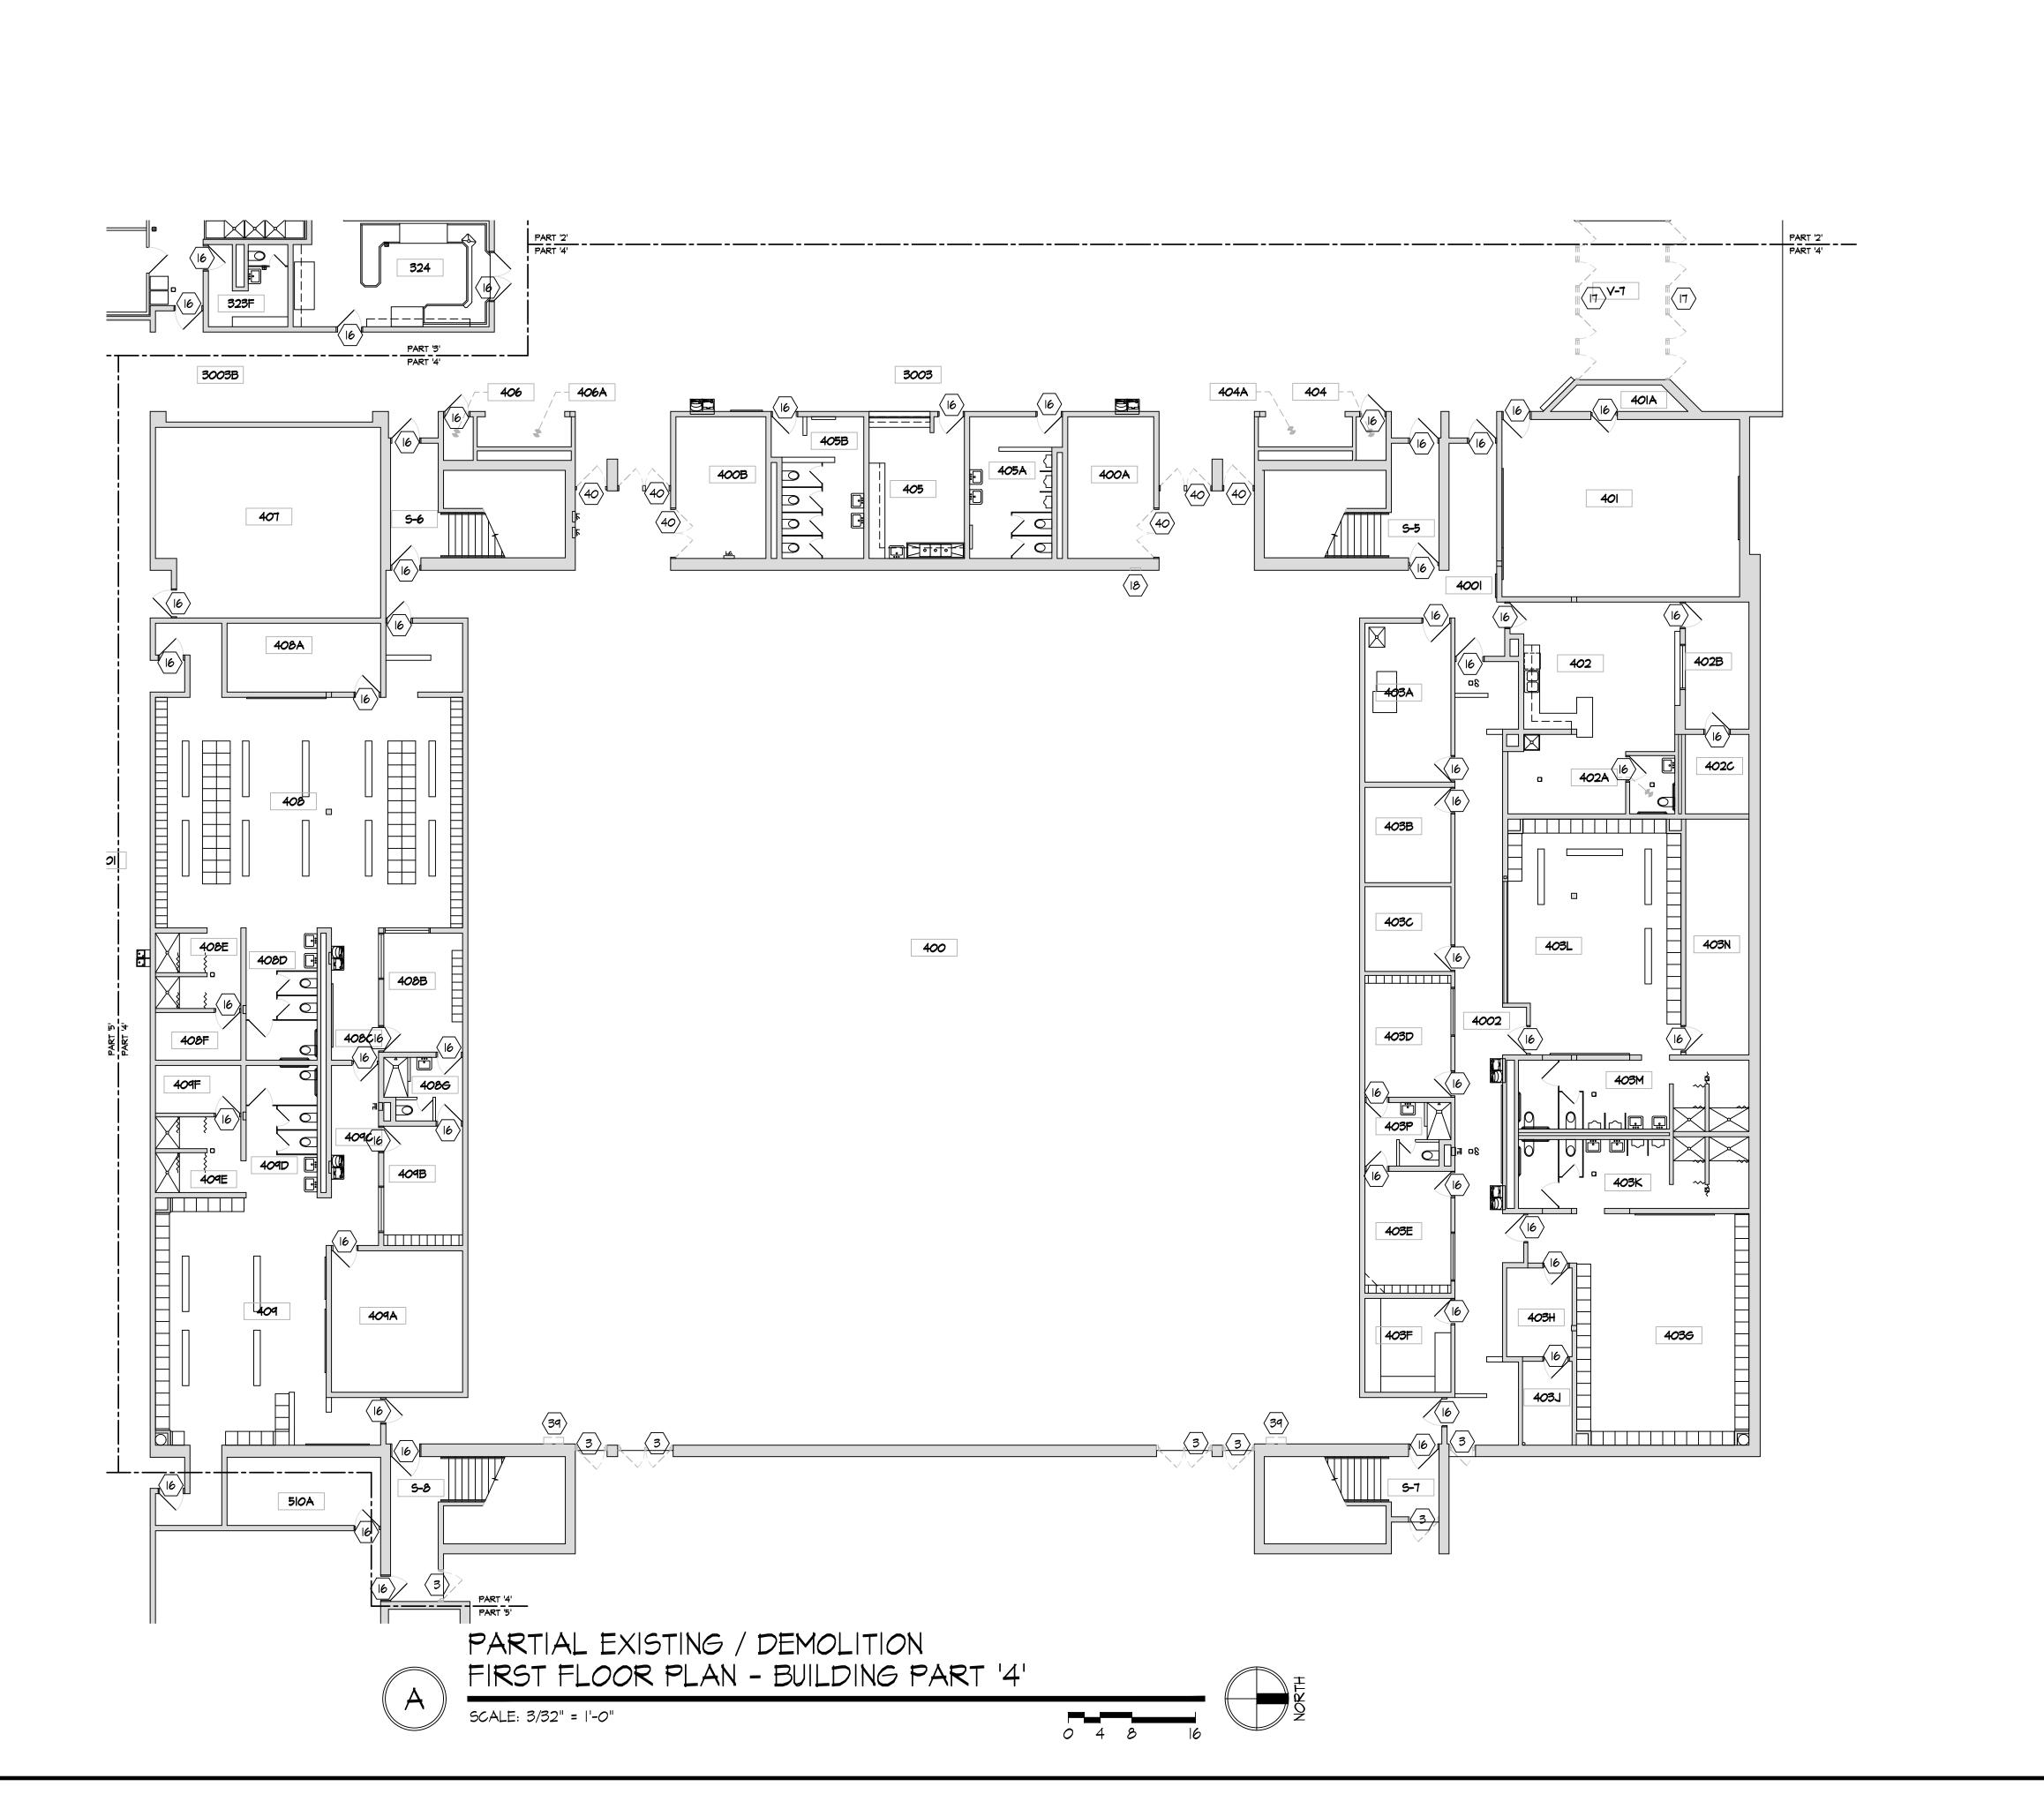

(#) DEMOLITION PLAN KEY NOTES

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- 16. EXISTING DOOR TO REMAIN. PREP FOR REPAIR, REFINISHING, & NEW HARDWARE PER
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- 18. REMOVE EX. SURFACE MOUNTED AND RECESSED ELECTRICAL / DATA DEVICES AS INDICATED. COORDINATE WITH ELECTRICAL DRAWINGS. REPAIR / REPLACE CMU 19. REMOVE EXISTING PLUMBING FIXTURES AND ACCESSORIES COMPLETE.
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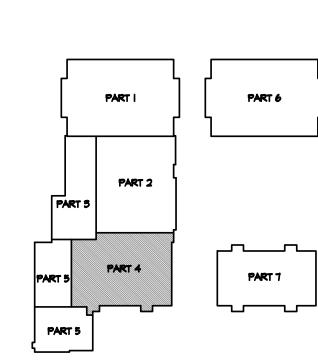
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KEY PLAN

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Project Number 2021-203 Date January 24, 2022 Sheet Title EXISTING/DEMOLITION FIRST FLOOR PLAN PART '4' Sheet Number

Print Record

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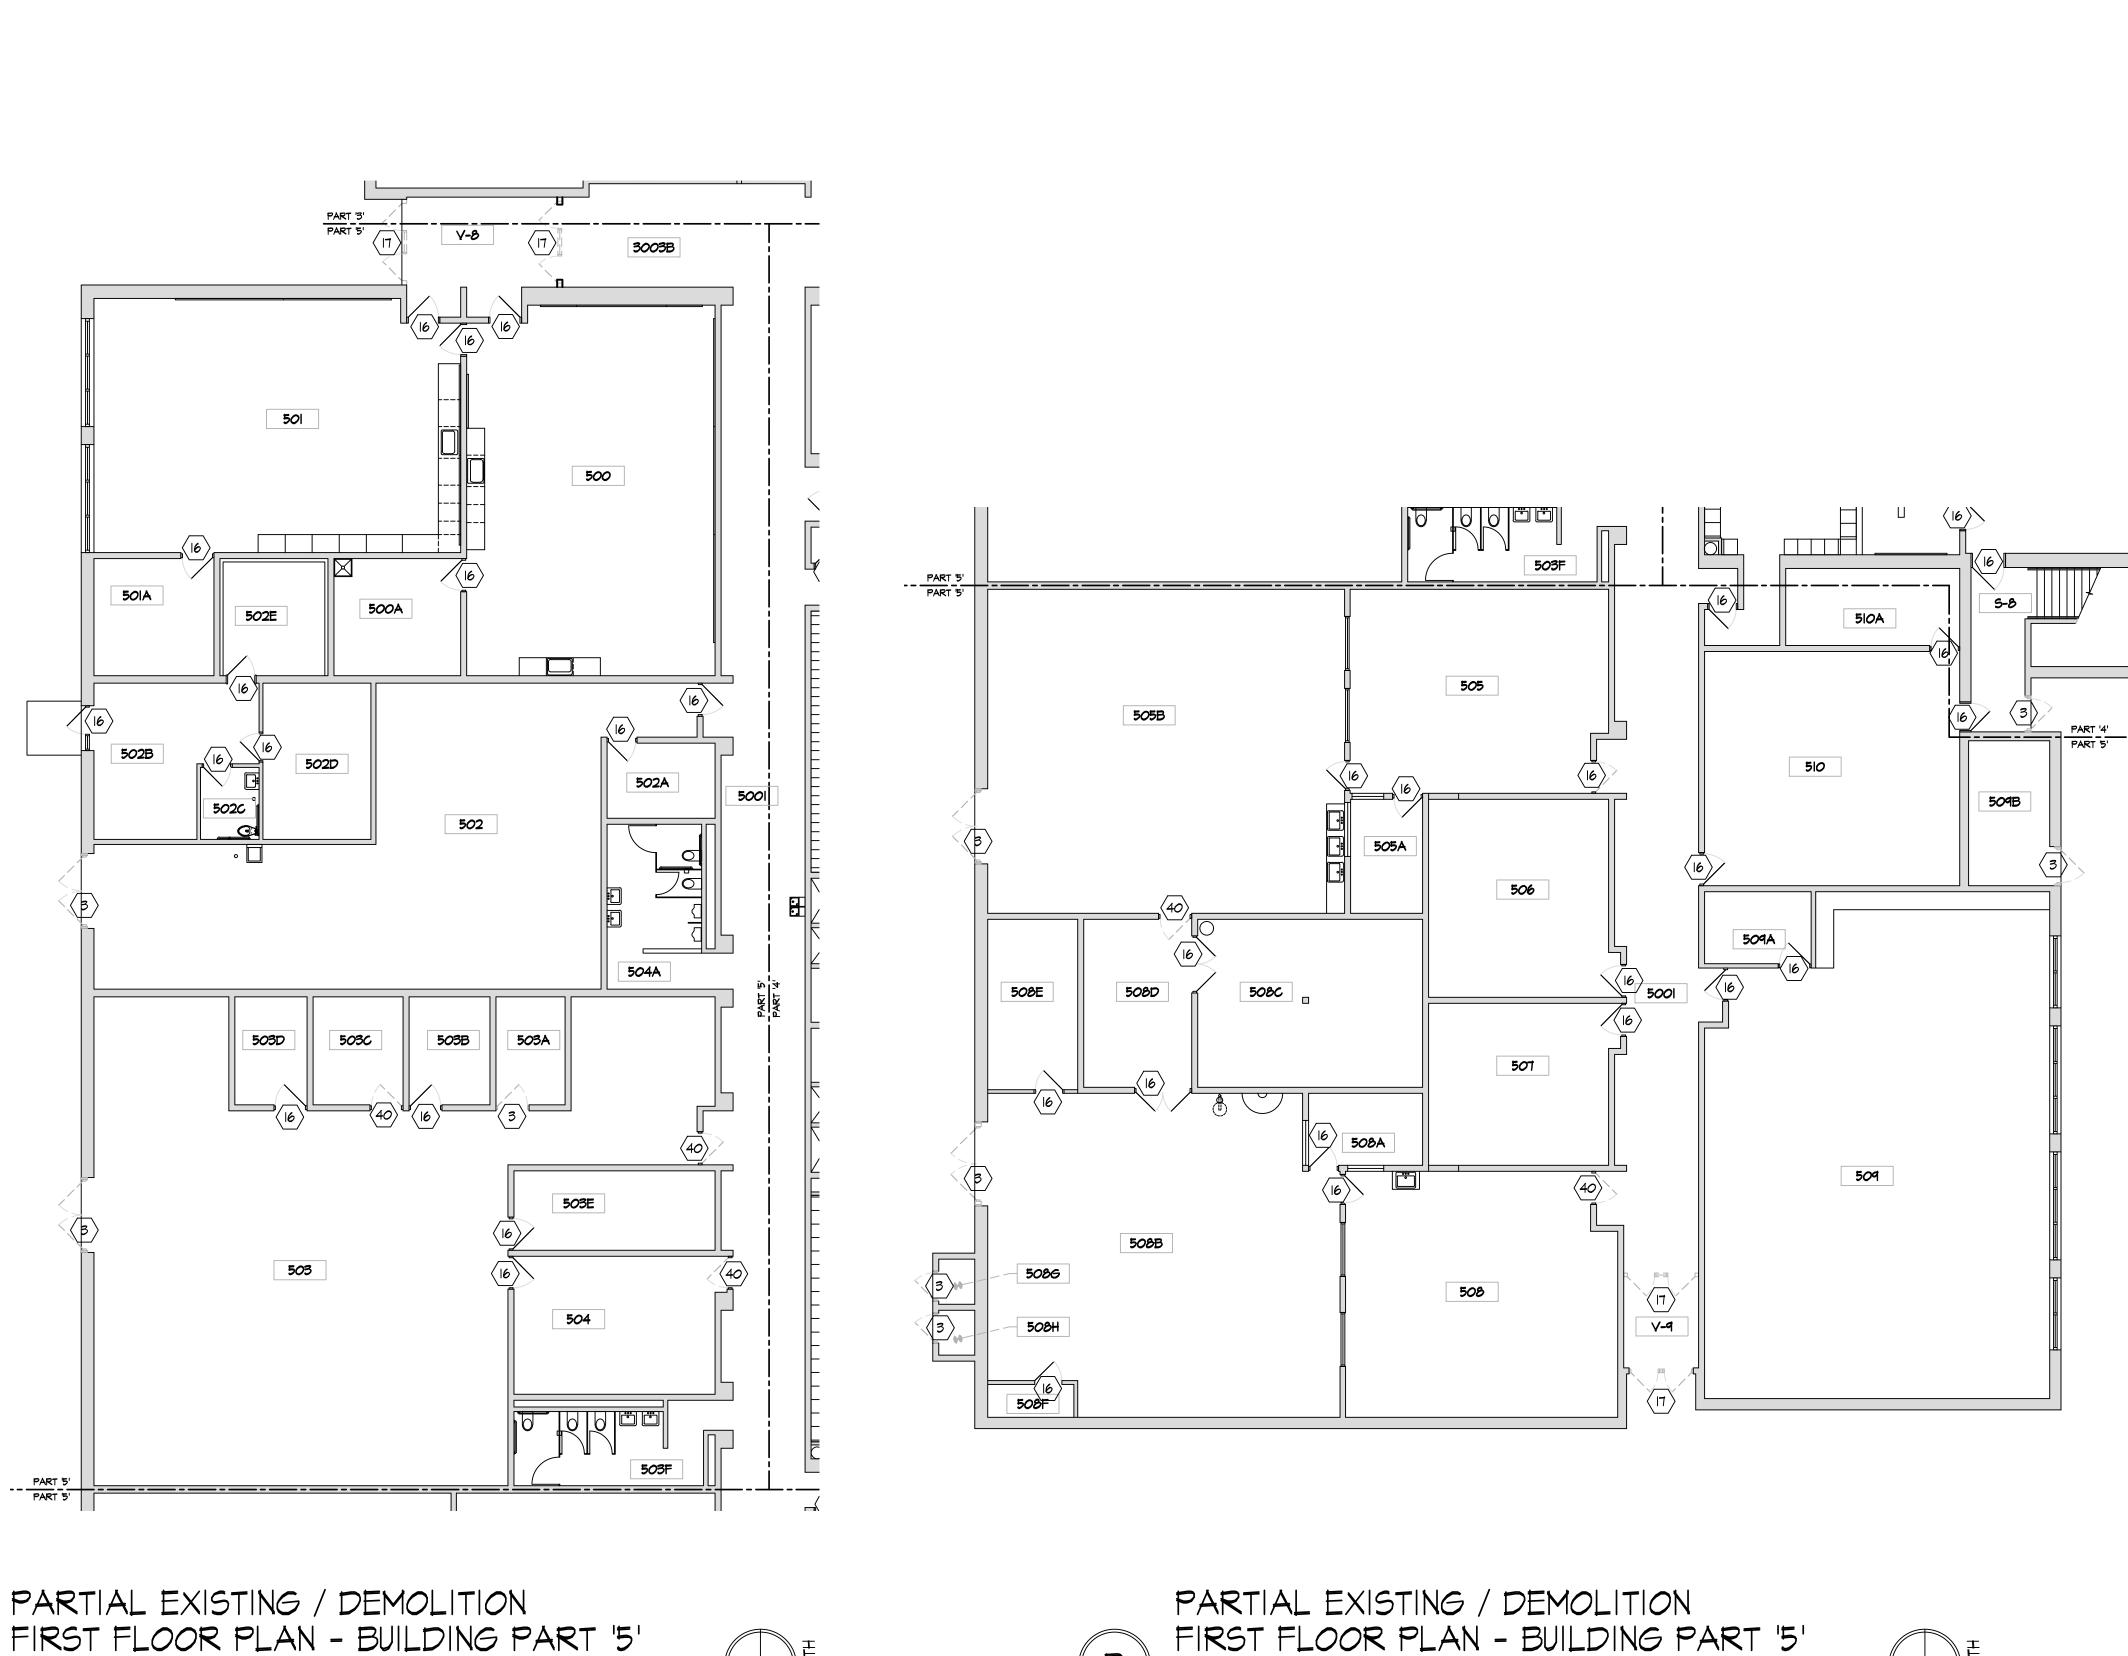
12/07/21 DESIGN REVIEW


CONSTRUCTION

11/16/21 REVIEW

01/11/22 REVIEW

01/24/22 BID SET/



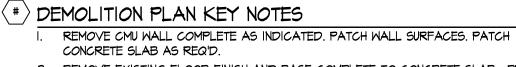

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- PLUMBING/ELECTRICAL WORK. REFER TO PME DRAWINGS & SLAB PLAN. LAYOUT
- INDICATED IS SCHEMATIC ONLY F.V. CONDITIONS AND ROUTING AS APPLICABLE. 35. SAWCUT & REMOVE PORTION OF EX. CMU WALL AS INDICATED. REFER TO PROPOSED
- FLOOR PLANS NEW WORK THIS AREA. 36. REMOVE EXISTING DISPLAY/TROPHY CASE COMPLETE.
- 37. CONTRACTOR TO PROVIDE TEMPORARY PROTECTION [ZIP WALL] THIS LOCATION.
- 38. EXISTING GATE TO REMAIN. 39. REMOVE EXISTING WALL MOUNTED WALL HEATER AND THERMOSTAT COMPLETE.
- CAP/TERMINATE UTILITIES AS REQ'D. REFER TO PME DRAWINGS. 40. REMOVE EX. DOOR & HARDWARE. EX. FRAME TO REMAIN. PREP FOR NEW DOOR, REFINISHING EX. FRAME, & NEW HARDWARE PER PROPOSED PLANS.
- 41. EXISTING ELEVATOR NO WORK.

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42. REMOVE EXISTING STEEL WALL MOUNTED HANDRAILS.







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01/11/22 REVIEW

Project Number

January 24, 2022

EXISTING/DEMOLITION FIRST FLOOR PLAN

2021-203

Sheet Title

Sheet Number

PART '5'

Date

01/24/22 BID SET/

| 1/16/2| REVIEW | 2/07/2| DESIGN REVIEW

CONSTRUCTION

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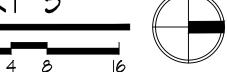
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PART 2 PART 5


KEY PLAN

NOT TO SCALE

SCALE: 3/32" = 1'-0"



SCALE: 3/32" = 1'-0"

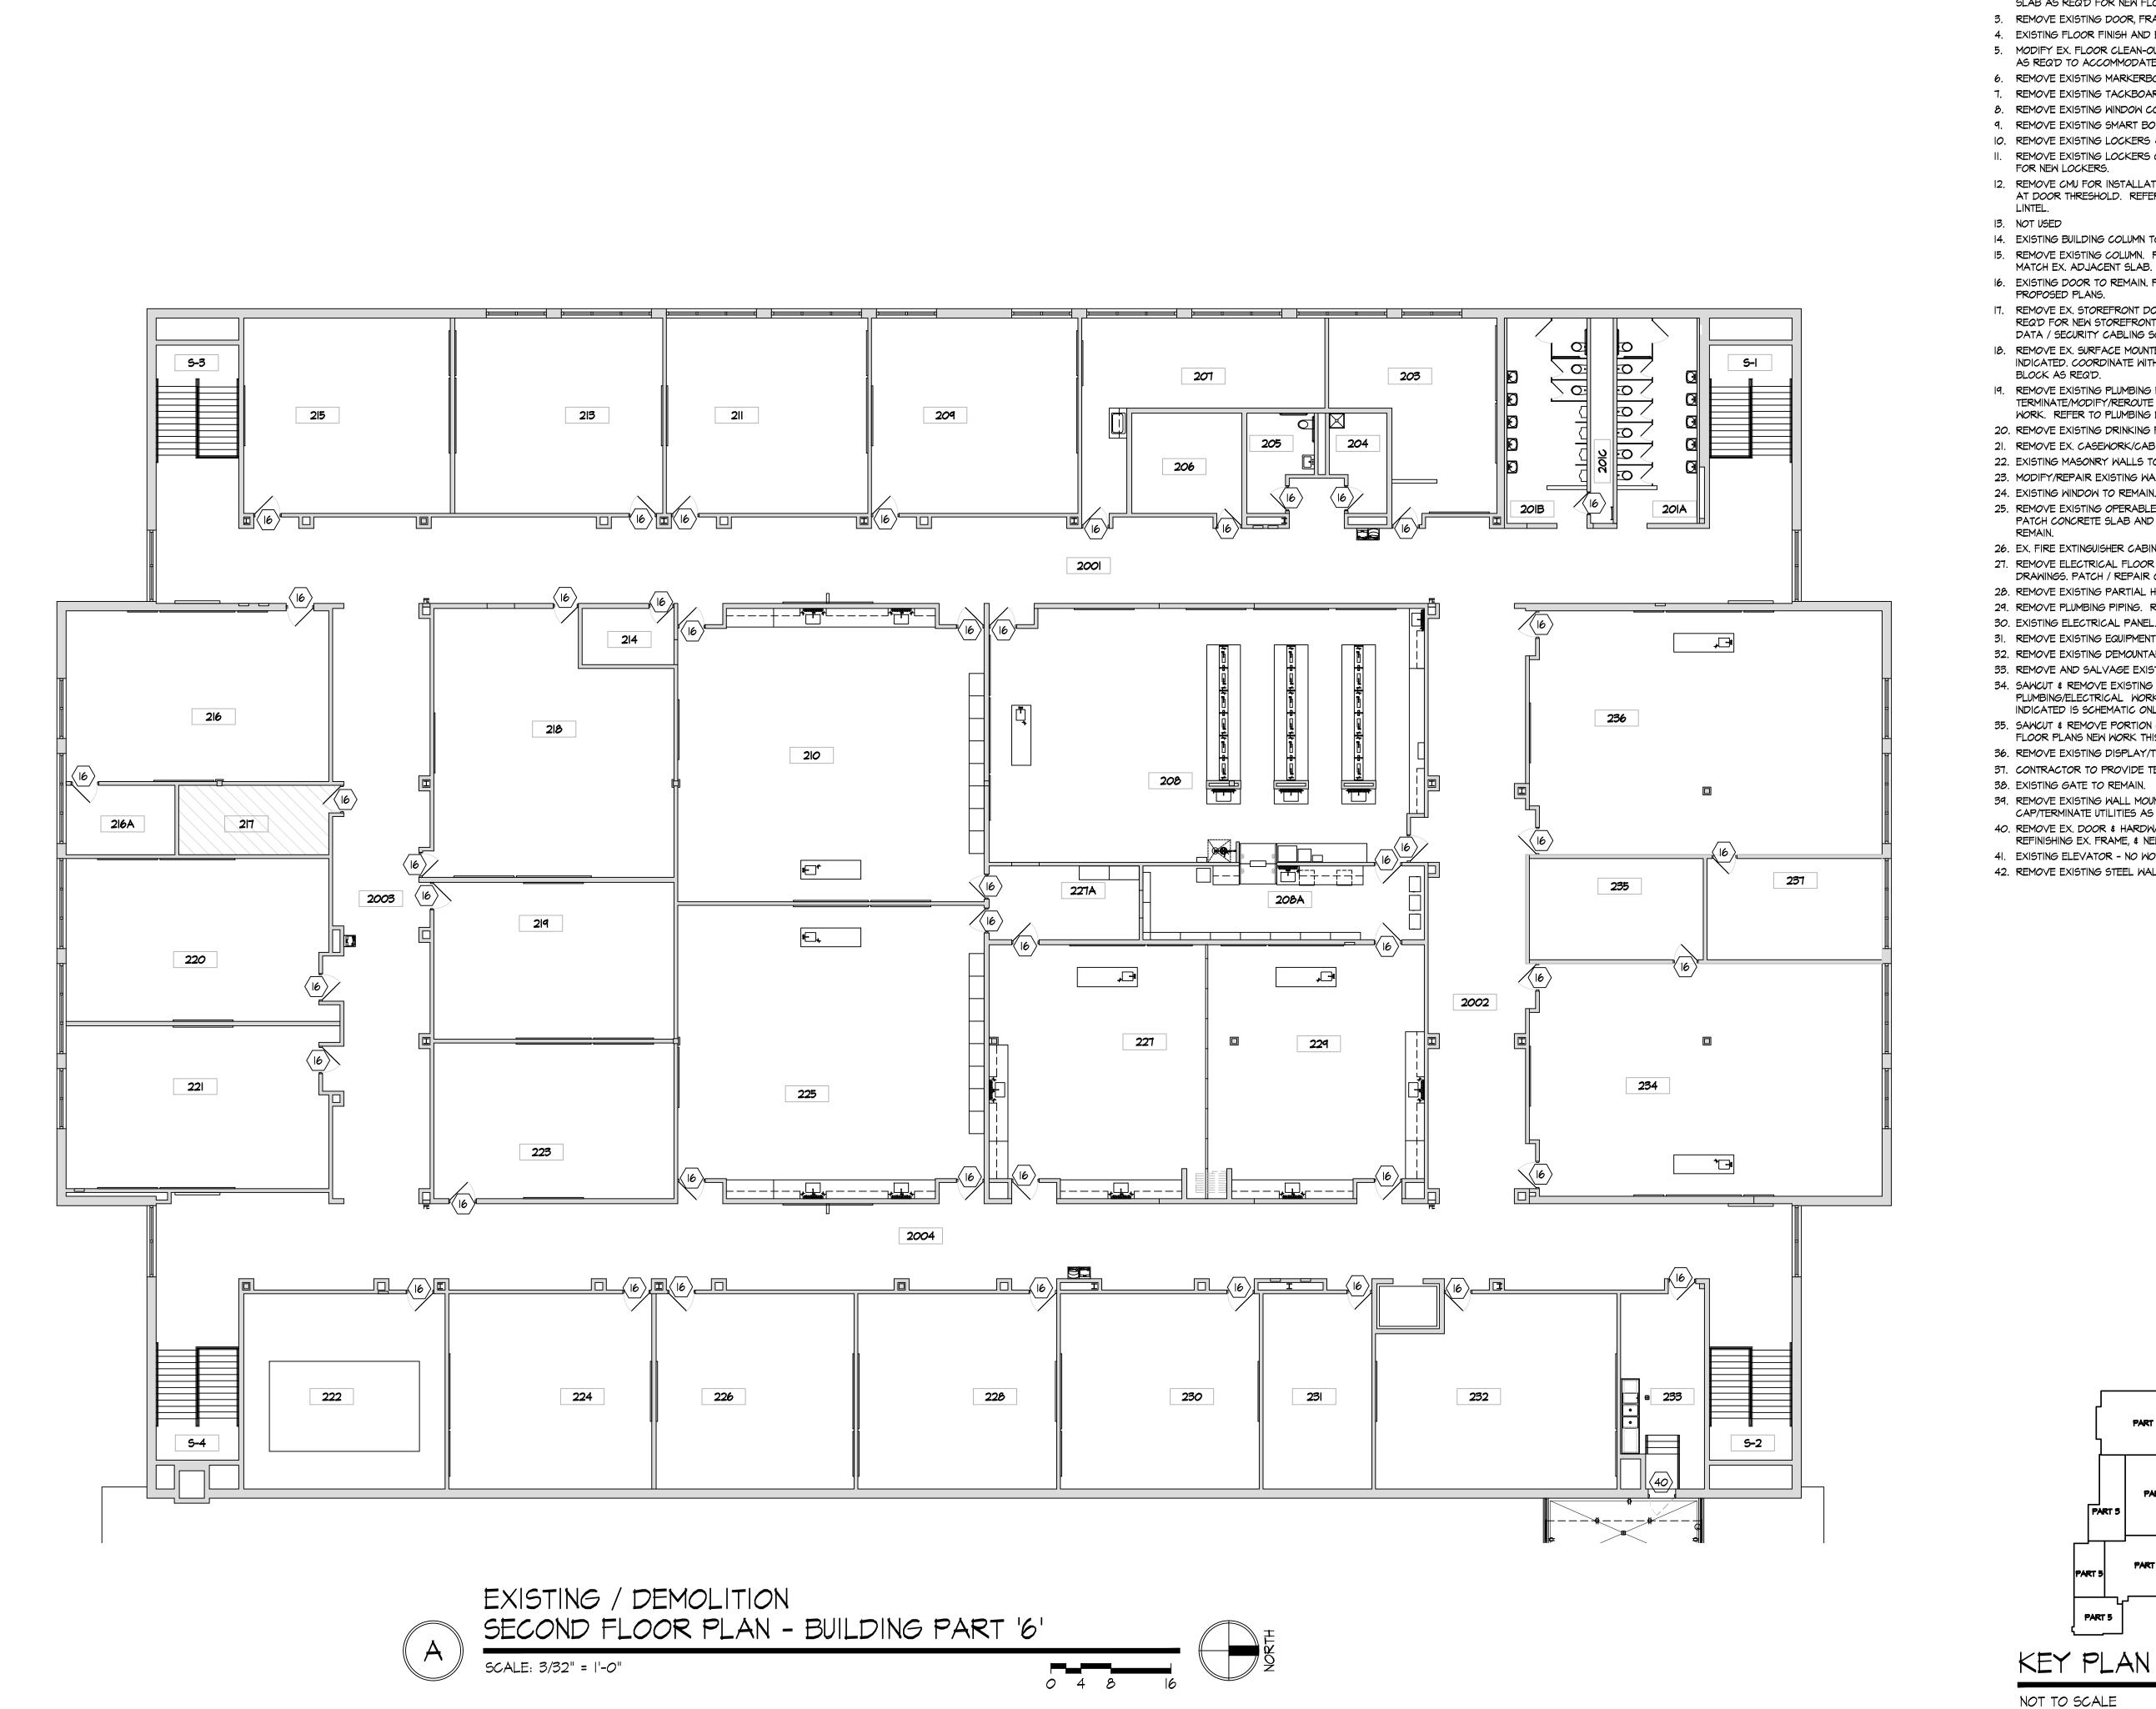

DEMOLITION GENERAL NOTES

REFER TO SHEET DI.II FOR GENERAL NOTES

- CONCRETE SLAB AS REQ'D.
- 2. REMOVE EXISTING FLOOR FINISH AND BASE COMPLETE TO CONCRETE SLAB. PREP

- 5. MODIFY EX. FLOOR CLEAN-OUT, FLOOR DRAIN, ELECTRICAL FLOOR BOX, ETC. HEIGHT
- 6. REMOVE EXISTING MARKERBOARDS/CHALKBOARDS.
- 7. REMOVE EXISTING TACKBOARDS.
- 10. REMOVE EXISTING LOCKERS & WOOD LOCKER BASE COMPLETE.
- II. REMOVE EXISTING LOCKERS COMPLETE. MAINTAIN EXISTING LOCKER BASE IN PLACE
- AT DOOR THRESHOLD. REFER TO DOOR SCHEDULE. REFER TO STRUCTURAL FOR
- 13. NOT USED
- 16. EXISTING DOOR TO REMAIN. PREP FOR REPAIR, REFINISHING, & NEW HARDWARE PER
- 17. REMOVE EX. STOREFRONT DOORS & GLAZING SYSTEM COMPLETE. PREP OPENING AS REQ'D FOR NEW STOREFRONT SYSTEM. REFER TO ELECTRICAL FOR ALL ELECTRIC / DATA / SECURITY CABLING SCOPE OF WORK. MOTE: FRP & HM FRAMES.
- WORK. REFER TO PLUMBING DRAWINGS.

- 25. REMOVE EXISTING OPERABLE PARTITION PANELS, TRACK, & ACCESSORIES COMPLETE. PATCH CONCRETE SLAB AND CMU WALLS AS REQ'D. EXISTING BEAM ABOVE TO
- 26. EX. FIRE EXTINGUISHER CABINET TO REMAIN.
- 27. REMOVE ELECTRICAL FLOOR BOXES THIS ROOM. COORDINATE WITH ELECTRICAL
- 29. REMOVE PLUMBING PIPING. REFER TO PLUMBING DRAWINGS.
- 30. EXISTING ELECTRICAL PANEL. REFER TO ELECTRICAL DRAWINGS.

- INDICATED IS SCHEMATIC ONLY F.V. CONDITIONS AND ROUTING AS APPLICABLE.
- 35. SAWCUT & REMOVE PORTION OF EX. CMU WALL AS INDICATED. REFER TO PROPOSED
- 36. REMOVE EXISTING DISPLAY/TROPHY CASE COMPLETE.
- 37. CONTRACTOR TO PROVIDE TEMPORARY PROTECTION [ZIP WALL] THIS LOCATION.
- 38. EXISTING GATE TO REMAIN.
- CAP/TERMINATE UTILITIES AS REQ'D. REFER TO PME DRAWINGS.
- REFINISHING EX. FRAME, & NEW HARDWARE PER PROPOSED PLANS.



REMOVE CMU WALL COMPLETE AS INDICATED. PATCH WALL SURFACES. PATCH



SLAB AS REQ'D FOR NEW FLOOR FINISH.

3. REMOVE EXISTING DOOR, FRAME, & HARDWARE [SALVAGE EX. WOOD DOORS]

4. EXISTING FLOOR FINISH AND BASE TO REMAIN.

AS REQ'D TO ACCOMMODATE NEW FLOOR FINISH.

8. REMOVE EXISTING WINDOW COMPLETE.

9. REMOVE EXISTING SMART BOARDS. REMOVE PROJECTOR AND TURN OVER TO OWNER.

FOR NEW LOCKERS. 12. REMOVE CMU FOR INSTALLATION OF NEW DOOR. SAWCUT & REMOVE SLAB AS REQ'D

14. EXISTING BUILDING COLUMN TO REMAIN.

- 15. REMOVE EXISTING COLUMN. PATCH/REPAIR EXISTING CONCRETE SLAB AS REQ'D TO MATCH EX. ADJACENT SLAB. PREP FOR NEW FLOOR FINISHES.
- 18. REMOVE EX. SURFACE MOUNTED AND RECESSED ELECTRICAL / DATA DEVICES AS INDICATED. COORDINATE WITH ELECTRICAL DRAWINGS. REPAIR / REPLACE CMU
- 19. REMOVE EXISTING PLUMBING FIXTURES AND ACCESSORIES COMPLETE. TERMINATE/MODIFY/REROUTE EXISTING SUPPLY & SANITARY LINES AS REQ'D BY NEW
- 20. REMOVE EXISTING DRINKING FOUNTAIN & STAINLESS STEEL WALL PLATE.
- 21. REMOVE EX. CASEWORK/CABINETRY COMPLETE.
- 22. EXISTING MASONRY WALLS TO REMAIN.
- 23. MODIFY/REPAIR EXISTING WALL/FINISHES TO MEET NEW CMU WALL.
- 24. EXISTING WINDOW TO REMAIN.

- DRAWINGS. PATCH / REPAIR CONCRETE SLAB AS REQ'D.
- 28. REMOVE EXISTING PARTIAL HEIGHT CMU WALL.
- 31. REMOVE EXISTING EQUIPMENT AND TURN OVER TO OWNER AS DIRECTED.
- 32. REMOVE EXISTING DEMOUNTABLE PARTITION AND ASSOCIATED HARDWARE COMPLETE.
- 33. REMOVE AND SALVAGE EXISTING BOOKCASES. TURN OVER TO OWNER.
- 34. SAWCUT & REMOVE EXISTING 5" CONCRETE SLAB THIS AREA AS REQ'D BY NEW PLUMBING/ELECTRICAL WORK. REFER TO PME DRAWINGS & SLAB PLAN. LAYOUT
- FLOOR PLANS NEW WORK THIS AREA.
- 39. REMOVE EXISTING WALL MOUNTED WALL HEATER AND THERMOSTAT COMPLETE.
- 40. REMOVE EX. DOOR & HARDWARE. EX. FRAME TO REMAIN. PREP FOR NEW DOOR,
- 41. EXISTING ELEVATOR NO WORK.
- 42. REMOVE EXISTING STEEL WALL MOUNTED HANDRAILS.

PART 2

PART 5

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Expiration Date 12/31/2023

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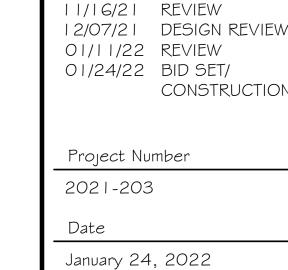
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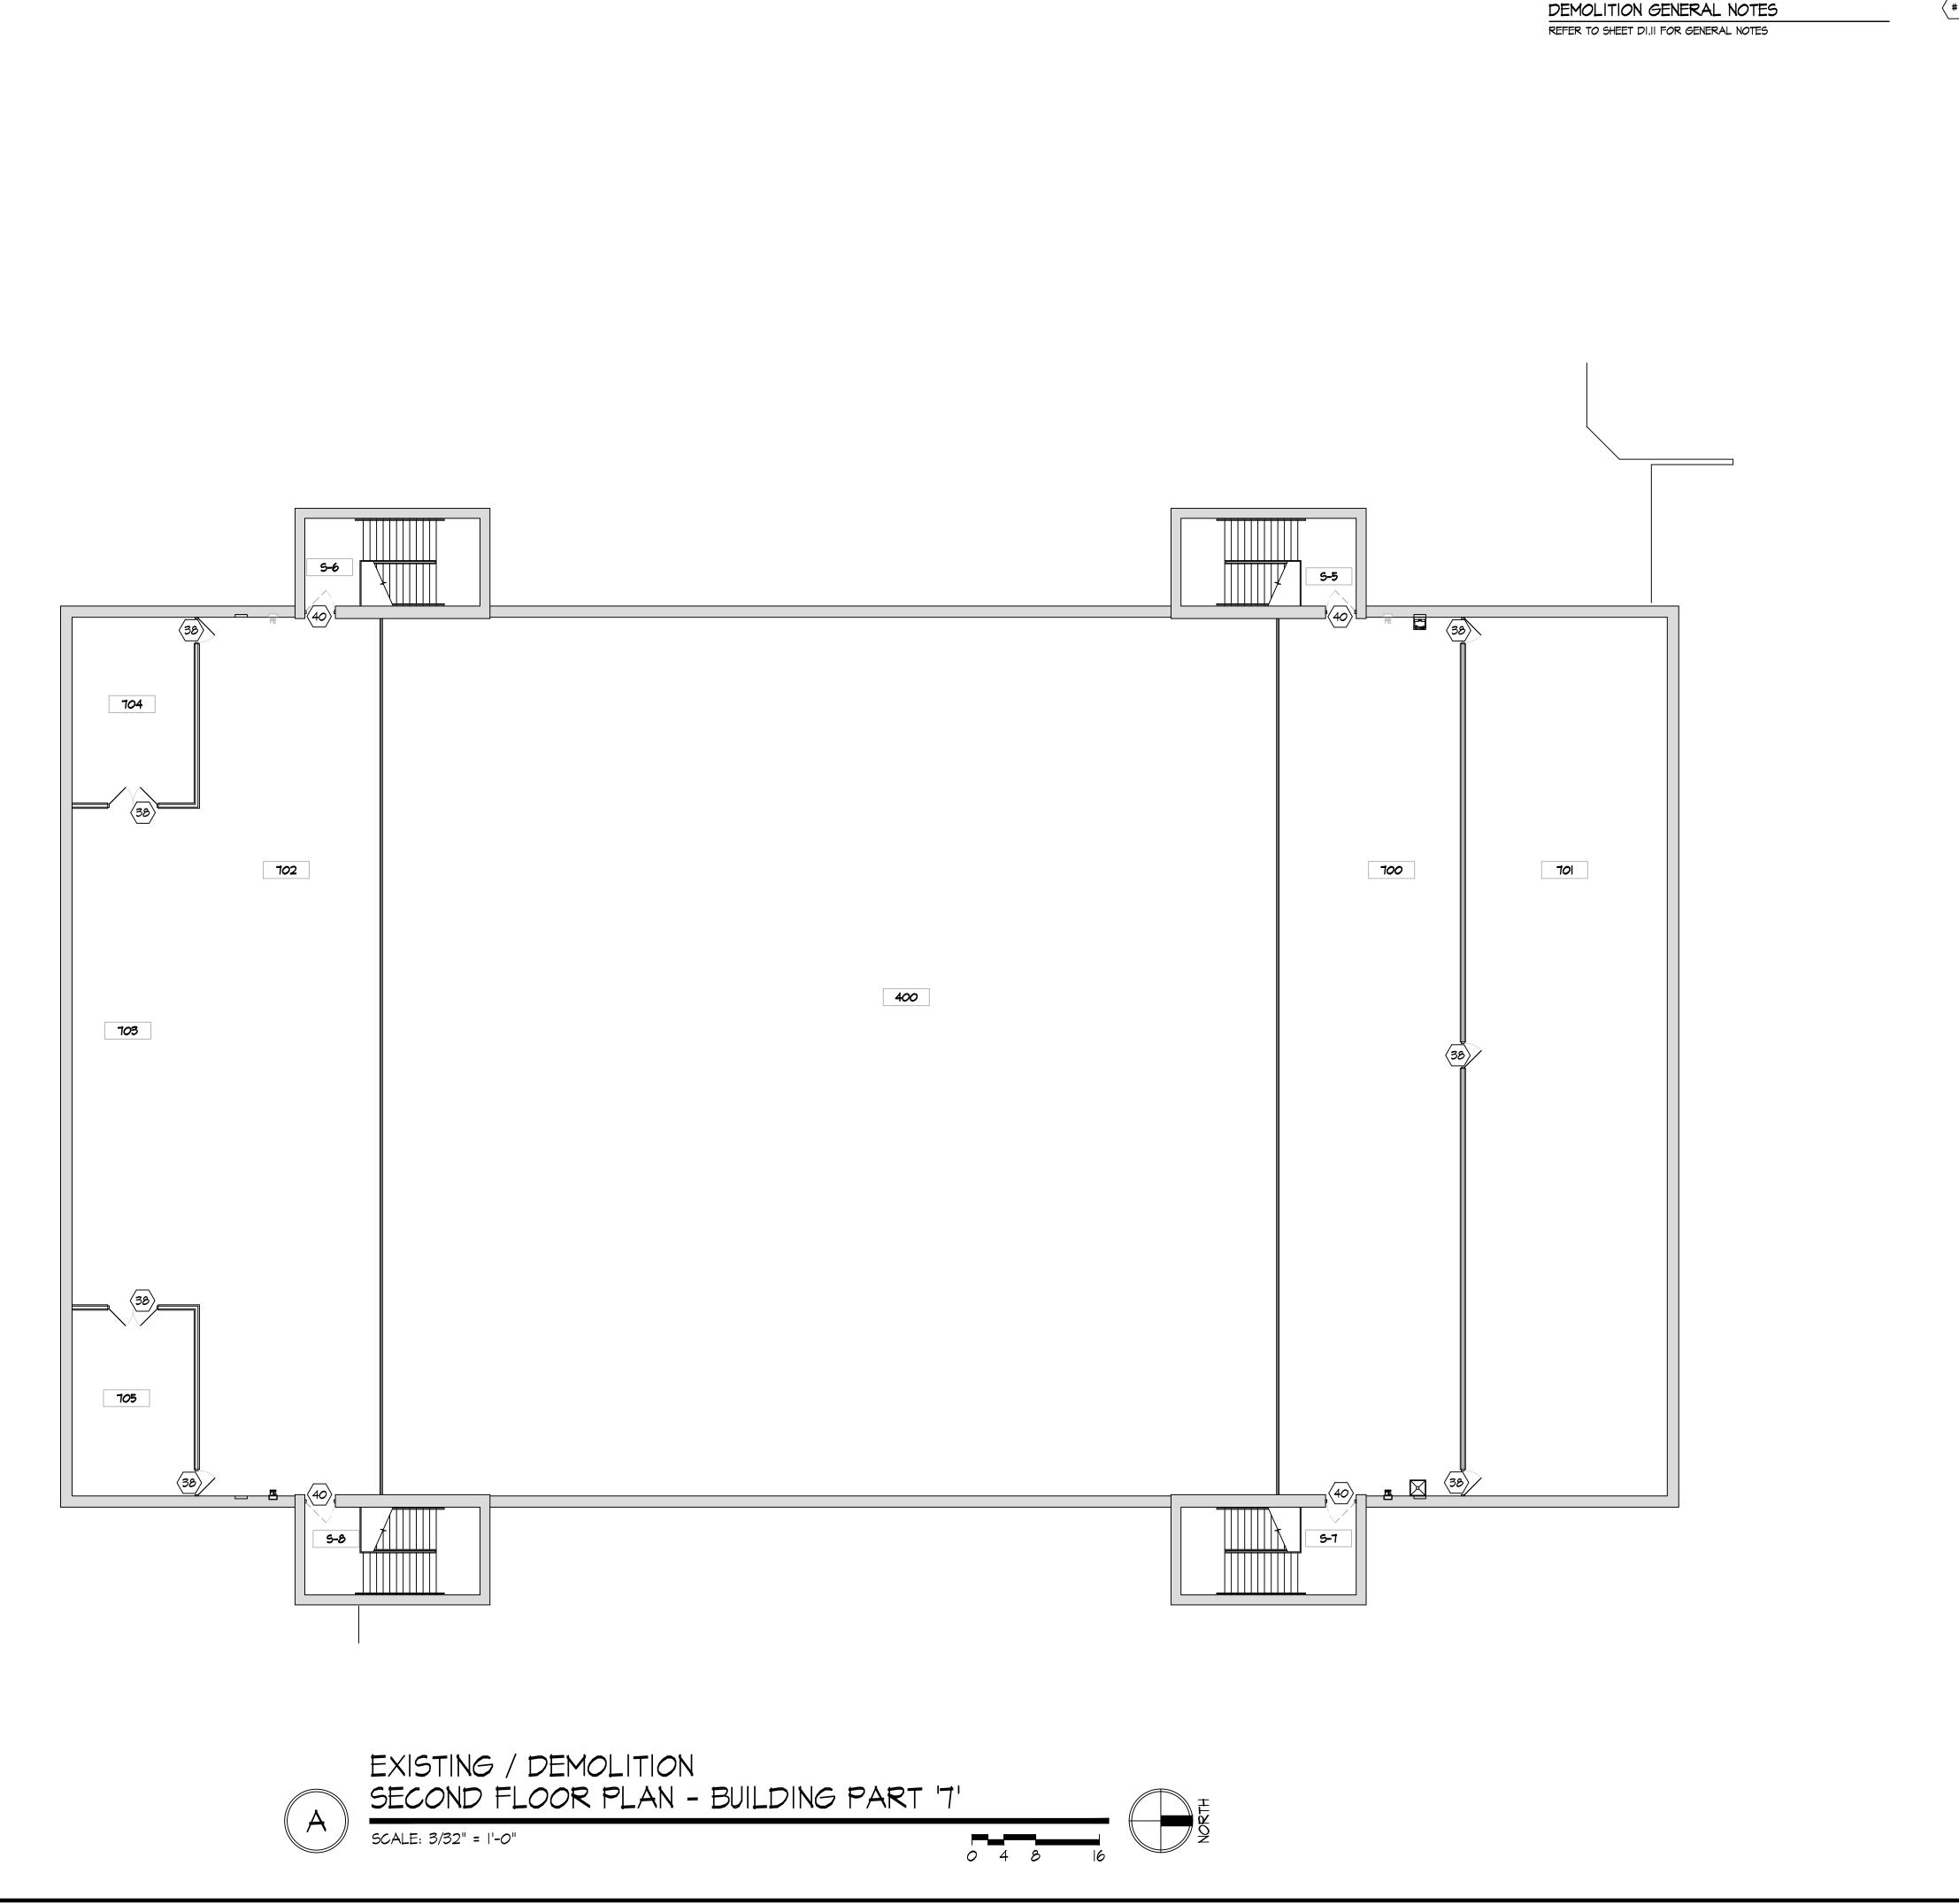
10/11/21 PRELIMINARY

Sheet Title

EXISTING/DEMOLITION SECOND FLOOR PLAN PART '6'

Sheet Number

.6



(#) DEMOLITION PLAN KEY NOTES

- REMOVE CMU WALL COMPLETE AS INDICATED. PATCH WALL SURFACES. PATCH CONCRETE SLAB AS REQ'D.
- 2. REMOVE EXISTING FLOOR FINISH AND BASE COMPLETE TO CONCRETE SLAB. PREP SLAB AS REQ'D FOR NEW FLOOR FINISH.
- 3. REMOVE EXISTING DOOR, FRAME, & HARDWARE [SALVAGE EX. WOOD DOORS]
- 4. EXISTING FLOOR FINISH AND BASE TO REMAIN. 5. MODIFY EX. FLOOR CLEAN-OUT, FLOOR DRAIN, ELECTRICAL FLOOR BOX, ETC. HEIGHT
- AS REQ'D TO ACCOMMODATE NEW FLOOR FINISH.
- 6. REMOVE EXISTING MARKERBOARDS/CHALKBOARDS.
- REMOVE EXISTING TACKBOARDS.
- 8. REMOVE EXISTING WINDOW COMPLETE.
- 9. REMOVE EXISTING SMART BOARDS. REMOVE PROJECTOR AND TURN OVER TO OWNER. 10. REMOVE EXISTING LOCKERS & WOOD LOCKER BASE COMPLETE.
- II. REMOVE EXISTING LOCKERS COMPLETE. MAINTAIN EXISTING LOCKER BASE IN PLACE FOR NEW LOCKERS.
- 12. REMOVE CMU FOR INSTALLATION OF NEW DOOR. SAWCUT & REMOVE SLAB AS REQ'D AT DOOR THRESHOLD. REFER TO DOOR SCHEDULE. REFER TO STRUCTURAL FOR
- 13. NOT USED
- 14. EXISTING BUILDING COLUMN TO REMAIN.
- 15. REMOVE EXISTING COLUMN. PATCH/REPAIR EXISTING CONCRETE SLAB AS REQ'D TO MATCH EX. ADJACENT SLAB. PREP FOR NEW FLOOR FINISHES.
- 16. EXISTING DOOR TO REMAIN. PREP FOR REPAIR, REFINISHING, & NEW HARDWARE PER

17. REMOVE EX. STOREFRONT DOORS & GLAZING SYSTEM COMPLETE. PREP OPENING AS

- REQ'D FOR NEW STOREFRONT SYSTEM. REFER TO ELECTRICAL FOR ALL ELECTRIC / DATA / SECURITY CABLING SCOPE OF WORK. MOTE: FRP & HM FRAMES. 18. REMOVE EX. SURFACE MOUNTED AND RECESSED ELECTRICAL / DATA DEVICES AS INDICATED. COORDINATE WITH ELECTRICAL DRAWINGS. REPAIR / REPLACE CMU
- 19. REMOVE EXISTING PLUMBING FIXTURES AND ACCESSORIES COMPLETE. TERMINATE/MODIFY/REROUTE EXISTING SUPPLY & SANITARY LINES AS REQ'D BY NEW
- WORK. REFER TO PLUMBING DRAWINGS. 20. REMOVE EXISTING DRINKING FOUNTAIN & STAINLESS STEEL WALL PLATE.
- 21. REMOVE EX. CASEWORK/CABINETRY COMPLETE.
- 22. EXISTING MASONRY WALLS TO REMAIN.
- 23. MODIFY/REPAIR EXISTING WALL/FINISHES TO MEET NEW CMU WALL.
- 24. EXISTING WINDOW TO REMAIN.
- 25. REMOVE EXISTING OPERABLE PARTITION PANELS, TRACK, & ACCESSORIES COMPLETE. PATCH CONCRETE SLAB AND CMU WALLS AS REQ'D. EXISTING BEAM ABOVE TO
- 26. EX. FIRE EXTINGUISHER CABINET TO REMAIN.
- 27. REMOVE ELECTRICAL FLOOR BOXES THIS ROOM. COORDINATE WITH ELECTRICAL DRAWINGS. PATCH / REPAIR CONCRETE SLAB AS REQ'D.
- 28. REMOVE EXISTING PARTIAL HEIGHT CMU WALL.
- 29. REMOVE PLUMBING PIPING. REFER TO PLUMBING DRAWINGS.
- 30. EXISTING ELECTRICAL PANEL. REFER TO ELECTRICAL DRAWINGS.
- 31. REMOVE EXISTING EQUIPMENT AND TURN OVER TO OWNER AS DIRECTED.
- 32. REMOVE EXISTING DEMOUNTABLE PARTITION AND ASSOCIATED HARDWARE COMPLETE.
- 33. REMOVE AND SALVAGE EXISTING BOOKCASES. TURN OVER TO OWNER. 34. SAWCUT & REMOVE EXISTING 5" CONCRETE SLAB THIS AREA AS REQ'D BY NEW
- PLUMBING/ELECTRICAL WORK. REFER TO PME DRAWINGS & SLAB PLAN. LAYOUT
- INDICATED IS SCHEMATIC ONLY F.V. CONDITIONS AND ROUTING AS APPLICABLE. 35. SAWCUT & REMOVE PORTION OF EX. CMU WALL AS INDICATED. REFER TO PROPOSED FLOOR PLANS NEW WORK THIS AREA.
- 36. REMOVE EXISTING DISPLAY/TROPHY CASE COMPLETE.
- 37. CONTRACTOR TO PROVIDE TEMPORARY PROTECTION [ZIP WALL] THIS LOCATION. 38. EXISTING GATE TO REMAIN.
- 39. REMOVE EXISTING WALL MOUNTED WALL HEATER AND THERMOSTAT COMPLETE. CAP/TERMINATE UTILITIES AS REQ'D. REFER TO PME DRAWINGS.
- 40. REMOVE EX. DOOR & HARDWARE. EX. FRAME TO REMAIN. PREP FOR NEW DOOR, REFINISHING EX. FRAME, & NEW HARDWARE PER PROPOSED PLANS.
- 41. EXISTING ELEVATOR NO WORK.
- 42. REMOVE EXISTING STEEL WALL MOUNTED HANDRAILS.



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Project Number

January 24, 2022

EXISTING/DEMOLITION SECOND FLOOR PLAN

2021-203

Sheet Title

Sheet Number

PART '7'

Date

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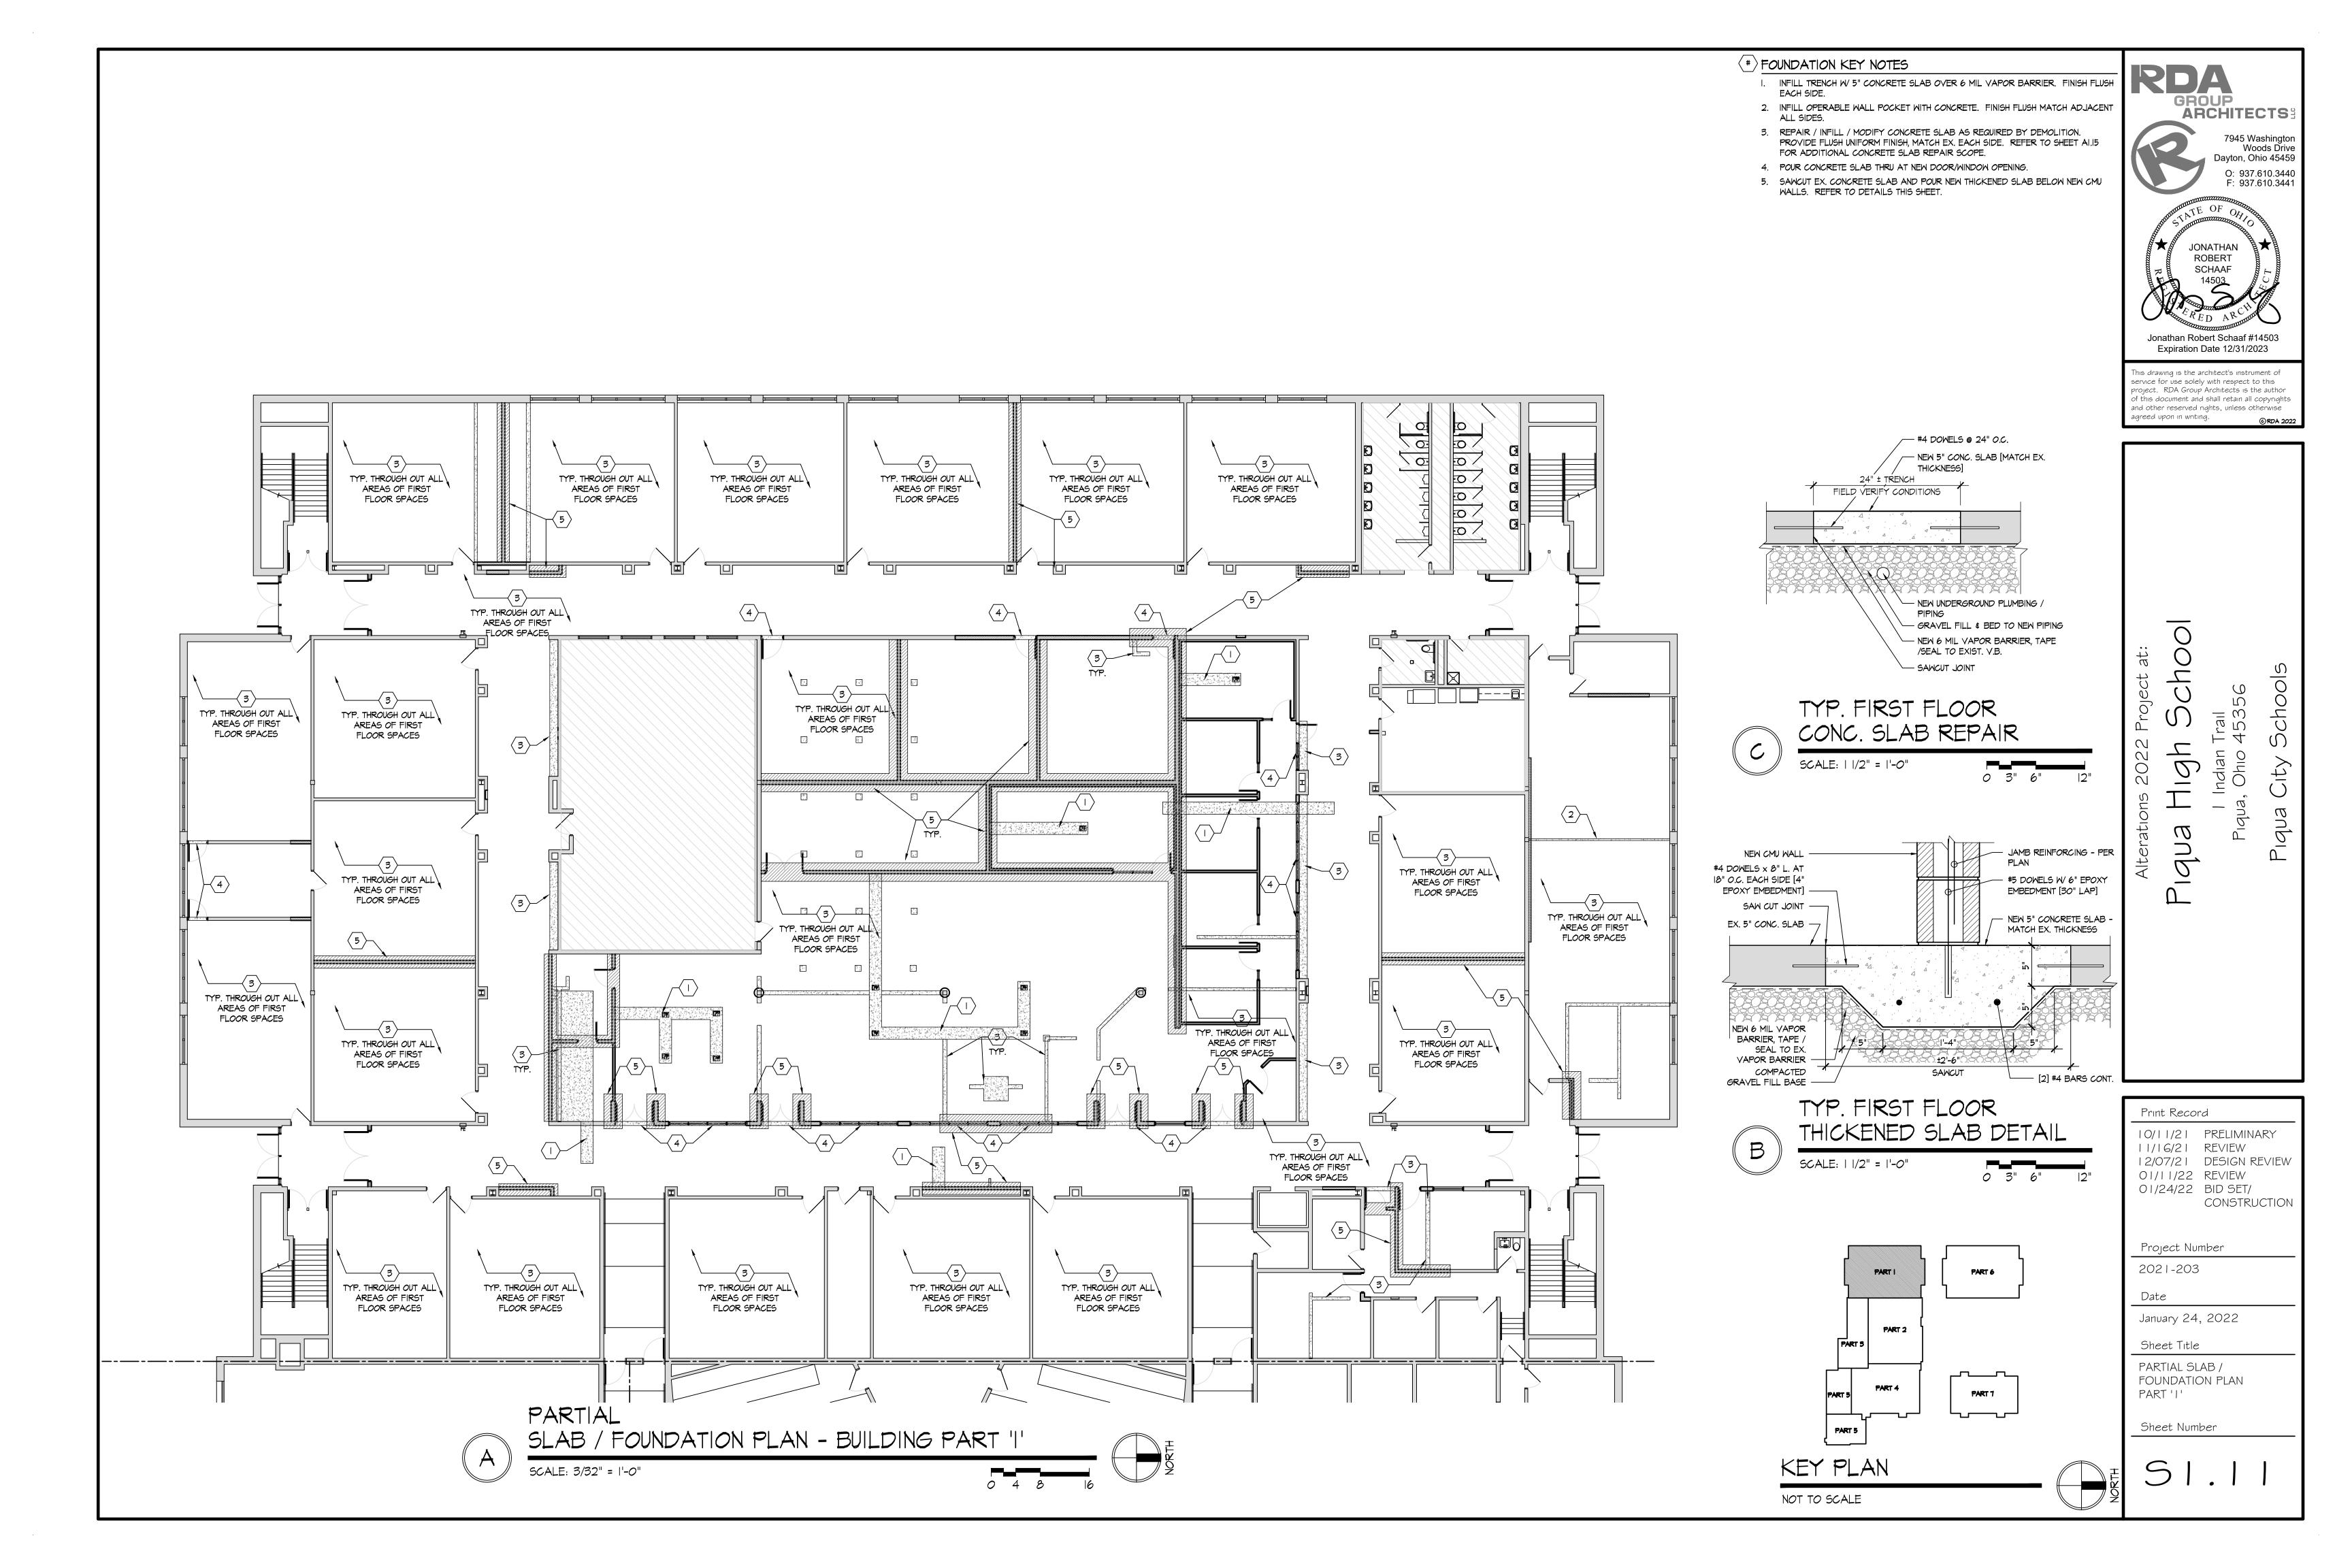
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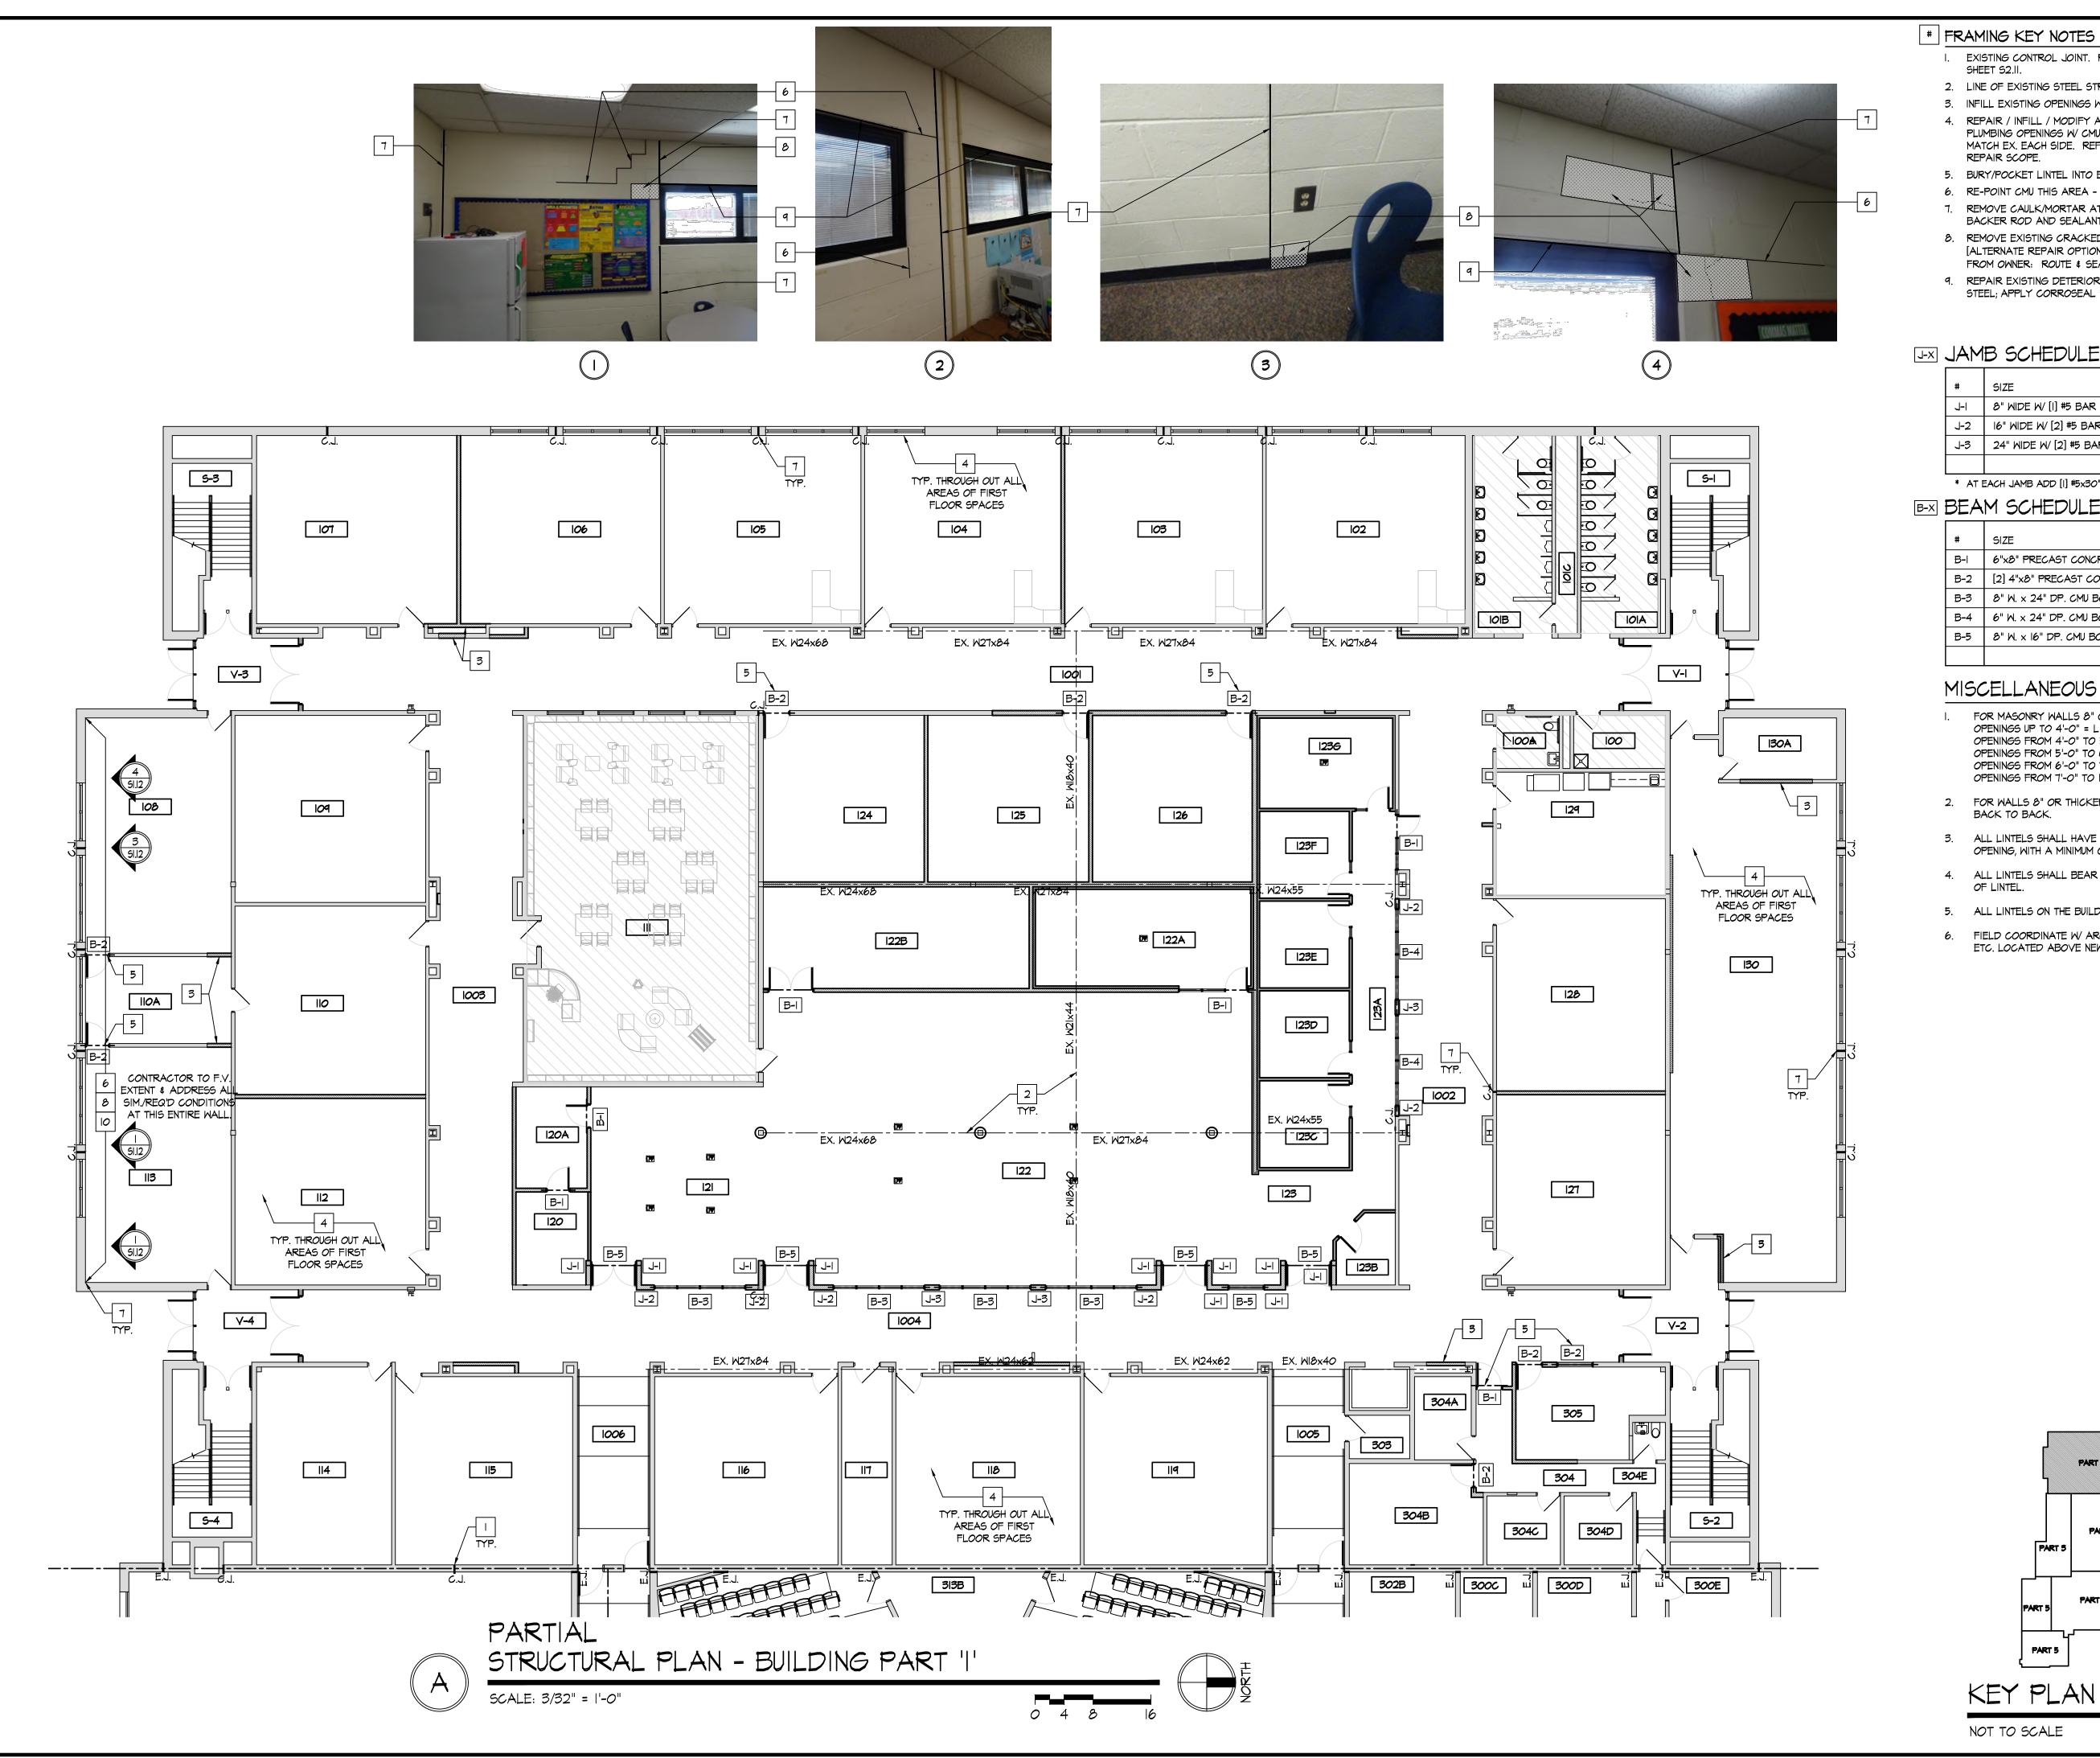
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PART 5

KEY PLAN

NOT TO SCALE





FRAMING KEY NOTES

- I. EXISTING CONTROL JOINT. REMOVE EXISTING COVER. REFER TO DETAILS ON SHEET S2.II.
- 2. LINE OF EXISTING STEEL STRUCTURE.
- 3. INFILL EXISTING OPENINGS W/ CMU, TOOTH INTO EXISTING, MATCH EX. EACH SIDE.
- 4. REPAIR / INFILL / MODIFY ALL EXISTING CLOCK, FIRE ALARM, ELECTRICAL, \$ PLUMBING OPENINGS W/ CMU AS REQUIRED BY DEMOLITION. TOOTH INTO EXISTING, MATCH EX. EACH SIDE. REFER TO SHEETS ALI5 FOR ADDITIONAL CMU/MASONRY REPAIR SCOPE.
- 5. BURY/POCKET LINTEL INTO EXISTING CMU WALL THIS LOCATION.
- 6. RE-POINT CMU THIS AREA STAIR STEP CRACK, OPEN JOINTS, ETC.
- 7. REMOVE CAULK/MORTAR AT INSIDE CORNERS/VERTICAL JOINTS. INSTALL NEW BACKER ROD AND SEALANT OVER.
- 8. REMOVE EXISTING CRACKED CMU, INSTALL NEW CMU BLOCK/SOAP. PREP & PAINT [ALTERNATE REPAIR OPTION ONLY AT CERTAIN LOCATIONS W/ PRIOR APPROVAL FROM OWNER: ROUTE & SEAL CRACK IN EX. CMU. - REFER TO DETAIL L/A2.II]
- 9. REPAIR EXISTING DETERIORATED STEEL LINTEL. REPAIR PROCESS: SCRAPE STEEL; APPLY CORROSEAL RUST CONVERTER; PRIME & PAINT W ZINC RICH PAINT.

JAMB SCHEDULE

#	SIZE
J-I	8" WIDE W/ [I] #5 BAR VERTICAL - FULL HEIGHT

MIDE W/ [I] #5 BAR VERTICAL - FULL HEIGHT	service for use solely with respect to this
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* AT EACH JAMB ADD [1] #5x30"x30" L-SHAPED DOWEL - TWO DOWELS AT INTERIOR JAMBS

B-X BEAM SCHEDULE

#	SIZE	BEARING
В	6"x8" PRECAST CONCRETE W/ NOMINAL REBAR	4" EACH SIDE MIN.
B-2	[2] 4"x8" PRECAST CONCRETE W/ NOMINAL REBAR	4" EACH SIDE MIN.
B-3	8" W. x 24" DP. CMU BOND BEAM GROUTED SOLID W/ [2] #5 BARS	
B-4	6" W. x 24" DP. CMU BOND BEAM GROUTED SOLID W/ [2] #4 BARS	
B-5	8" W. x 16" DP. CMU BOND BEAM GROUTED SOLID W/ [2] #5 BARS	

MISCELLANEOUS STEEL LINTEL SCEHDULE:

- FOR MASONRY WALLS 8" OR THICKER: OPENINGS UP TO 4'-0" = L 3 1/2" X 3 1/2" X 5/16" OPENINGS FROM 4'-0" TO 5'-0" = L 4" X 3 1/2" X 5/16"LLV OPENINGS FROM 5'-0" TO 6'-0" = L 5" X 3 1/2" X 5/16"LLV OPENINGS FROM 6'-0" TO 7-0" = L 6" X 3 1/2"X 5/16"LLV OPENINGS FROM 7'-O" TO 10'-O" = W8X21 + 5/16" BOTTOM PLATE
- 2. FOR WALLS 8" OR THICKER, ANGLES SHALL BE ORIENTED WITH VERTICAL LEGS BACK TO BACK.
- 3. ALL LINTELS SHALL HAVE A BEARING AT EACH END OF I INCH PER FOOT OF OPENING, WITH A MINIMUM OF 6"
- 4. ALL LINTELS SHALL BEAR ON 16" SOLID MASONRY EXTENDING 16" BEYOND END OF LINTEL.
- 5. ALL LINTELS ON THE BUILDING EXTERIOR SHALL BE GALVANIZED.

PART 2

PART 4

PART 5

PART 5

6. FIELD COORDINATE W/ ARCHITECT FOR SPECIAL CONDITIONS / POINT LOADS, ETC. LOCATED ABOVE NEW OPENINGS.

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Jonathan Robert Schaaf #14503 Expiration Date 12/31/2023

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CONSTRUCTION

01/24/22 BID SET/


Project Number 2021-203 Date


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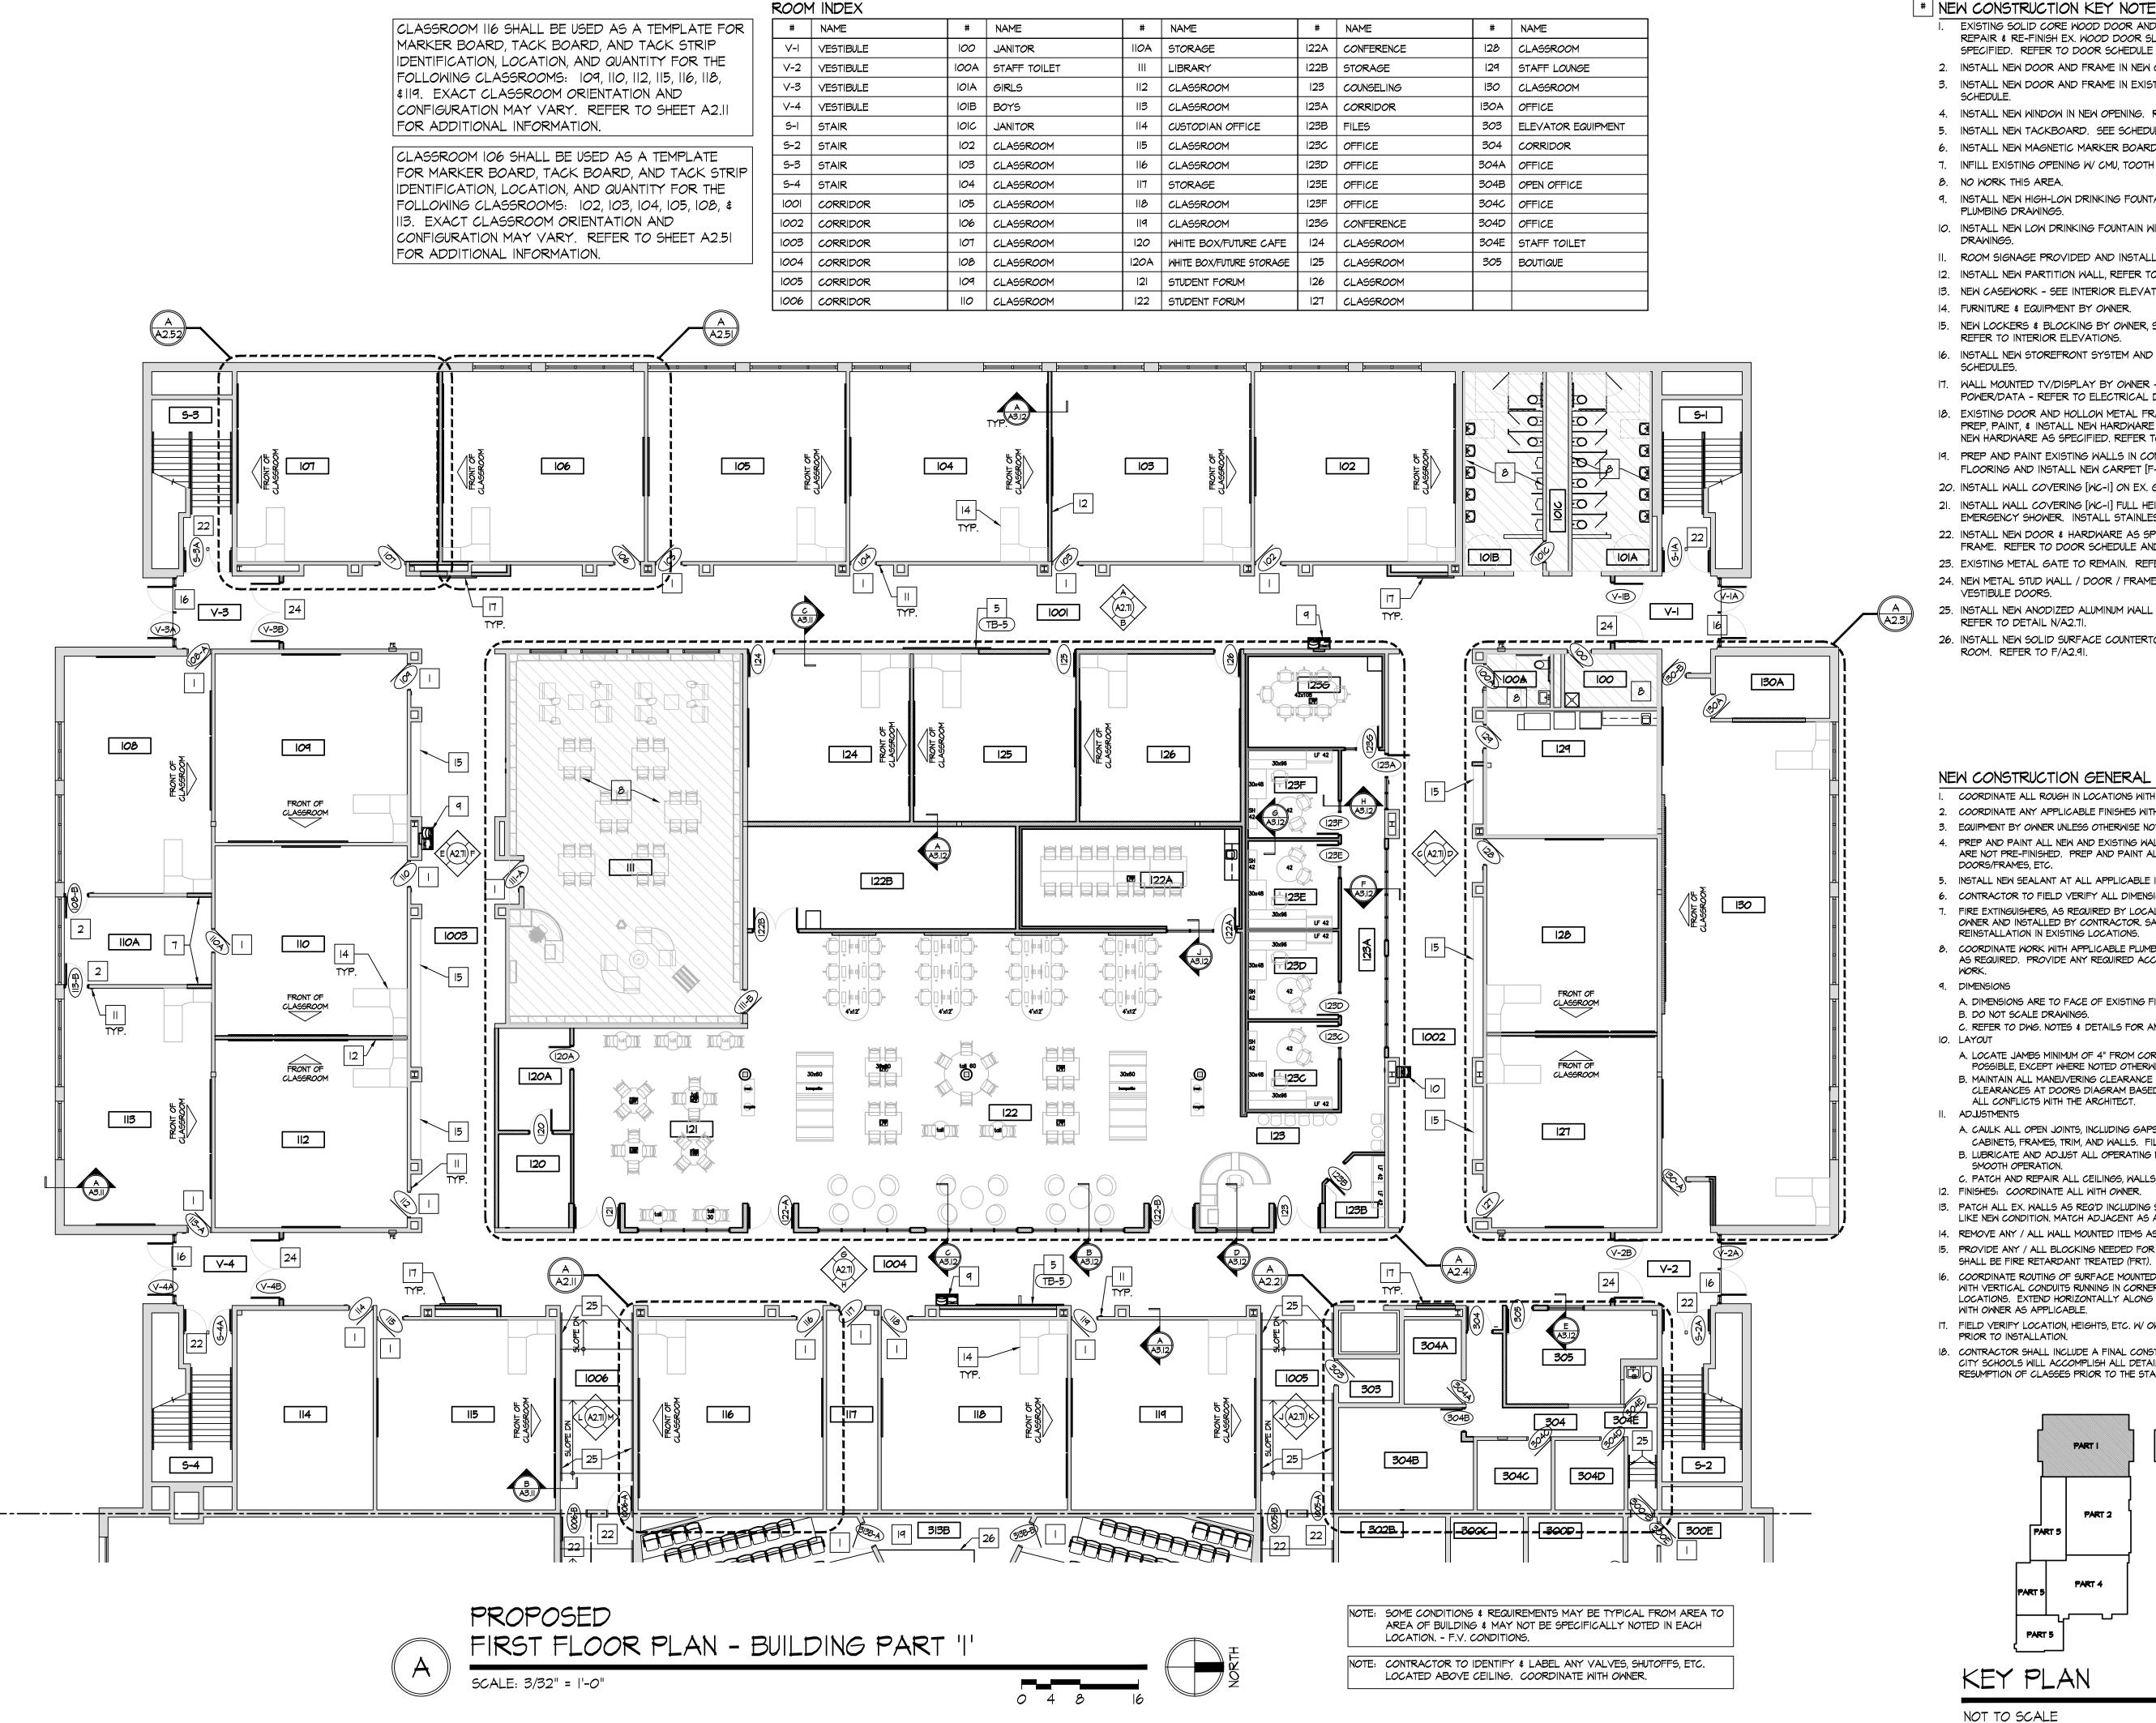
PARTIAL STRUCTURAL PLAN PART 'I'

Sheet Number





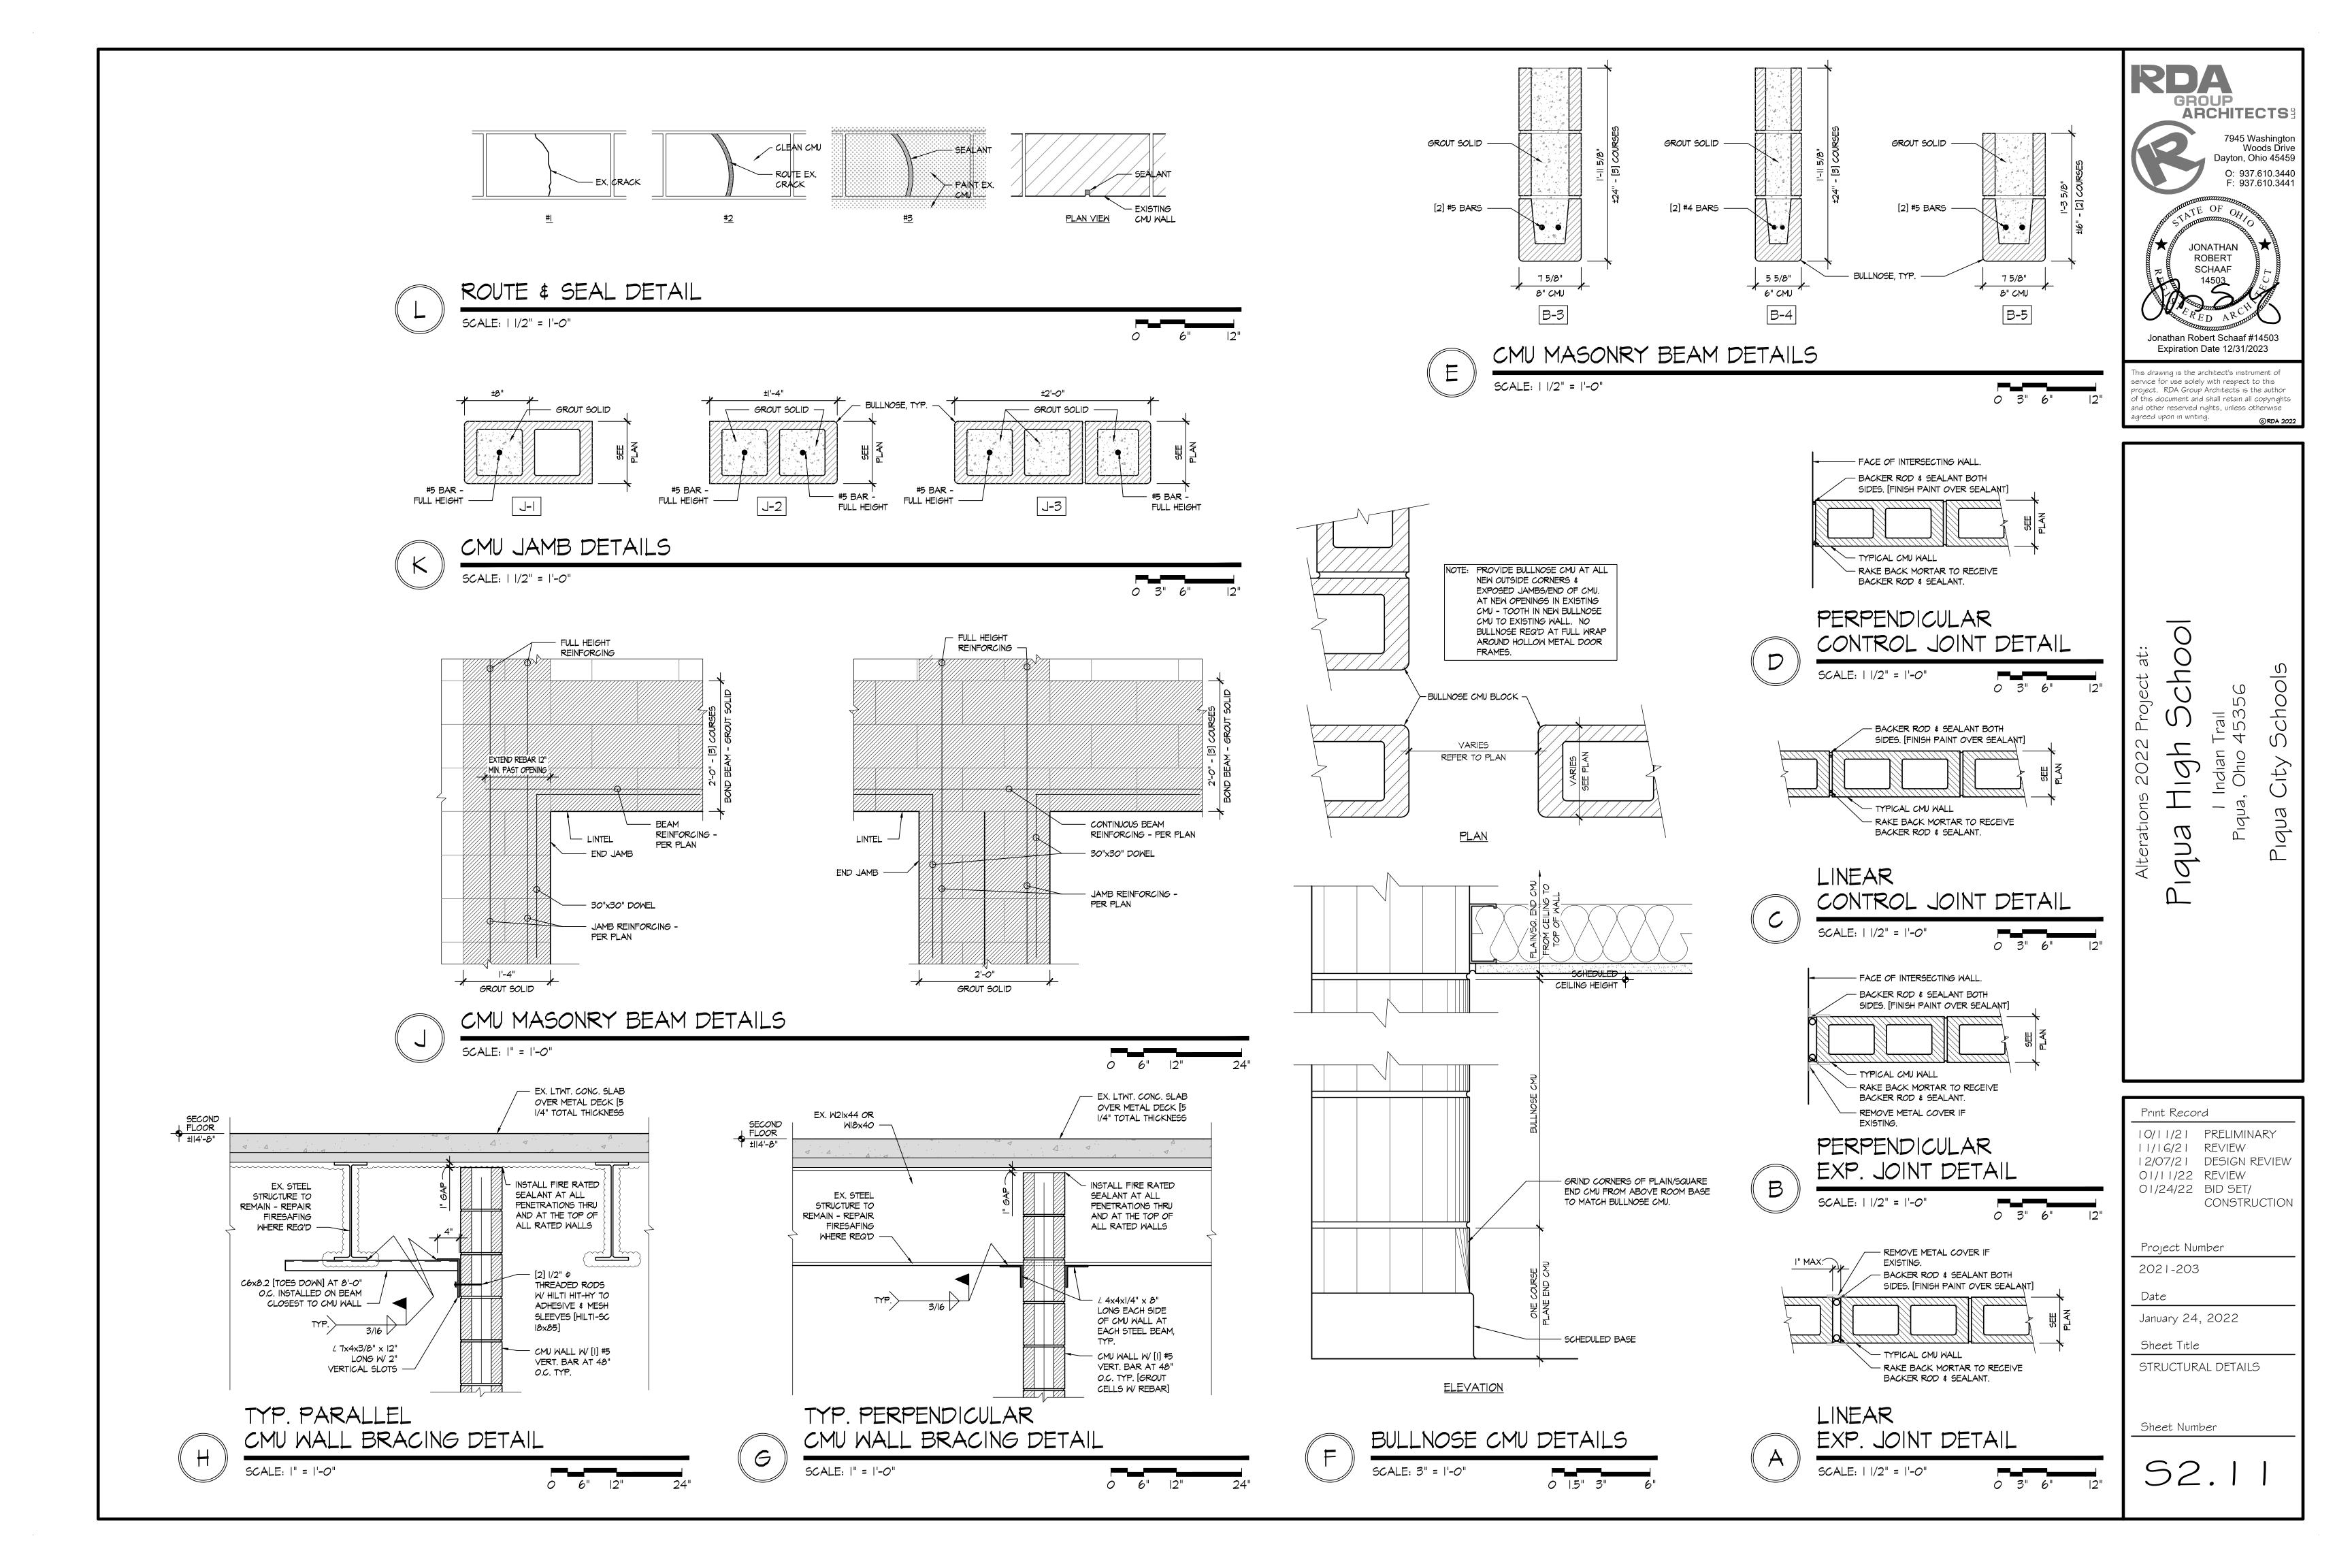

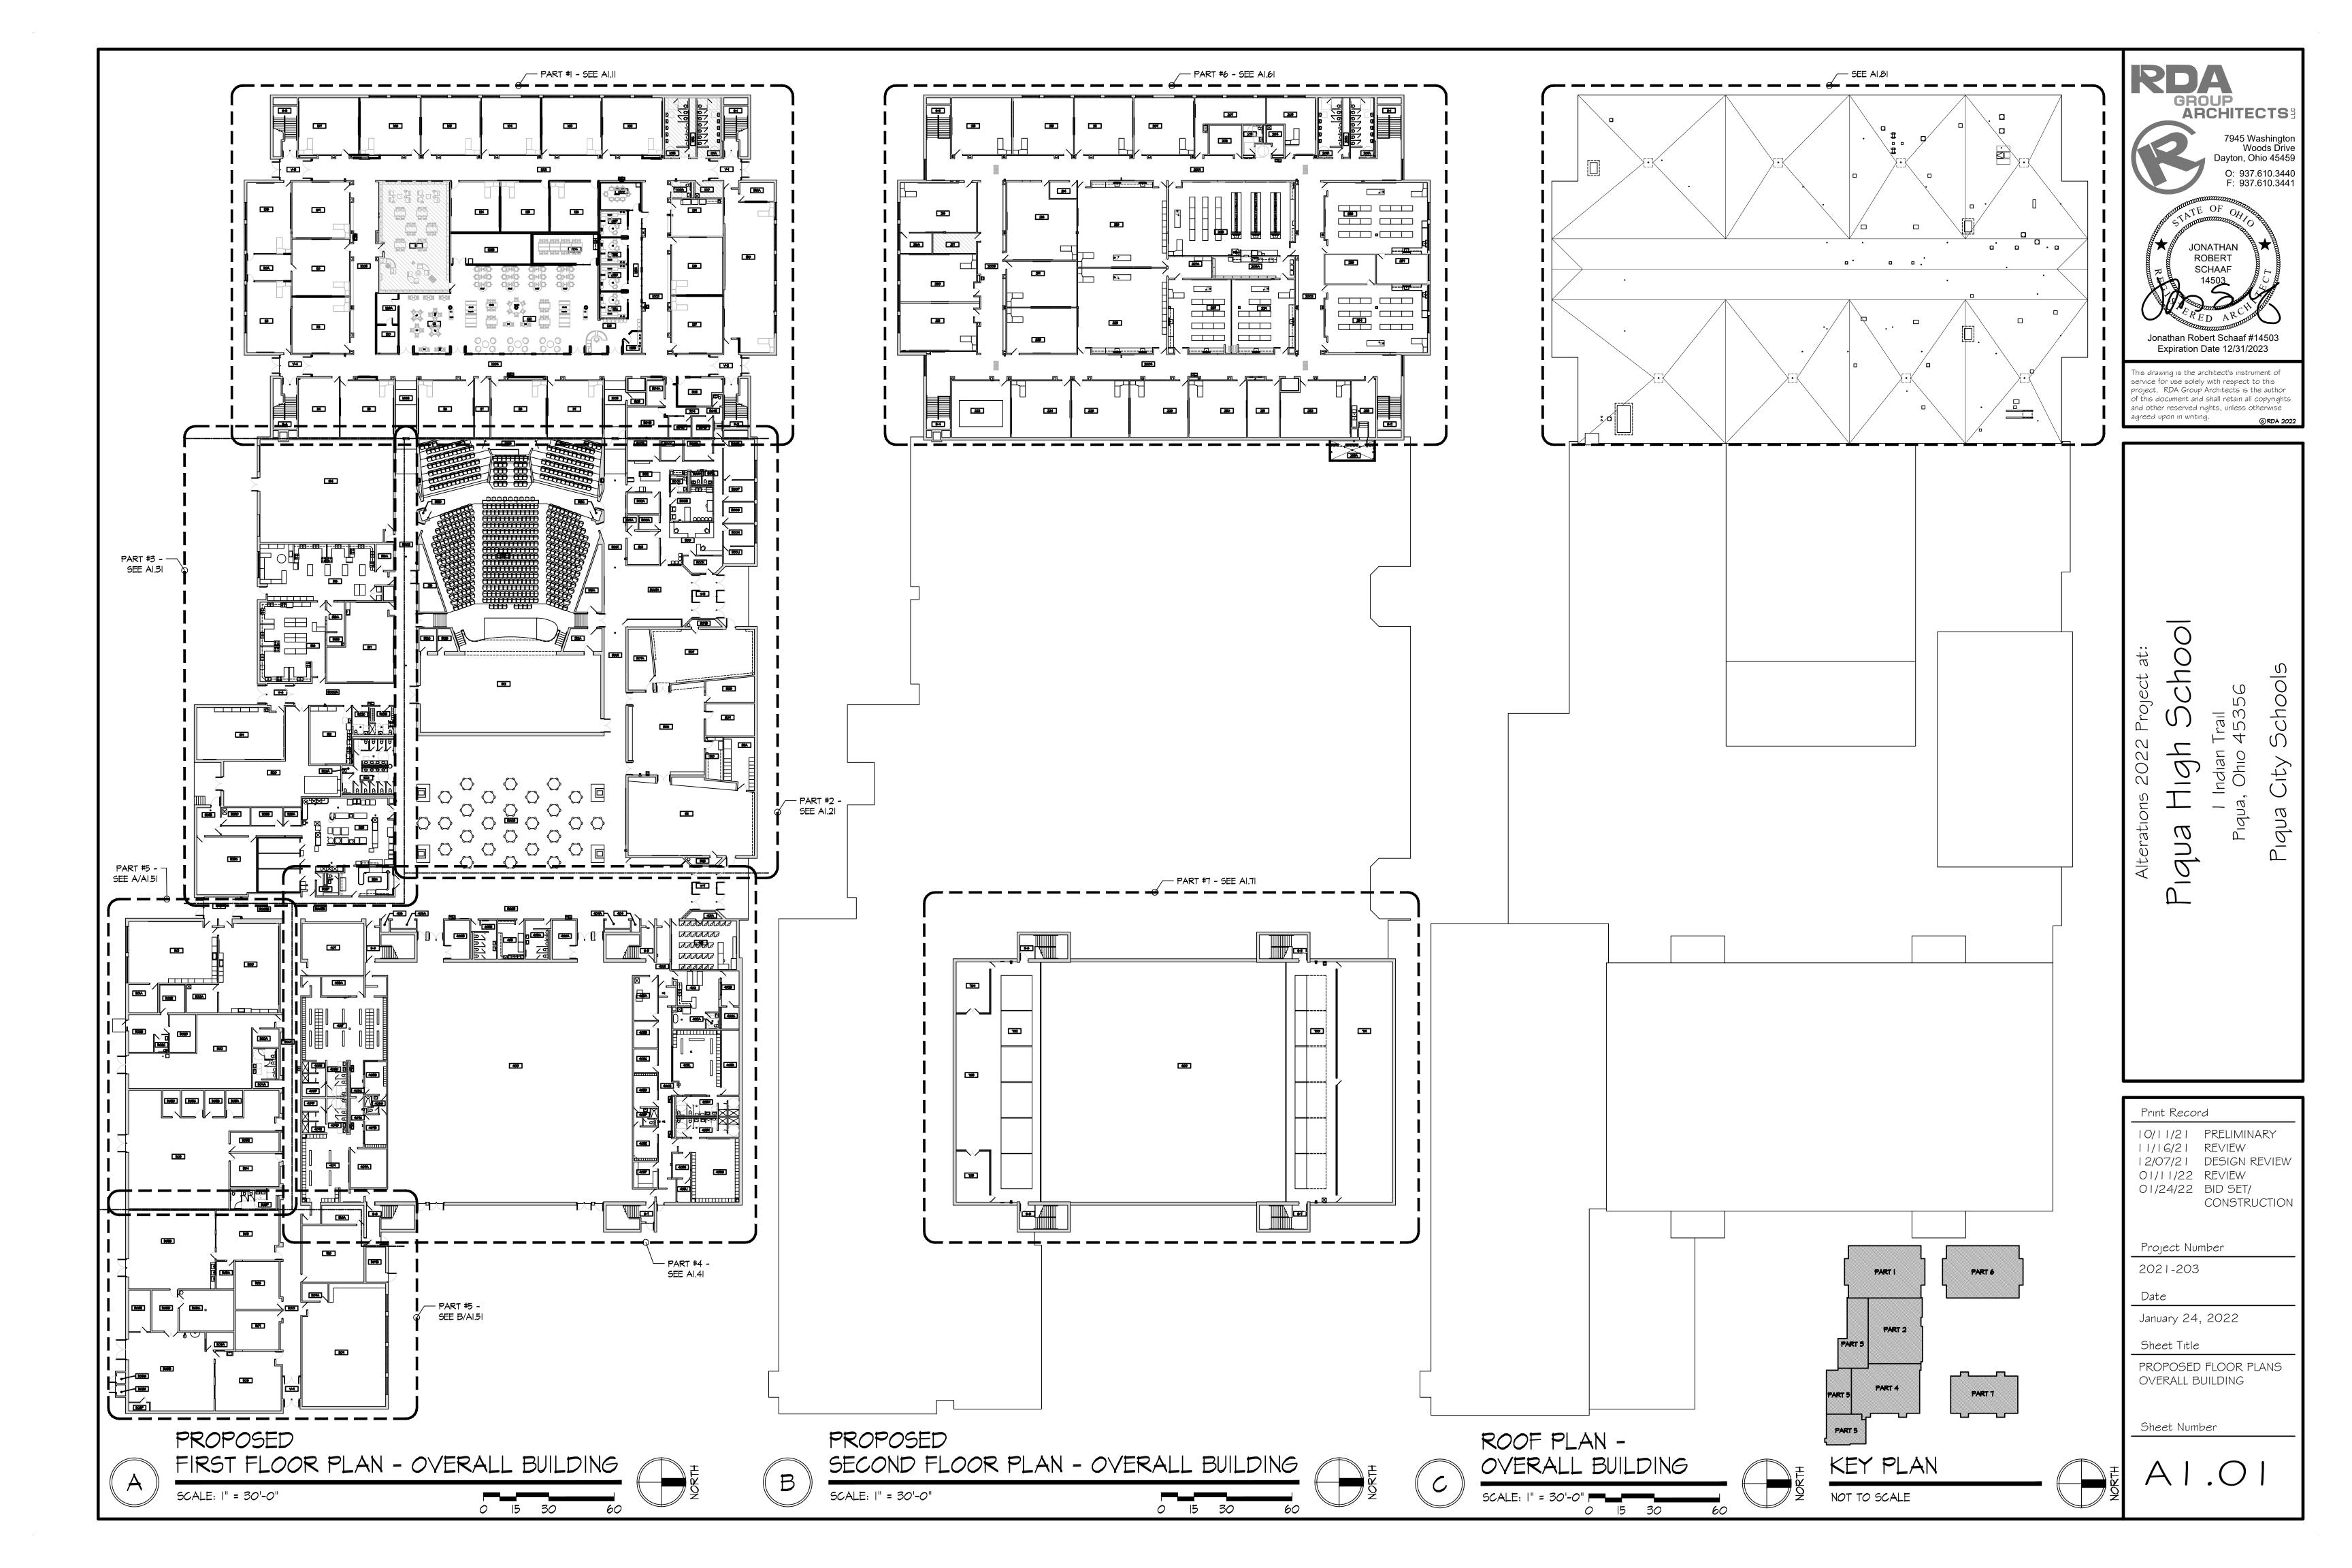


| NEW CONSTRUCTION KEY NOTES

- EXISTING SOLID CORE WOOD DOOR AND HOLLOW METAL FRAME TO REMAIN. REPAIR & RE-FINISH EX. WOOD DOOR SLAB AND INSTALL NEW HARDWARE AS SPECIFIED. REFER TO DOOR SCHEDULE AND SPECIFICATIONS.
- 2. INSTALL NEW DOOR AND FRAME IN NEW OPENING. REFER TO DOOR SCHEDULE.
- 3. INSTALL NEW DOOR AND FRAME IN EXISTING OPENING. REFER TO DOOR
- 4. INSTALL NEW WINDOW IN NEW OPENING. REFER TO WINDOW SCHEDULE.
- 5. INSTALL NEW TACKBOARD. SEE SCHEDULE.
- 6. INSTALL NEW MAGNETIC MARKER BOARD. SEE SCHEDULE.
- 7. INFILL EXISTING OPENING W/ CMU, TOOTH INTO EXISTING, MATCH EX. EACH SIDE.
- 9. INSTALL NEW HIGH-LOW DRINKING FOUNTAIN WITH BOTTLE FILLER. REFER TO
- PLUMBING DRAWINGS. 10. INSTALL NEW LOW DRINKING FOUNTAIN WITH BOTTLE FILLER. REFER TO PLUMBING
- DRAWINGS.
- II. ROOM SIGNAGE PROVIDED AND INSTALLED BY OWNER.
- 12. INSTALL NEW PARTITION WALL, REFER TO WALL TYPES.
- 13. NEW CASEWORK SEE INTERIOR ELEVATIONS
- 15. NEW LOCKERS & BLOCKING BY OWNER, SET ON NEW/EXISTING LOCKER BASES. REFER TO INTERIOR ELEVATIONS.
- 16. INSTALL NEW STOREFRONT SYSTEM AND DOOR. REFER TO WINDOW & DOOR
- 17. WALL MOUNTED TV/DISPLAY BY OWNER INSTALLED BY CONTRACTOR, PROVIDE POWER/DATA - REFER TO ELECTRICAL DRAWINGS.
- 18. EXISTING DOOR AND HOLLOW METAL FRAME TO REMAIN. METAL DOORS: REPAIR PREP, PAINT, & INSTALL NEW HARDWARE AS SPECIFIED; WOOD DOORS: INSTALL NEW HARDWARE AS SPECIFIED. REFER TO DOOR SCHEDULE AND SPECIFICATIONS.
- 19. PREP AND PAINT EXISTING WALLS IN CONTROL ROOM [P-6]. REMOVE EXISTING FLOORING AND INSTALL NEW CARPET [F-6].
- 20. INSTALL WALL COVERING [WC-I] ON EX. GYP. BD. WALL TO 36" A.F.F.
- 21. INSTALL WALL COVERING [WC-I] FULL HEIGHT TO UNDERSIDE OF CEILING AT EMERGENCY SHOWER. INSTALL STAINLESS STEEL WALL CAP FULL HEIGHT.
- 22. INSTALL NEW DOOR & HARDWARE AS SPECIFIED, IN EXISTING HOLLOW METAL FRAME. REFER TO DOOR SCHEDULE AND SPECIFICATIONS.
- 23. EXISTING METAL GATE TO REMAIN. REFER TO INTERIOR ELEVATIONS.
- 24. NEW METAL STUD WALL / DOOR / FRAME / HARDWARE AT LOCATION OF ORIGINAL
- 25. INSTALL NEW ANODIZED ALUMINUM WALL MOUNTED HANDRAILS EA. SIDE OF RAMP. REFER TO DETAIL N/A2.71.
- 26. INSTALL NEW SOLID SURFACE COUNTERTOP AND STEEL SUPPORTS IN CONTROL ROOM. REFER TO F/A2.91.

NEW CONSTRUCTION GENERAL NOTES

- COORDINATE ALL ROUGH IN LOCATIONS WITH EQUIPMENT REQUIREMENTS
- 2. COORDINATE ANY APPLICABLE FINISHES WITH BUILDING STANDARDS.
- 3. EQUIPMENT BY OWNER UNLESS OTHERWISE NOTED.
- 4. PREP AND PAINT ALL NEW AND EXISTING WALL/CEILING FINISHES THAT REQUIRE PAINT AND ARE NOT PRE-FINISHED. PREP AND PAINT ALL NEW AND EXISTING HOLLOW METAL DOORS/FRAMES, ETC.
- 5. INSTALL NEW SEALANT AT ALL APPLICABLE INTERIOR AND EXTERIOR JOINTS.
- 6. CONTRACTOR TO FIELD VERIFY ALL DIMENSIONS & CONDITIONS.
- 7. FIRE EXTINGUISHERS, AS REQUIRED BY LOCAL FIRE DEPARTMENT, TO BE PROVIDED BY THE OWNER AND INSTALLED BY CONTRACTOR. SALVAGE EXISTING FIRE EXTINGUISHERS FOR REINSTALLATION IN EXISTING LOCATIONS.
- 8. COORDINATE WORK WITH APPLICABLE PLUMBING, MECHANICAL, AND ELECTRICAL DRAWINGS AS REQUIRED. PROVIDE ANY REQUIRED ACCESS PANELS, ETC. TO ACCESS CONCEALED
- 9. DIMENSIONS
- A. DIMENSIONS ARE TO FACE OF EXISTING FINISHES AND TO FACE OF MASONRY. B. DO NOT SCALE DRAWINGS.
- C. REFER TO DWG. NOTES & DETAILS FOR ANY SPECIAL NOTES THAT GOVERN LAYOUT.
- A. LOCATE JAMBS MINIMUM OF 4" FROM CORNER TO OUTSIDE EDGE OF FRAME WHERE
- POSSIBLE, EXCEPT WHERE NOTED OTHERWISE B. MAINTAIN ALL MANEUVERING CLEARANCE FOR ALL DOORS PER "MANEUVERING CLEARANCES AT DOORS DIAGRAM BASED UPON FIGURE 404.2.3.2 ANSI. COORDINATE ALL CONFLICTS WITH THE ARCHITECT.
- A. CAULK ALL OPEN JOINTS, INCLUDING GAPS BETWEEN COUNTERTOPS,
- CABINETS, FRAMES, TRIM, AND WALLS. FILL ALL JOINTS SLIGHTLY CONCAVE.
- B. LUBRICATE AND ADJUST ALL OPERATING MECHANISMS, INCLUDING DOOR HARDWARE, FOR
- C. PATCH AND REPAIR ALL CEILINGS, WALLS, ETC. WHERE REQUIRED / IMPACTED BY WORK. 12. FINISHES: COORDINATE ALL WITH OWNER.
- 13. PATCH ALL EX. WALLS AS REQ'D INCLUDING SCARS FROM DEMOLITION, NEW WIRING, ETC. 1
- LIKE NEW CONDITION. MATCH ADJACENT AS APPLICABLE. 14. REMOVE ANY / ALL WALL MOUNTED ITEMS AS REQ'D FOR NEW PAINTING.
- 15. PROVIDE ANY / ALL BLOCKING NEEDED FOR INSTALLATION. ALL BLOCKING & FURRING
- 16. COORDINATE ROUTING OF SURFACE MOUNTED CONDUITS, ETC. TO MINIMIZE IMPACT ON WALLS WITH VERTICAL CONDUITS RUNNING IN CORNERS OR OTHERWISE NOT OBJECTIONABLE LOCATIONS. EXTEND HORIZONTALLY ALONG WALL TO FEED DEVICES. FIELD COORDINATE WITH OWNER AS APPLICABLE.
- 17. FIELD VERIFY LOCATION, HEIGHTS, ETC. W/ OWNER OF TACK BOARDS AND MARKERBOARDS PRIOR TO INSTALLATION.
- 18. CONTRACTOR SHALL INCLUDE A FINAL CONSTRUCTION CLEAN IN THE BID AMOUNT. PIQUA CITY SCHOOLS WILL ACCOMPLISH ALL DETAILED CLEANING NECESSARY FOR THE RESUMPTION OF CLASSES PRIOR TO THE START OF SCHOOL IN THE FALL.

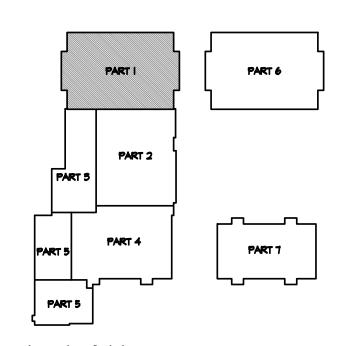

KEY PLAN

12/07/21 DESIGN REVIEW 01/11/22 REVIEW 01/24/22 BID SET/ CONSTRUCTION Project Number 2021-203 Date January 24, 2022 Sheet Title PROPOSED FIRST FLOOR PLAN PART 'I' Sheet Number

10/11/21 PRELIMINARY

11/16/21 REVIEW

Print Record

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Expiration Date 12/31/2023

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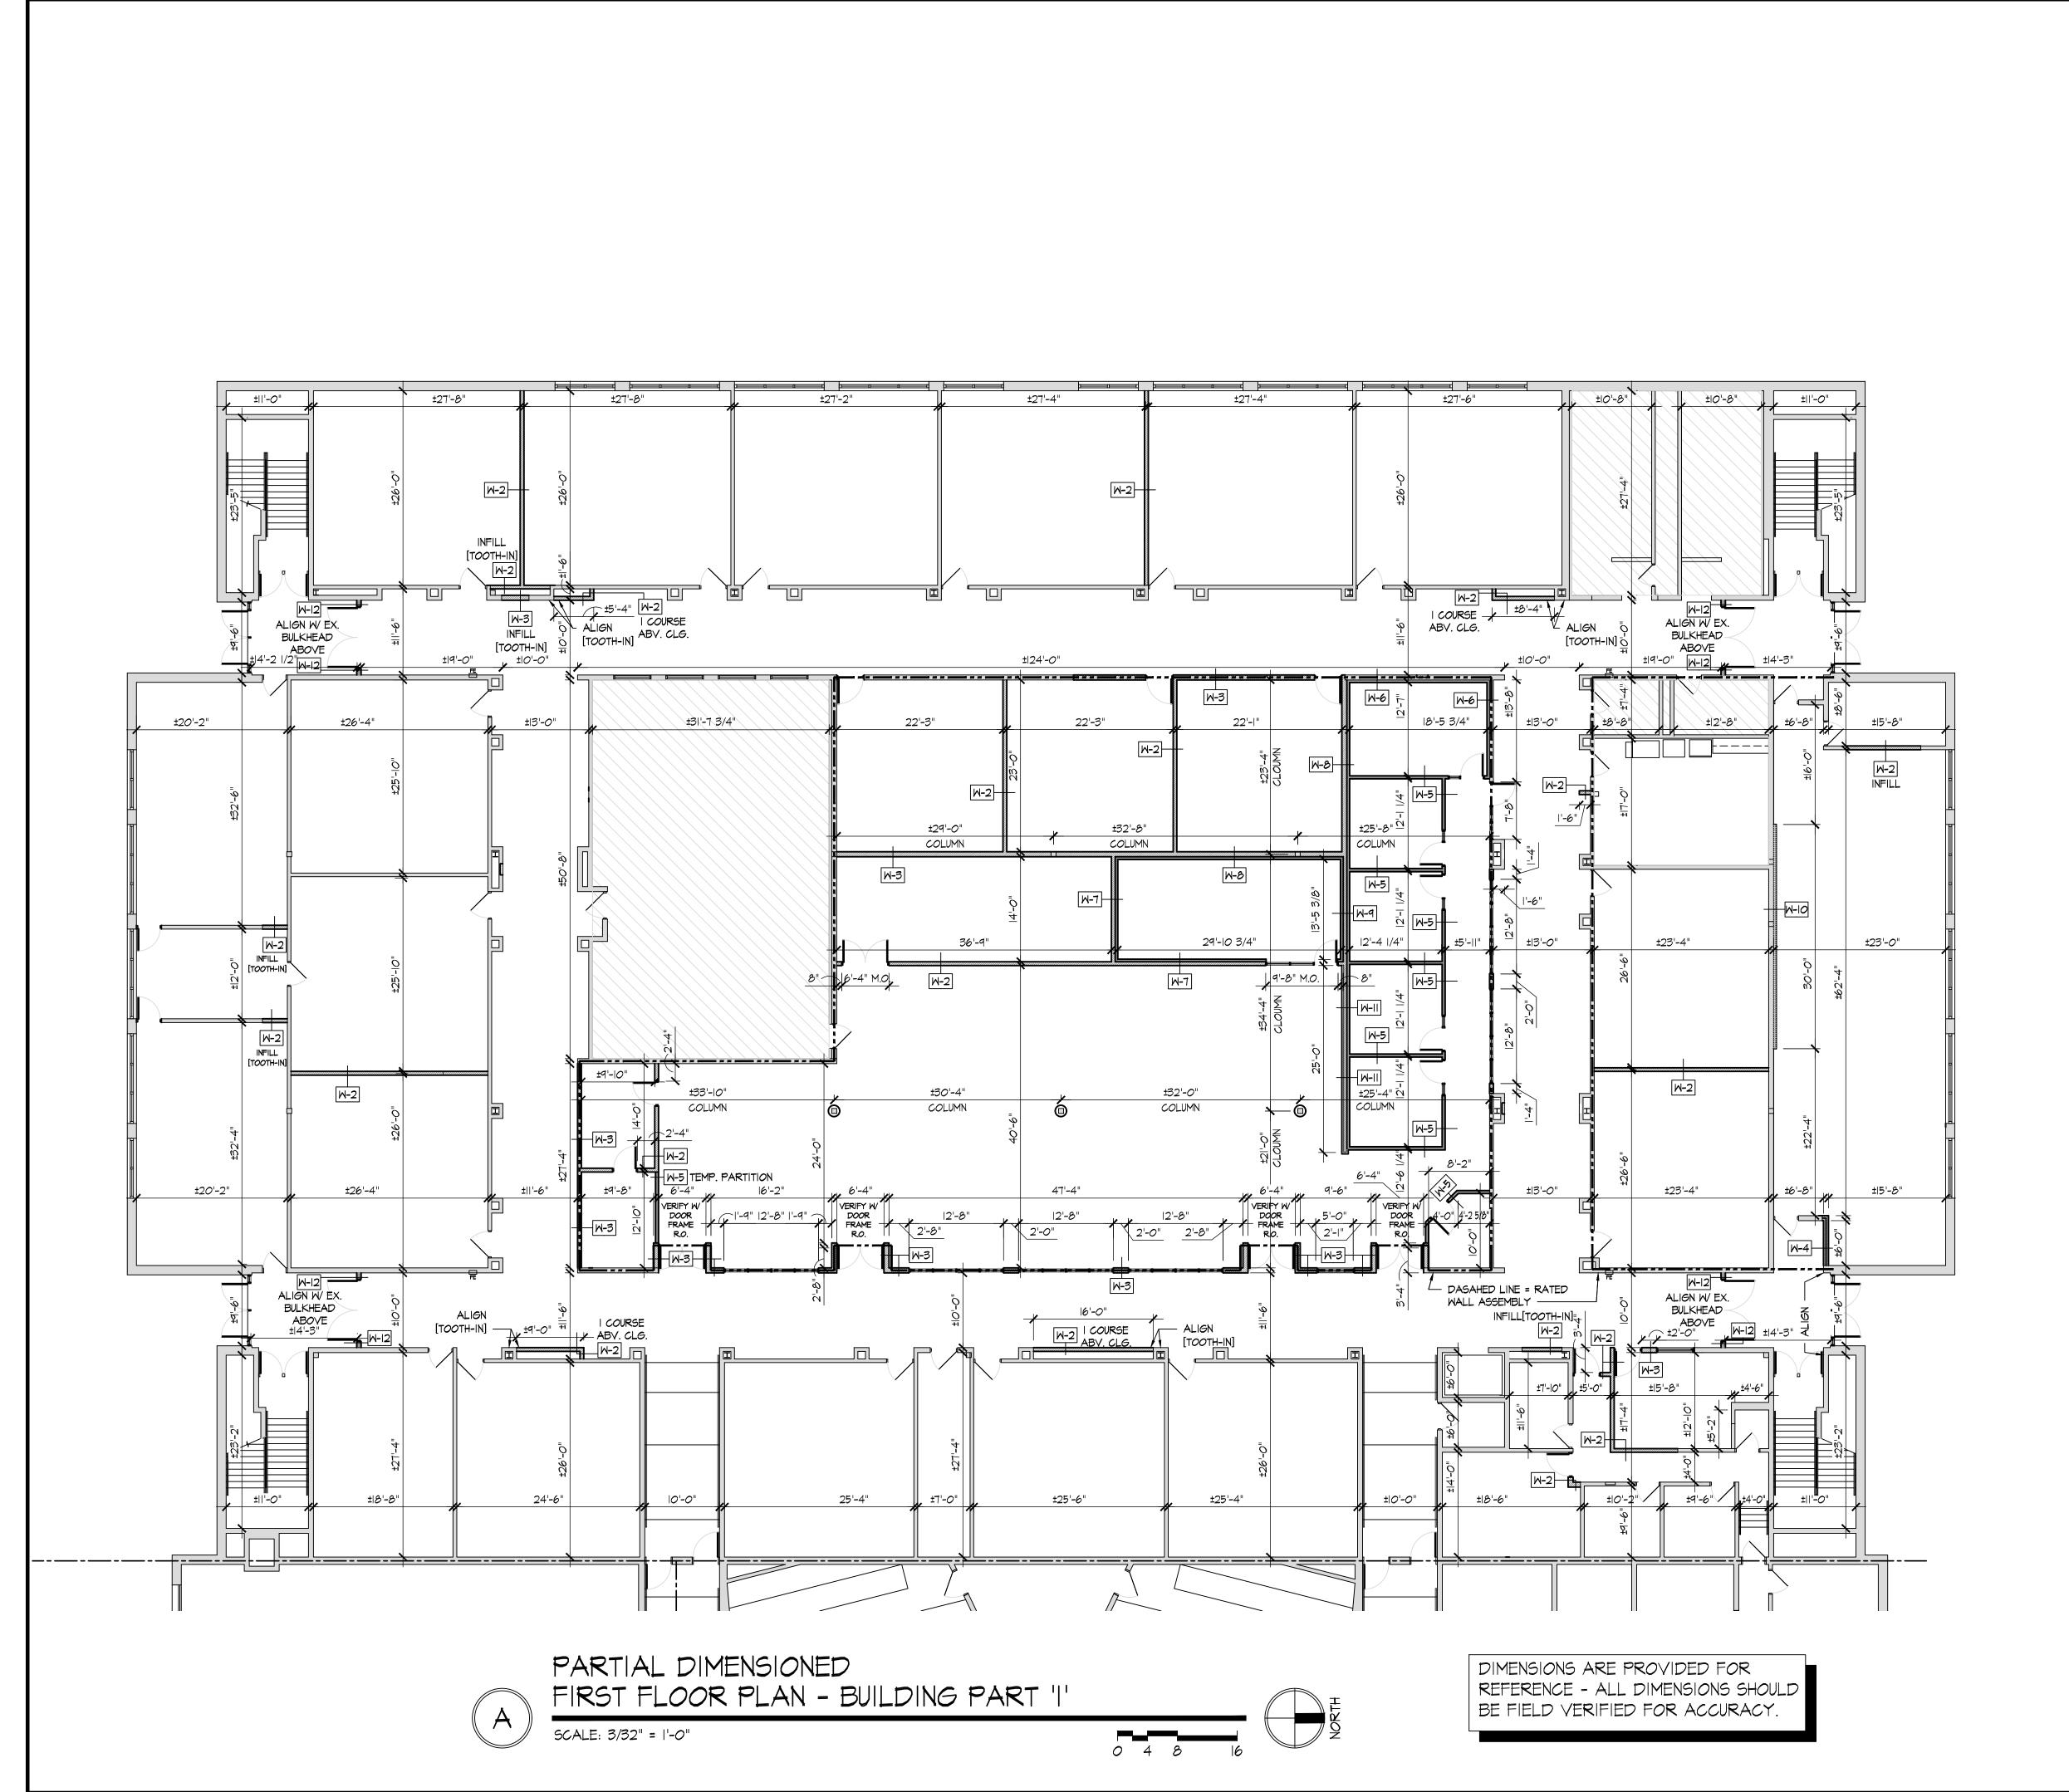
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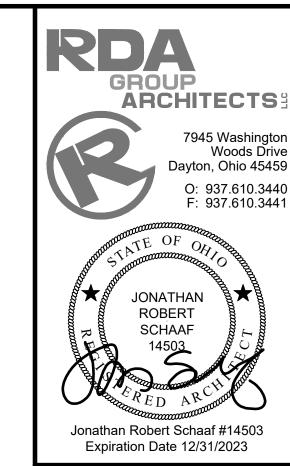
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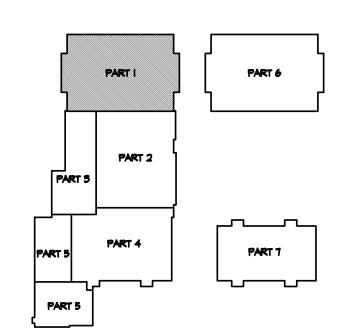
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NOTE: TOOTH NEW MASONRY INTO EXISTING TYP. ALL AREAS. ALIGN NEW MASONRY W/ EXISTING PER DESIGN INTENT INDICATED - FIELD COORD. W/ ARCHITECT AS REQ'D.



KEY PLAN


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11/16/21 REVIEW 12/07/21 DESIGN REVIEW 01/11/22 REVIEW 01/24/22 BID SET/ CONSTRUCTION Project Number 2021-203 Date January 24, 2022 Sheet Title DIMENSIONED FIRST FLOOR PLAN PART 'I' Sheet Number

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(#) REFLECTED CEILING KEY NOTES

INSTALL NEW 2x2 CEILING GRID AND ACOUSTIC CEILING TILES. REFER TO PLAN

2. EXISTING 2x4 CEILING GRID. INSTALL NEW GRID T-BAR TO CREATE 2x2 GRID.

PAINT EXISTING/NEW CEILING GRID. INSTALL NEW 2x2 ACOUSTIC CEILING TILES.

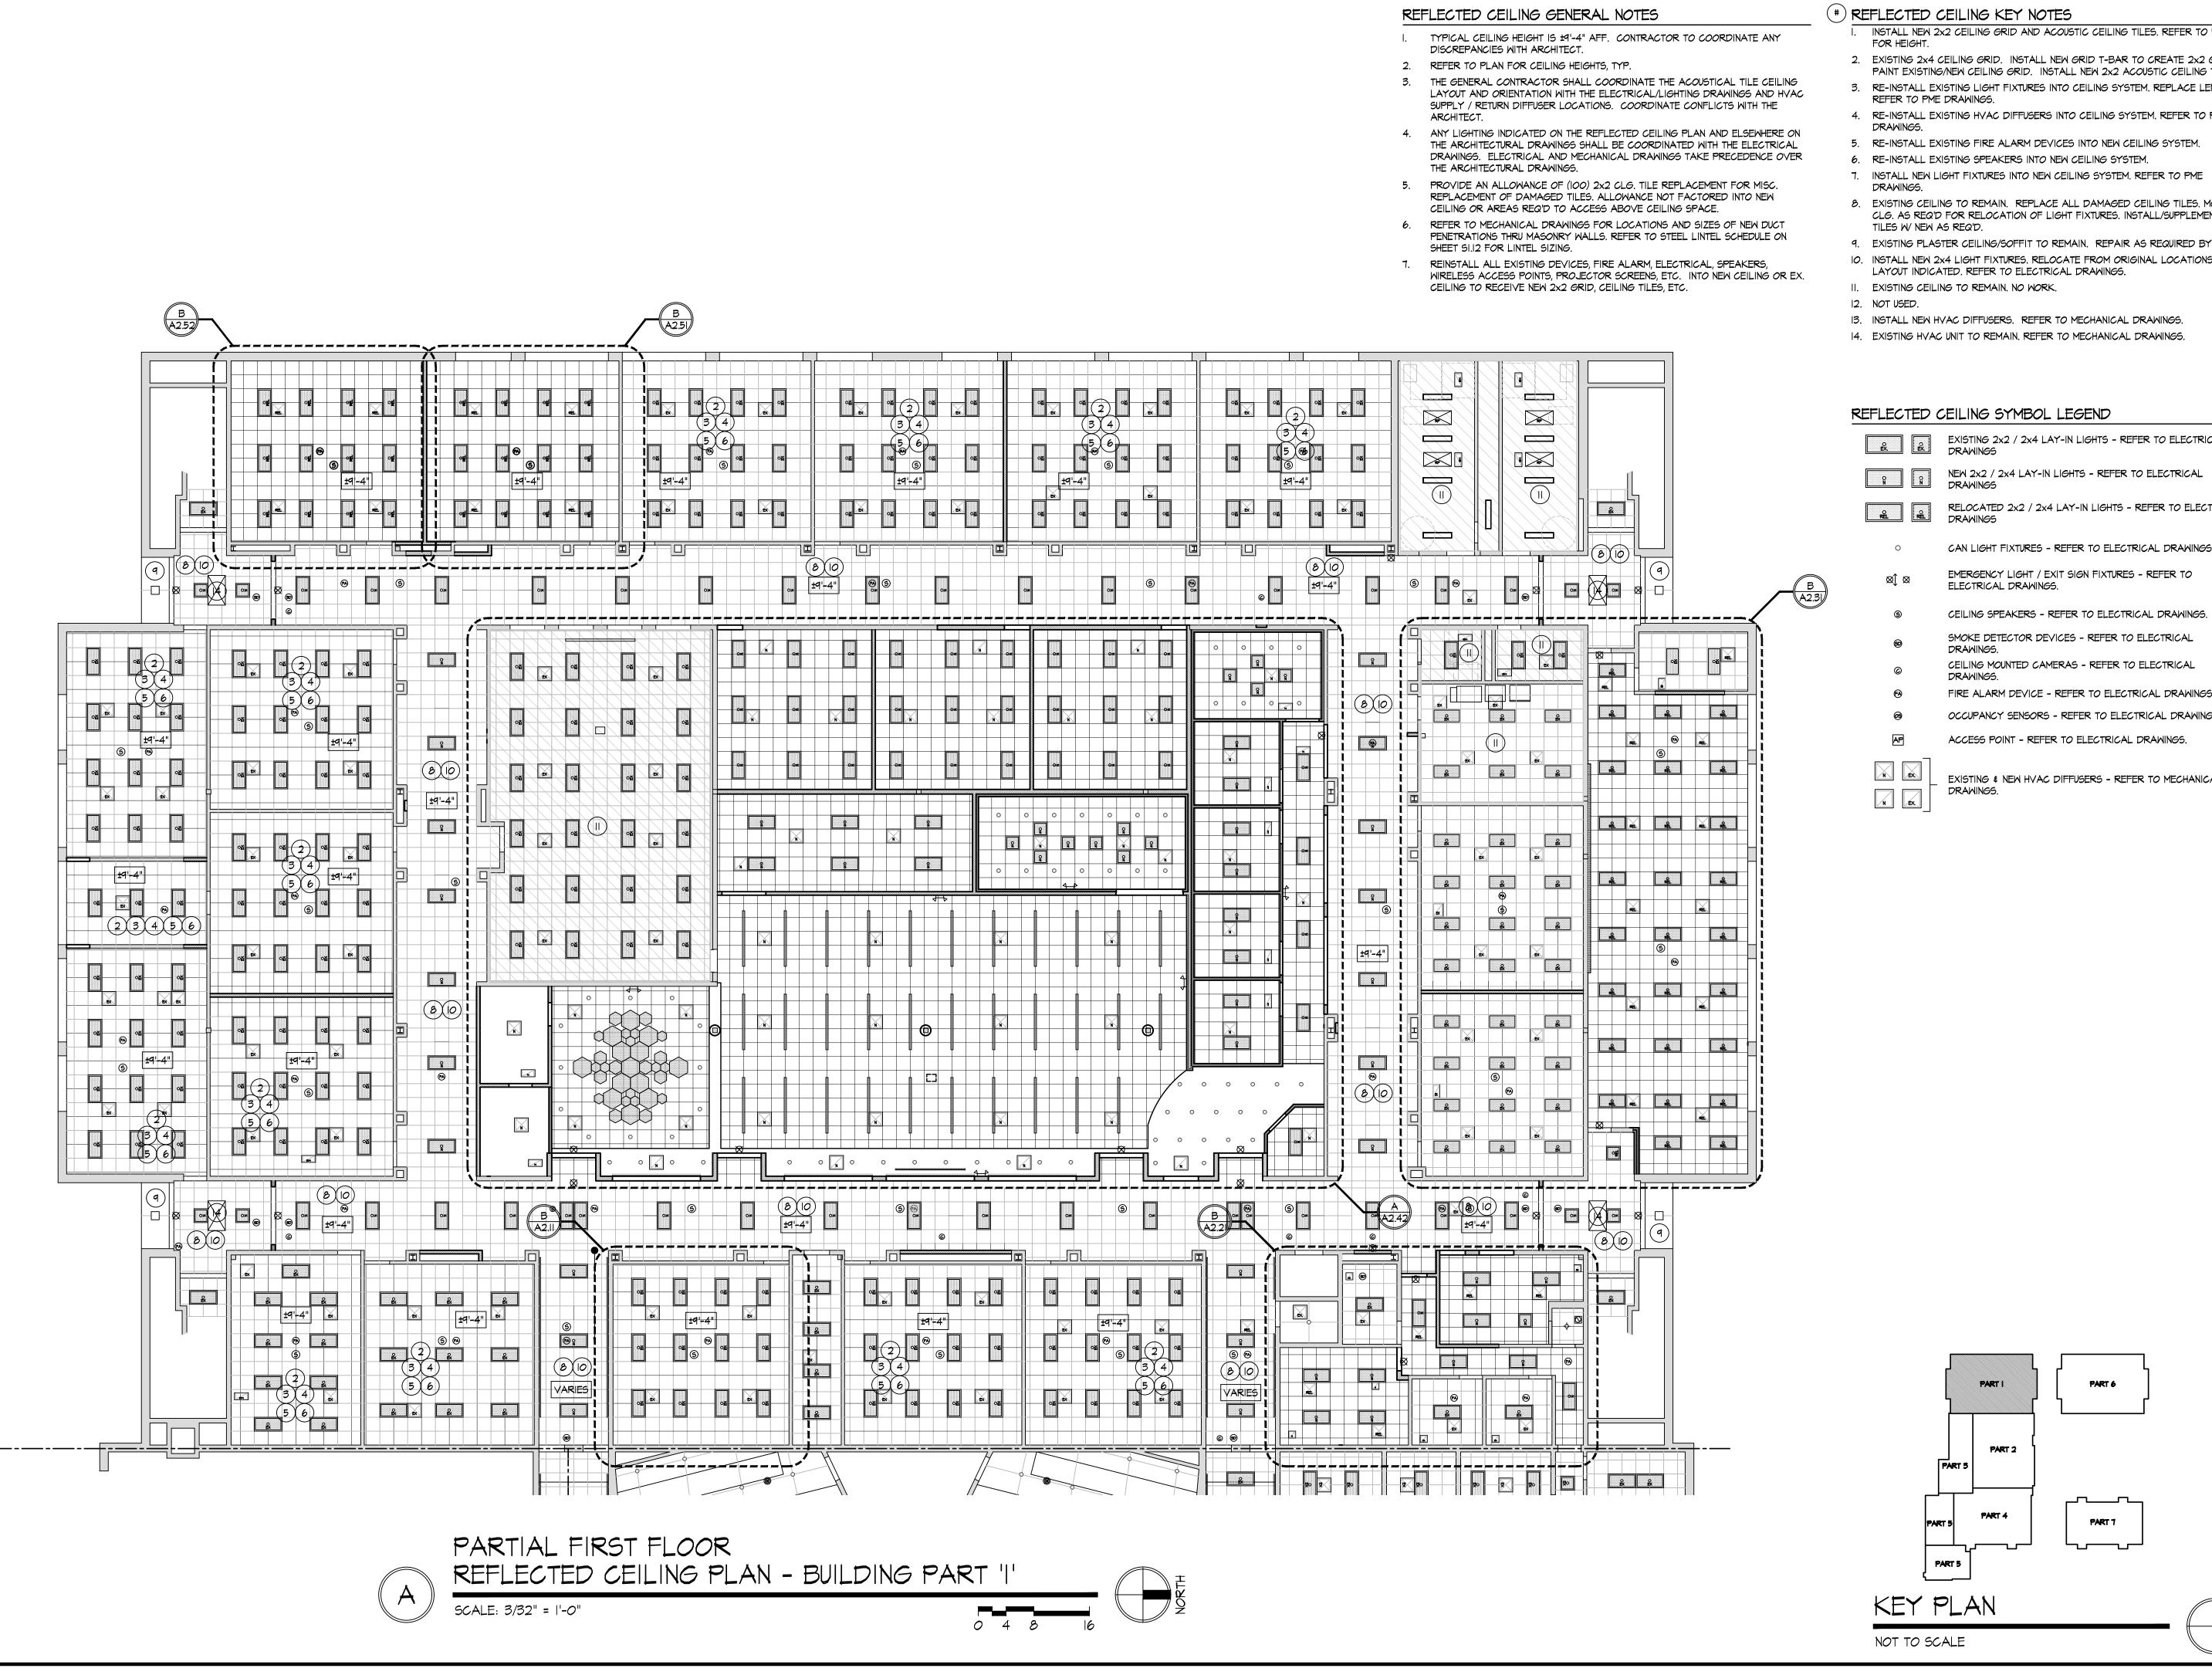3. RE-INSTALL EXISTING LIGHT FIXTURES INTO CEILING SYSTEM. REPLACE LENS.

4. RE-INSTALL EXISTING HVAC DIFFUSERS INTO CEILING SYSTEM. REFER TO PME

5. RE-INSTALL EXISTING FIRE ALARM DEVICES INTO NEW CEILING SYSTEM.

6. RE-INSTALL EXISTING SPEAKERS INTO NEW CEILING SYSTEM.

7. INSTALL NEW LIGHT FIXTURES INTO NEW CEILING SYSTEM. REFER TO PME 8. EXISTING CEILING TO REMAIN. REPLACE ALL DAMAGED CEILING TILES. MODIFY

CLG. AS REQ'D FOR RELOCATION OF LIGHT FIXTURES. INSTALL/SUPPLEMENT CLG.

9. EXISTING PLASTER CEILING/SOFFIT TO REMAIN. REPAIR AS REQUIRED BY WORK, 10. INSTALL NEW 2x4 LIGHT FIXTURES. RELOCATE FROM ORIGINAL LOCATIONS TO

LAYOUT INDICATED. REFER TO ELECTRICAL DRAWINGS.

13. INSTALL NEW HVAC DIFFUSERS. REFER TO MECHANICAL DRAWINGS.

EXISTING 2x2 / 2x4 LAY-IN LIGHTS - REFER TO ELECTRICAL

NEW 2x2 / 2x4 LAY-IN LIGHTS - REFER TO ELECTRICAL

RELOCATED 2x2 / 2x4 LAY-IN LIGHTS - REFER TO ELECTRICAL

CAN LIGHT FIXTURES - REFER TO ELECTRICAL DRAWINGS.

SMOKE DETECTOR DEVICES - REFER TO ELECTRICAL

CEILING MOUNTED CAMERAS - REFER TO ELECTRICAL

OCCUPANCY SENSORS - REFER TO ELECTRICAL DRAWINGS.


ACCESS POINT - REFER TO ELECTRICAL DRAWINGS.

EXISTING & NEW HVAC DIFFUSERS - REFER TO MECHANICAL

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Project Number

01/24/22 BID SET/

2021-203

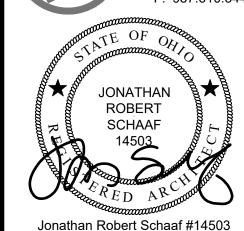Date

January 24, 2022


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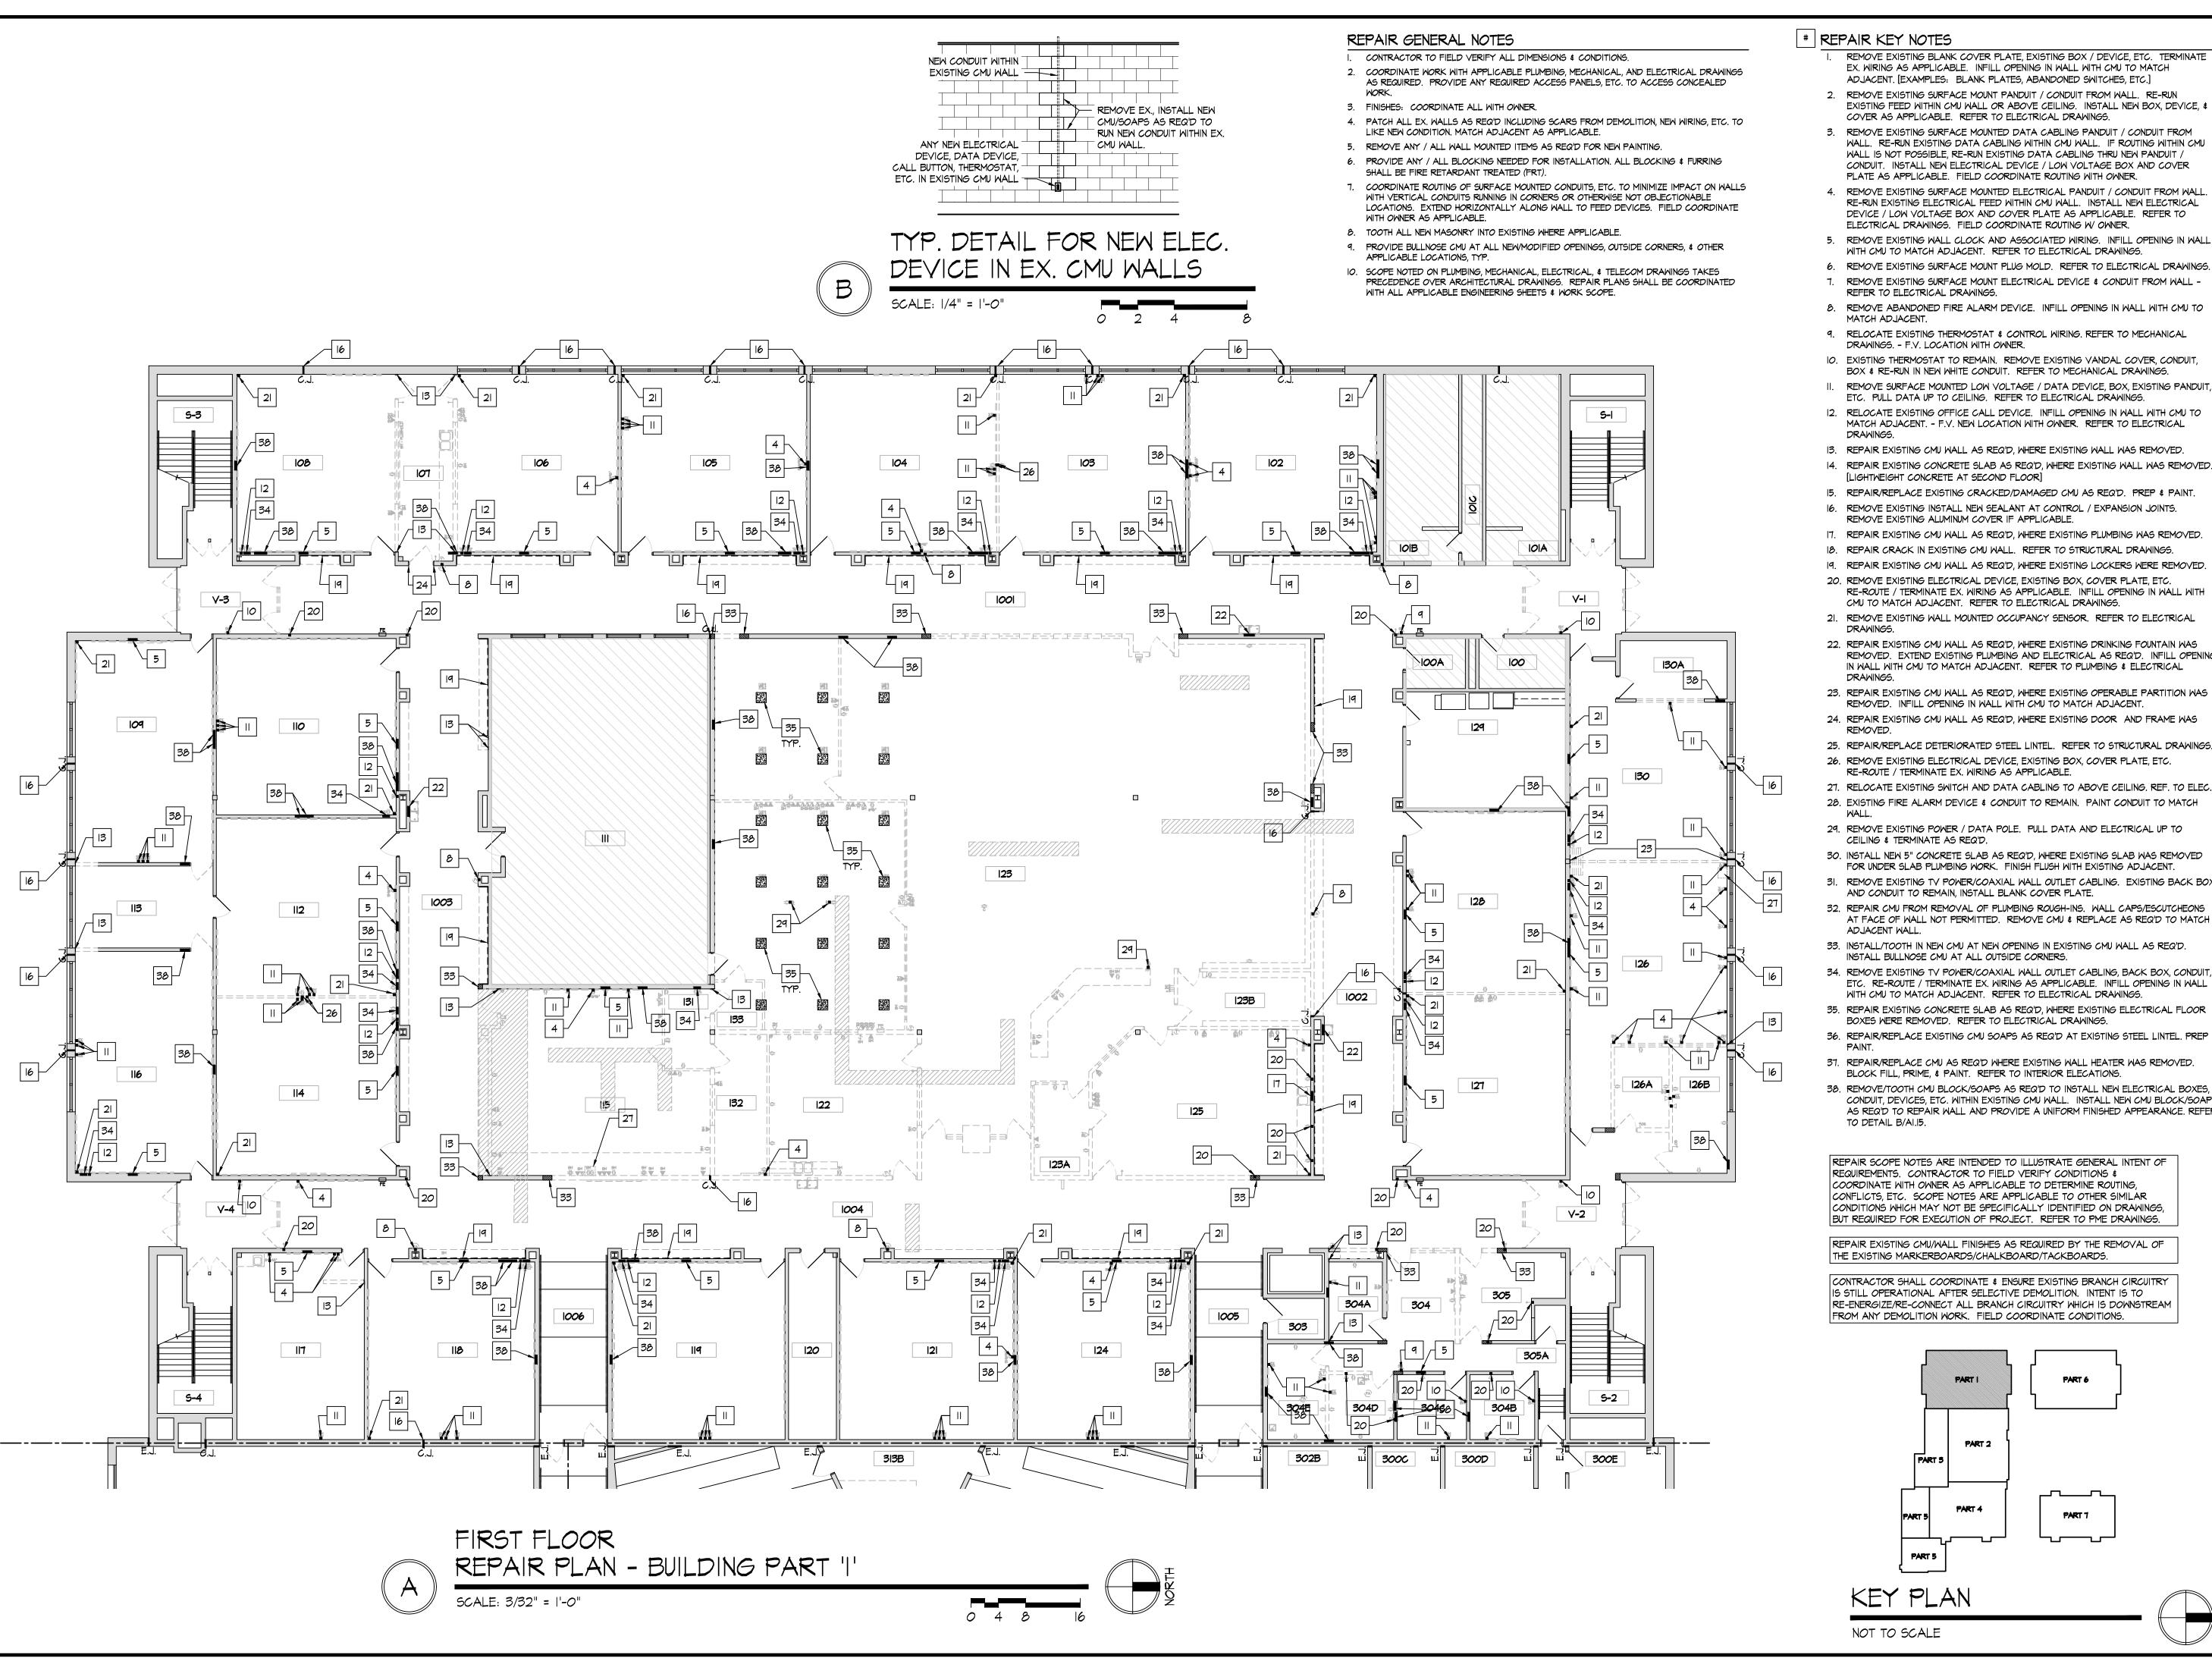
FIRST FLOOR REFLECTED CEILING PLAN PART 'I'

Sheet Number

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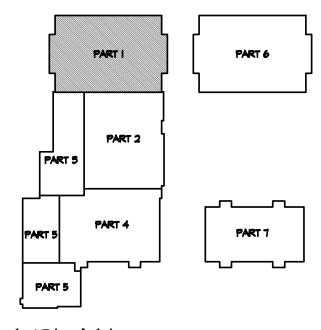
REPAIR KEY NOTES

- REMOVE EXISTING BLANK COVER PLATE, EXISTING BOX / DEVICE, ETC. TERMINATE EX. WIRING AS APPLICABLE. INFILL OPENING IN WALL WITH CMU TO MATCH ADJACENT. [EXAMPLES: BLANK PLATES, ABANDONED SWITCHES, ETC.]
- 2. REMOVE EXISTING SURFACE MOUNT PANDUIT / CONDUIT FROM WALL. RE-RUN EXISTING FEED WITHIN CMU WALL OR ABOVE CEILING. INSTALL NEW BOX, DEVICE, \$ COVER AS APPLICABLE. REFER TO ELECTRICAL DRAWINGS.
- 3. REMOVE EXISTING SURFACE MOUNTED DATA CABLING PANDUIT / CONDUIT FROM WALL. RE-RUN EXISTING DATA CABLING WITHIN CMU WALL. IF ROUTING WITHIN CMU WALL IS NOT POSSIBLE, RE-RUN EXISTING DATA CABLING THRU NEW PANDUIT / CONDUIT. INSTALL NEW ELECTRICAL DEVICE / LOW VOLTAGE BOX AND COVER PLATE AS APPLICABLE. FIELD COORDINATE ROUTING WITH OWNER.
- 4. REMOVE EXISTING SURFACE MOUNTED ELECTRICAL PANDUIT / CONDUIT FROM WALL. RE-RUN EXISTING ELECTRICAL FEED WITHIN CMU WALL. INSTALL NEW ELECTRICAL DEVICE / LOW VOLTAGE BOX AND COVER PLATE AS APPLICABLE. REFER TO
- ELECTRICAL DRAWINGS. FIELD COORDINATE ROUTING W/ OWNER. 5. REMOVE EXISTING WALL CLOCK AND ASSOCIATED WIRING. INFILL OPENING IN WALL
- WITH CMU TO MATCH ADJACENT. REFER TO ELECTRICAL DRAWINGS. 6. REMOVE EXISTING SURFACE MOUNT PLUG MOLD. REFER TO ELECTRICAL DRAWINGS.
- 7. REMOVE EXISTING SURFACE MOUNT ELECTRICAL DEVICE & CONDUIT FROM WALL -REFER TO ELECTRICAL DRAWINGS.
- 8. REMOVE ABANDONED FIRE ALARM DEVICE. INFILL OPENING IN WALL WITH CMU TO
- 9. RELOCATE EXISTING THERMOSTAT & CONTROL WIRING. REFER TO MECHANICAL DRAWINGS. - F.V. LOCATION WITH OWNER.
- IO. EXISTING THERMOSTAT TO REMAIN. REMOVE EXISTING VANDAL COVER, CONDUIT, BOX & RE-RUN IN NEW WHITE CONDUIT. REFER TO MECHANICAL DRAWINGS.
- REMOVE SURFACE MOUNTED LOW VOLTAGE / DATA DEVICE, BOX, EXISTING PANDUIT, ETC. PULL DATA UP TO CEILING. REFER TO ELECTRICAL DRAWINGS.
- 12. RELOCATE EXISTING OFFICE CALL DEVICE. INFILL OPENING IN WALL WITH CMU TO MATCH ADJACENT. - F.V. NEW LOCATION WITH OWNER. REFER TO ELECTRICAL
- 13. REPAIR EXISTING CMU WALL AS REQ'D, WHERE EXISTING WALL WAS REMOVED.
- [LIGHTWEIGHT CONCRETE AT SECOND FLOOR] 15. REPAIR/REPLACE EXISTING CRACKED/DAMAGED CMU AS REQ'D. PREP & PAINT.
- 16. REMOVE EXISTING INSTALL NEW SEALANT AT CONTROL / EXPANSION JOINTS. REMOVE EXISTING ALUMINUM COVER IF APPLICABLE.
- 17. REPAIR EXISTING CMU WALL AS REQ'D, WHERE EXISTING PLUMBING WAS REMOVED.
- 18. REPAIR CRACK IN EXISTING CMU WALL. REFER TO STRUCTURAL DRAWINGS.
- 19. REPAIR EXISTING CMU WALL AS REQ'D, WHERE EXISTING LOCKERS WERE REMOVED.
- 20. REMOVE EXISTING ELECTRICAL DEVICE, EXISTING BOX, COVER PLATE, ETC. RE-ROUTE / TERMINATE EX. WIRING AS APPLICABLE. INFILL OPENING IN WALL WITH CMU TO MATCH ADJACENT. REFER TO ELECTRICAL DRAWINGS.
- 21. REMOVE EXISTING WALL MOUNTED OCCUPANCY SENSOR. REFER TO ELECTRICAL
- 22. REPAIR EXISTING CMU WALL AS REQ'D, WHERE EXISTING DRINKING FOUNTAIN WAS REMOVED. EXTEND EXISTING PLUMBING AND ELECTRICAL AS REQ'D. INFILL OPENING IN WALL WITH CMU TO MATCH ADJACENT. REFER TO PLUMBING & ELECTRICAL
- 23. REPAIR EXISTING CMU WALL AS REQ'D, WHERE EXISTING OPERABLE PARTITION WAS REMOVED. INFILL OPENING IN WALL WITH CMU TO MATCH ADJACENT.
- 24. REPAIR EXISTING CMU WALL AS REQ'D, WHERE EXISTING DOOR AND FRAME WAS
- 25. REPAIR/REPLACE DETERIORATED STEEL LINTEL. REFER TO STRUCTURAL DRAWINGS.
- 26. REMOVE EXISTING ELECTRICAL DEVICE, EXISTING BOX, COVER PLATE, ETC. RE-ROUTE / TERMINATE EX. WIRING AS APPLICABLE.
- 27. RELOCATE EXISTING SWITCH AND DATA CABLING TO ABOVE CEILING. REF. TO ELEC 28. EXISTING FIRE ALARM DEVICE & CONDUIT TO REMAIN. PAINT CONDUIT TO MATCH
- 29. REMOVE EXISTING POWER / DATA POLE. PULL DATA AND ELECTRICAL UP TO CEILING & TERMINATE AS REQ'D.
- 30. INSTALL NEW 5" CONCRETE SLAB AS REQ'D, WHERE EXISTING SLAB WAS REMOVED FOR UNDER SLAB PLUMBING WORK. FINISH FLUSH WITH EXISTING ADJACENT.
- 31. REMOVE EXISTING TV POWER/COAXIAL WALL OUTLET CABLING. EXISTING BACK BOX, AND CONDUIT TO REMAIN, INSTALL BLANK COVER PLATE.
- 32. REPAIR CMU FROM REMOVAL OF PLUMBING ROUGH-INS. WALL CAPS/ESCUTCHEONS AT FACE OF WALL NOT PERMITTED. REMOVE CMU & REPLACE AS REQ'D TO MATCH
- 33. INSTALL/TOOTH IN NEW CMU AT NEW OPENING IN EXISTING CMU WALL AS REQ'D. INSTALL BULLNOSE CMU AT ALL OUTSIDE CORNERS.
- 34. REMOVE EXISTING TV POWER/COAXIAL WALL OUTLET CABLING, BACK BOX, CONDUIT, ETC. RE-ROUTE / TERMINATE EX. WIRING AS APPLICABLE. INFILL OPENING IN WALL WITH CMU TO MATCH ADJACENT. REFER TO ELECTRICAL DRAWINGS.
- 35. REPAIR EXISTING CONCRETE SLAB AS REQ'D, WHERE EXISTING ELECTRICAL FLOOR BOXES WERE REMOVED. REFER TO ELECTRICAL DRAWINGS.
- 36. REPAIR/REPLACE EXISTING CMU SOAPS AS REQ'D AT EXISTING STEEL LINTEL. PREP \$
- 31. REPAIR/REPLACE CMU AS REQ'D WHERE EXISTING WALL HEATER WAS REMOVED. BLOCK FILL, PRIME, & PAINT. REFER TO INTERIOR ELECATIONS.
- 38. REMOVE/TOOTH CMU BLOCK/SOAPS AS REQ'D TO INSTALL NEW ELECTRICAL BOXES, CONDUIT, DEVICES, ETC. WITHIN EXISTING CMU WALL. INSTALL NEW CMU BLOCK/SOAPS AS REQ'D TO REPAIR WALL AND PROVIDE A UNIFORM FINISHED APPEARANCE. REFER

REPAIR SCOPE NOTES ARE INTENDED TO ILLUSTRATE GENERAL INTENT OF REQUIREMENTS. CONTRACTOR TO FIELD VERIFY CONDITIONS \$ COORDINATE WITH OWNER AS APPLICABLE TO DETERMINE ROUTING, CONFLICTS, ETC. SCOPE NOTES ARE APPLICABLE TO OTHER SIMILAR CONDITIONS WHICH MAY NOT BE SPECIFICALLY IDENTIFIED ON DRAWINGS, BUT REQUIRED FOR EXECUTION OF PROJECT. REFER TO PME DRAWINGS.

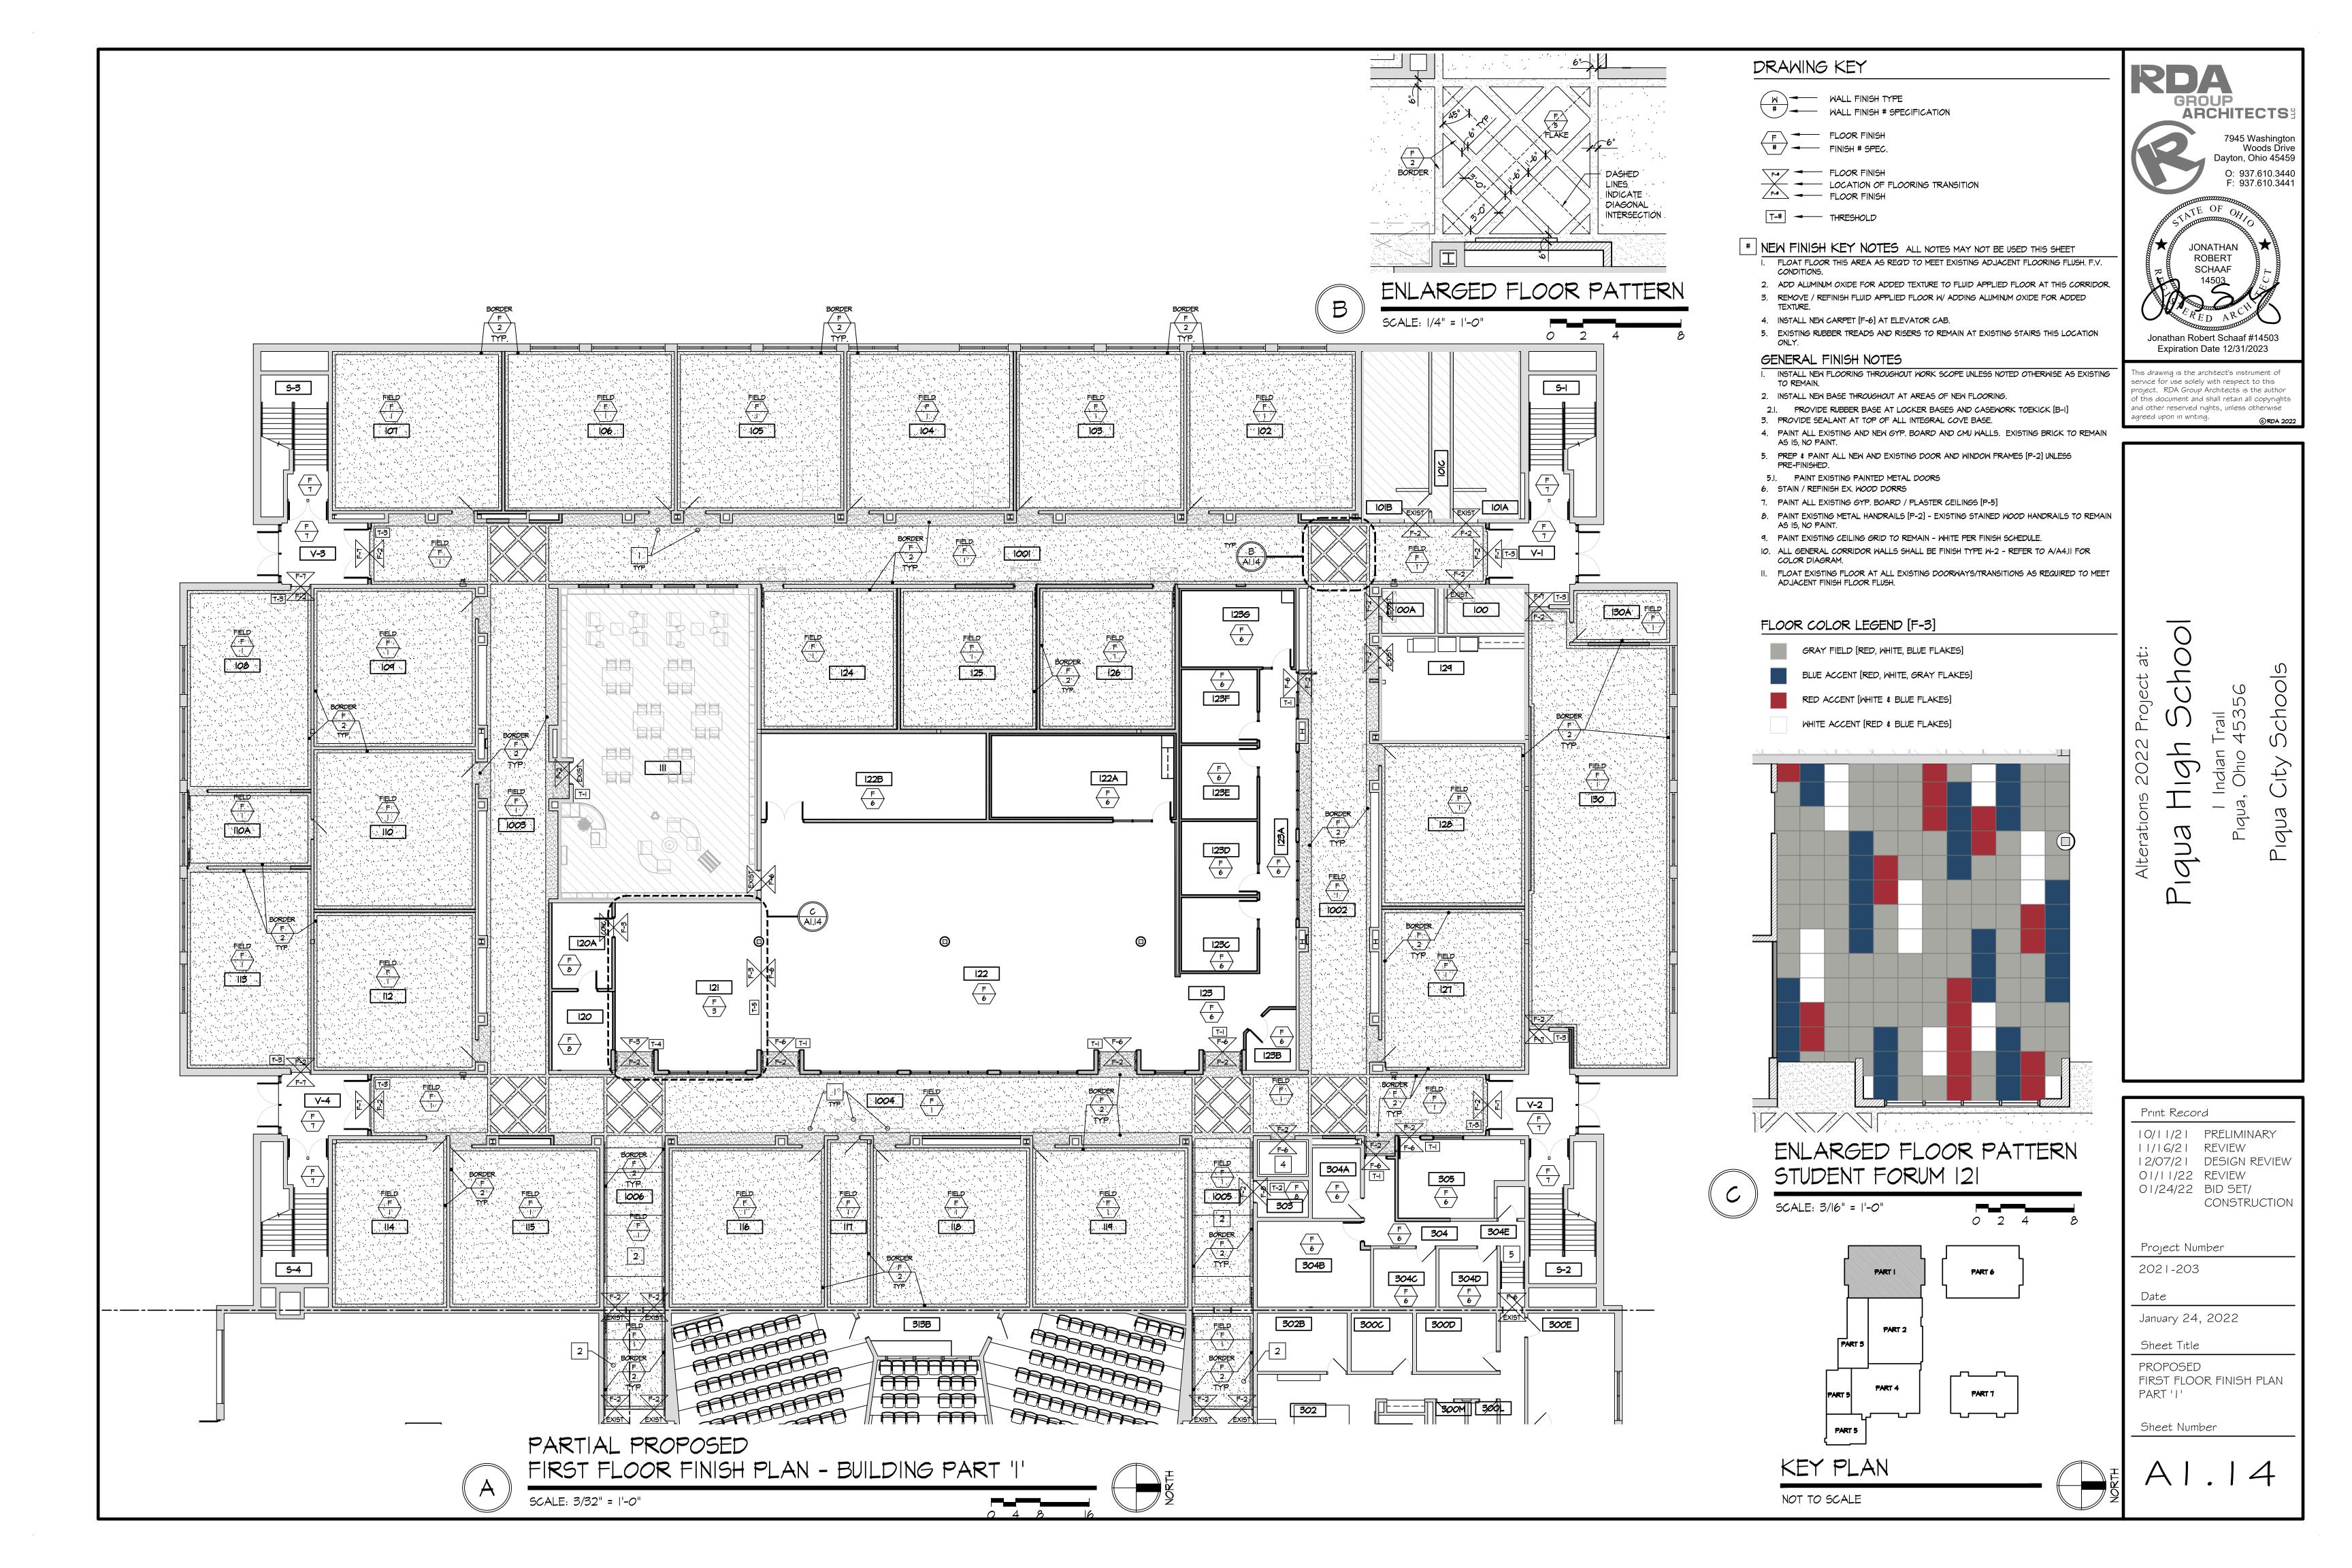REPAIR EXISTING CMU/WALL FINISHES AS REQUIRED BY THE REMOVAL OF THE EXISTING MARKERBOARDS/CHALKBOARD/TACKBOARDS

CONTRACTOR SHALL COORDINATE & ENSURE EXISTING BRANCH CIRCUITRY IS STILL OPERATIONAL AFTER SELECTIVE DEMOLITION. INTENT IS TO RE-ENERGIZE/RE-CONNECT ALL BRANCH CIRCUITRY WHICH IS DOWNSTREAM FROM ANY DEMOLITION WORK. FIELD COORDINATE CONDITIONS.



KEY PLAN



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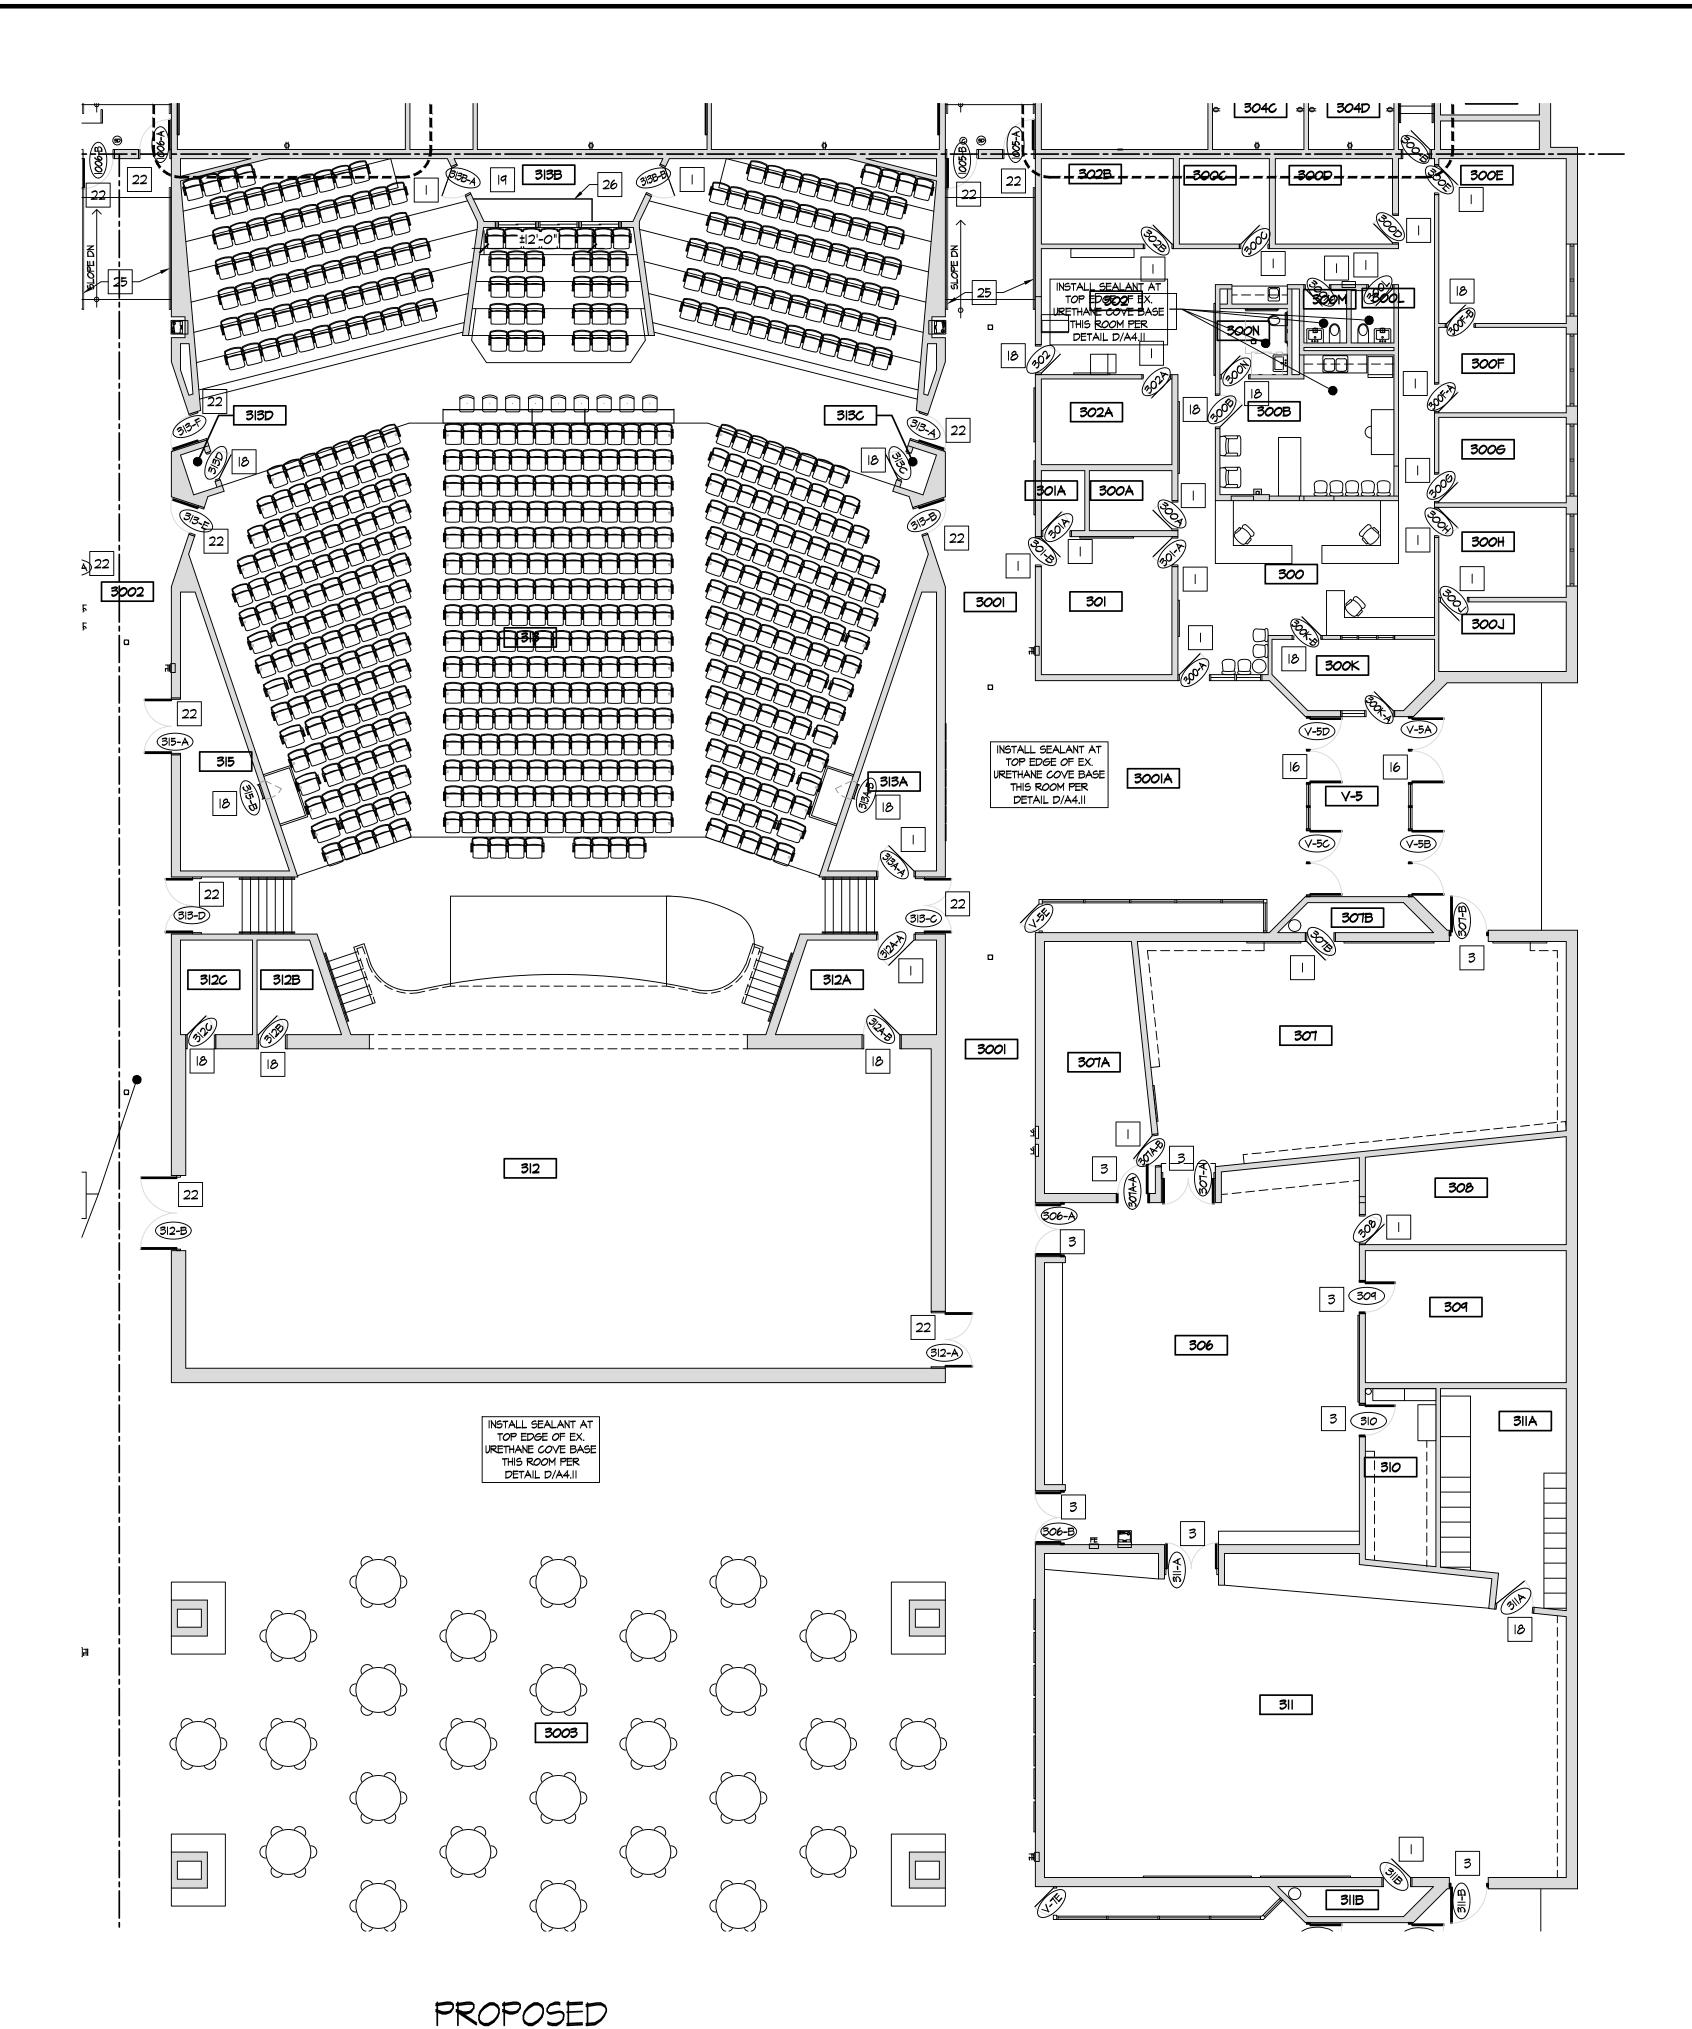
Project Number 2021-203

Date January 24, 2022

Sheet Title FIRST FLOOR REPAIR PLAN


PART 'I'

Sheet Number



FIRST FLOOR PLAN - BUILDING PART '2'

SCALE: 3/32" = 1'-0"

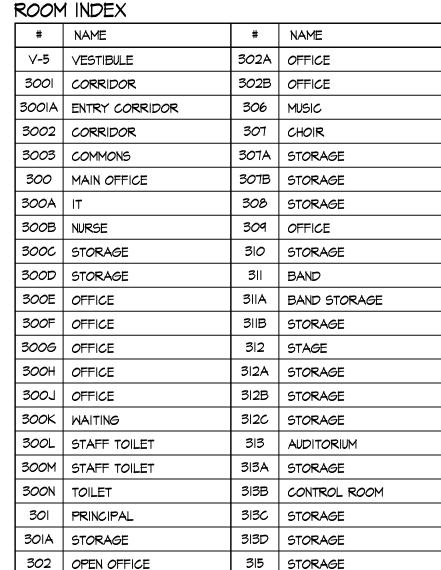

NEW CONSTRUCTION KEY NOTES

- EXISTING SOLID CORE WOOD DOOR AND HOLLOW METAL FRAME TO REMAIN. REPAIR & RE-FINISH EX. WOOD DOOR SLAB AND INSTALL NEW HARDWARE AS SPECIFIED. REFER TO DOOR SCHEDULE AND SPECIFICATIONS.
- 2. INSTALL NEW DOOR AND FRAME IN NEW OPENING. REFER TO DOOR SCHEDULE.
- 3. INSTALL NEW DOOR AND FRAME IN EXISTING OPENING. REFER TO DOOR
- 5. INSTALL NEW TACKBOARD. SEE SCHEDULE.
- 6. INSTALL NEW MAGNETIC MARKER BOARD. SEE SCHEDULE.
- 8. NO WORK THIS AREA.
- IO. INSTALL NEW LOW DRINKING FOUNTAIN WITH BOTTLE FILLER. REFER TO PLUMBING
- DRAWINGS.
- 13. NEW CASEWORK SEE INTERIOR ELEVATIONS
- 14. FURNITURE & EQUIPMENT BY OWNER.
- REFER TO INTERIOR ELEVATIONS.
- 16. INSTALL NEW STOREFRONT SYSTEM AND DOOR. REFER TO WINDOW & DOOR SCHEDULES.
- 17. WALL MOUNTED TV/DISPLAY BY OWNER INSTALLED BY CONTRACTOR, PROVIDE POWER/DATA - REFER TO ELECTRICAL DRAWINGS.
- 18. EXISTING DOOR AND HOLLOW METAL FRAME TO REMAIN. METAL DOORS: REPAIR, NEW HARDWARE AS SPECIFIED. REFER TO DOOR SCHEDULE AND SPECIFICATIONS.
- 20. INSTALL WALL COVERING [WC-I] ON EX. GYP. BD. WALL TO 36" A.F.F.
- FRAME. REFER TO DOOR SCHEDULE AND SPECIFICATIONS.
- VESTIBULE DOORS.
- REFER TO DETAIL N/A2.71.
- 26. INSTALL NEW SOLID SURFACE COUNTERTOP AND STEEL SUPPORTS IN CONTROL ROOM. REFER TO F/A2.91.

- 4. INSTALL NEW WINDOW IN NEW OPENING. REFER TO WINDOW SCHEDULE.
- 7. INFILL EXISTING OPENING W/ CMU, TOOTH INTO EXISTING, MATCH EX. EACH SIDE.
- 9. INSTALL NEW HIGH-LOW DRINKING FOUNTAIN WITH BOTTLE FILLER. REFER TO PLUMBING DRAWINGS.
- II. ROOM SIGNAGE PROVIDED AND INSTALLED BY OWNER.
- 12. INSTALL NEW PARTITION WALL, REFER TO WALL TYPES.
- 15. NEW LOCKERS & BLOCKING BY OWNER, SET ON NEW/EXISTING LOCKER BASES.
- PREP, PAINT, & INSTALL NEW HARDWARE AS SPECIFIED; WOOD DOORS: INSTALL
- 19. PREP AND PAINT EXISTING WALLS IN CONTROL ROOM [P-6]. REMOVE EXISTING FLOORING AND INSTALL NEW CARPET [F-6].
- 21. INSTALL WALL COVERING [WC-1] FULL HEIGHT TO UNDERSIDE OF CEILING AT EMERGENCY SHOWER. INSTALL STAINLESS STEEL WALL CAP FULL HEIGHT.
- 22. INSTALL NEW DOOR & HARDWARE AS SPECIFIED, IN EXISTING HOLLOW METAL
- 23. EXISTING METAL GATE TO REMAIN. REFER TO INTERIOR ELEVATIONS.
- 24. NEW METAL STUD WALL / DOOR / FRAME / HARDWARE AT LOCATION OF ORIGINAL
- 25. INSTALL NEW ANODIZED ALUMINUM WALL MOUNTED HANDRAILS EA. SIDE OF RAMP.

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January 24, 2022

FIRST FLOOR PLAN

Sheet Number

2021-203

Sheet Title

PROPOSED

PART '2'

Date

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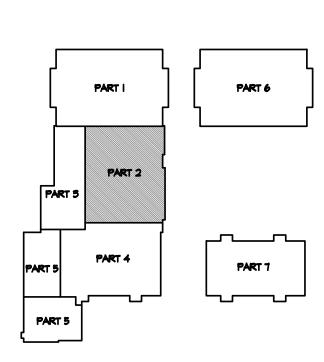
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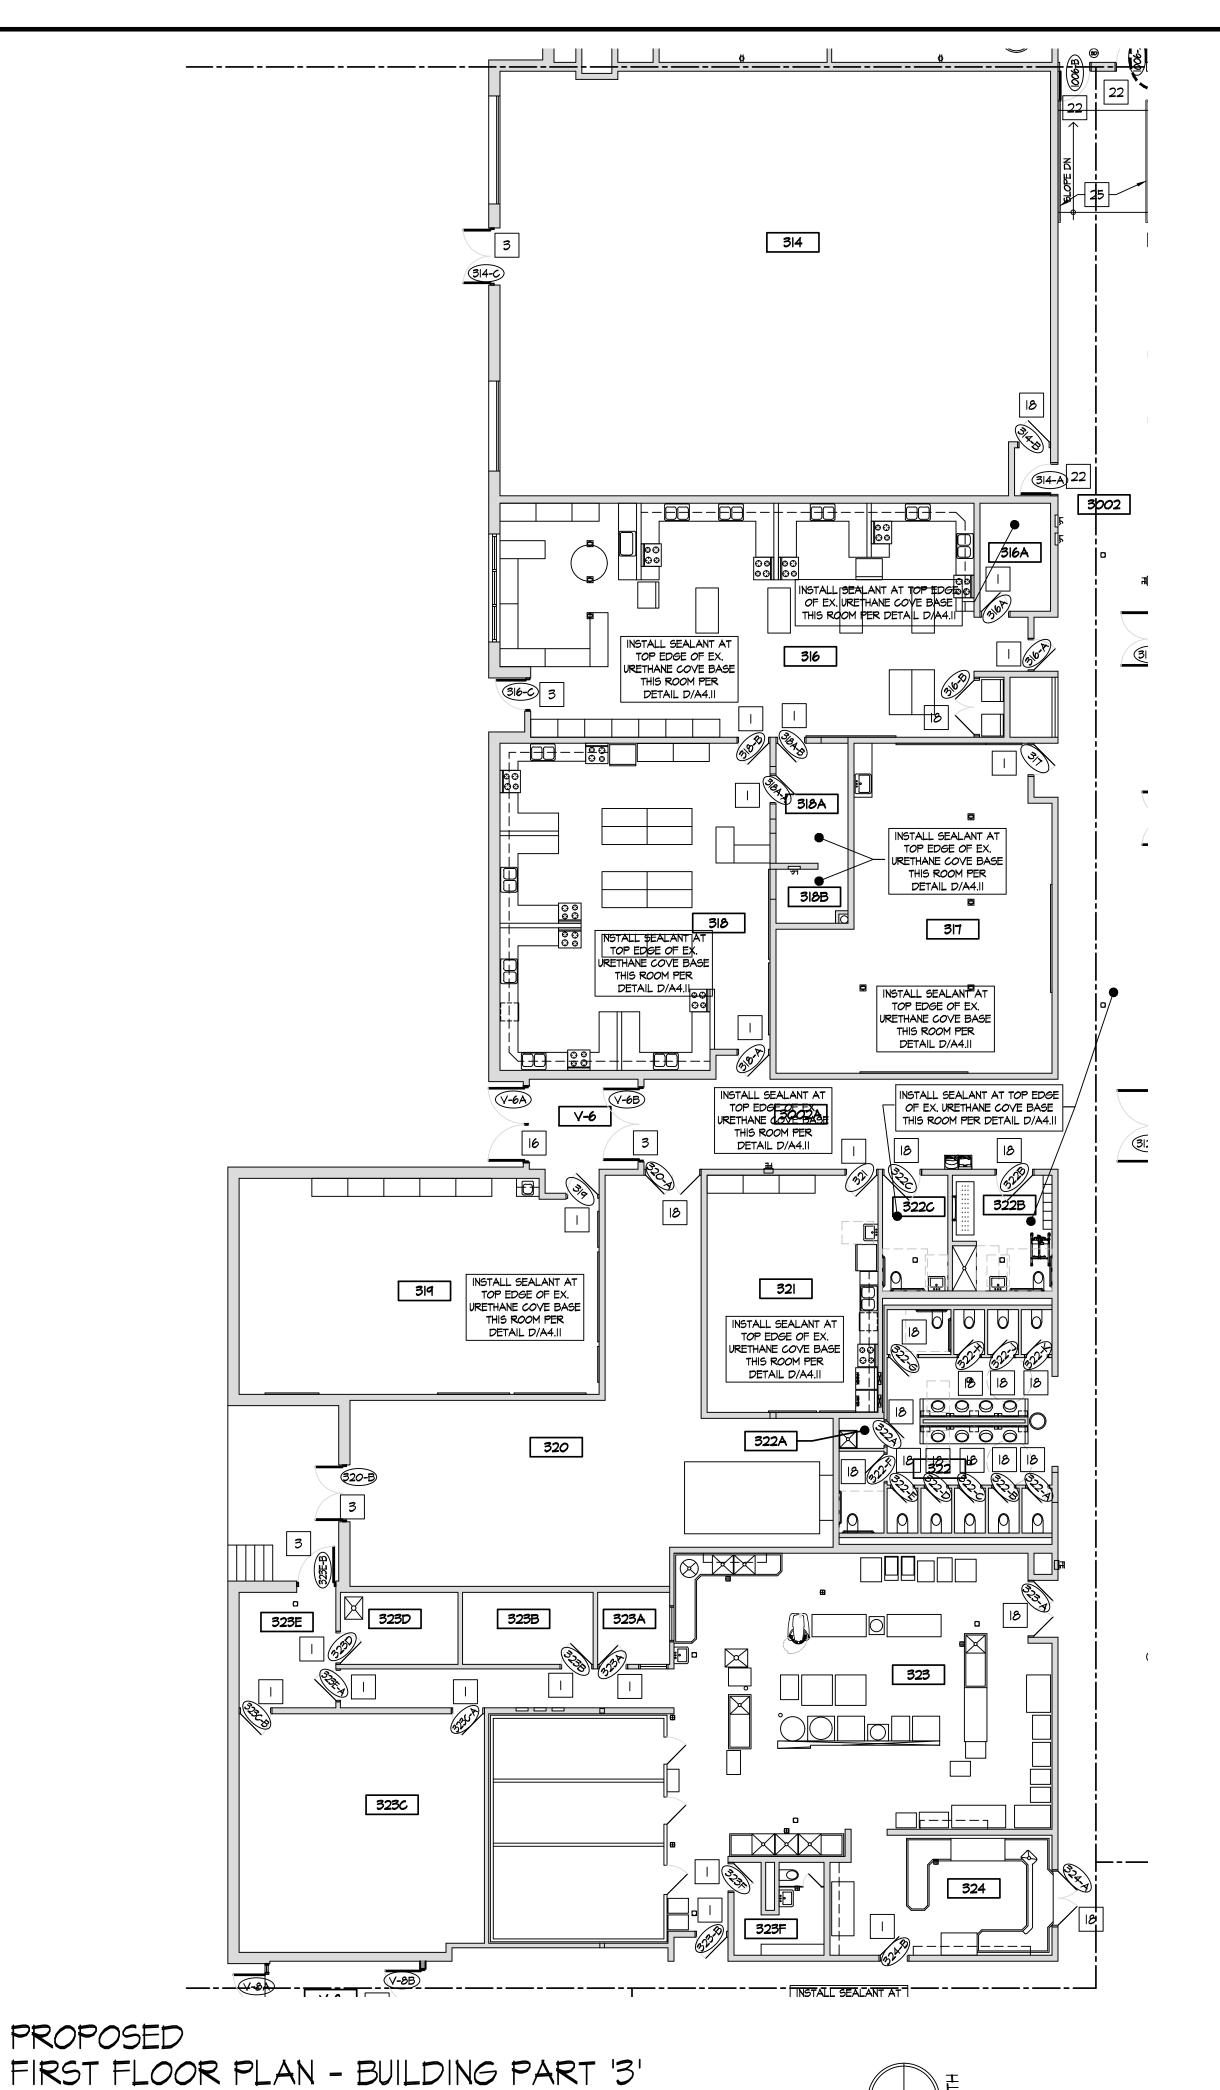
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KEY PLAN NOT TO SCALE



SCALE: 3/32" = 1'-0"

ROOM INDEX # NAME # NAME V-6 VESTIBULE 322 COMMONS TOILET 3002 CORRIDOR 322A JANITOR 300IA ENTRY CORRIDOR 322B | ADA TOILET 314 BOILER ROOM 322C ADA TOILET 316 HOME ECONOMICS 323 KITCHEN | 316A | STORAGE 323A OFFICE 317 | CLASSROOM 323B STORAGE 318 HOME ECONOMICS 323C STORAGE 318A STORAGE 323D JANITOR 318B STORAGE 323E KITCHEN RECEIVING

323F | TOILET

324 DISHWASHING

319 CLASSROOM

321 CLASSROOM

320 RECEIVING

| # | NEW CONSTRUCTION KEY NOTES

EXISTING SOLID CORE WOOD DOOR AND HOLLOW METAL FRAME TO REMAIN. REPAIR & RE-FINISH EX. WOOD DOOR SLAB AND INSTALL NEW HARDWARE AS SPECIFIED. REFER TO DOOR SCHEDULE AND SPECIFICATIONS.

2. INSTALL NEW DOOR AND FRAME IN NEW OPENING. REFER TO DOOR SCHEDULE.

3. INSTALL NEW DOOR AND FRAME IN EXISTING OPENING. REFER TO DOOR

5. INSTALL NEW TACKBOARD. SEE SCHEDULE.

6. INSTALL NEW MAGNETIC MARKER BOARD. SEE SCHEDULE.

7. INFILL EXISTING OPENING W/ CMU, TOOTH INTO EXISTING, MATCH EX. EACH SIDE.

9. INSTALL NEW HIGH-LOW DRINKING FOUNTAIN WITH BOTTLE FILLER. REFER TO

IO. INSTALL NEW LOW DRINKING FOUNTAIN WITH BOTTLE FILLER. REFER TO PLUMBING

II. ROOM SIGNAGE PROVIDED AND INSTALLED BY OWNER.

12. INSTALL NEW PARTITION WALL, REFER TO WALL TYPES.

13. NEW CASEWORK - SEE INTERIOR ELEVATIONS

15. NEW LOCKERS & BLOCKING BY OWNER, SET ON NEW/EXISTING LOCKER BASES.

17. WALL MOUNTED TY/DISPLAY BY OWNER - INSTALLED BY CONTRACTOR, PROVIDE POWER/DATA - REFER TO ELECTRICAL DRAWINGS.

18. EXISTING DOOR AND HOLLOW METAL FRAME TO REMAIN. METAL DOORS: REPAIR, PREP, PAINT, & INSTALL NEW HARDWARE AS SPECIFIED; WOOD DOORS: INSTALL NEW HARDWARE AS SPECIFIED. REFER TO DOOR SCHEDULE AND SPECIFICATIONS.

19. PREP AND PAINT EXISTING WALLS IN CONTROL ROOM [P-6]. REMOVE EXISTING FLOORING AND INSTALL NEW CARPET [F-6].

21. INSTALL WALL COVERING [WC-I] FULL HEIGHT TO UNDERSIDE OF CEILING AT EMERGENCY SHOWER. INSTALL STAINLESS STEEL WALL CAP FULL HEIGHT.

FRAME. REFER TO DOOR SCHEDULE AND SPECIFICATIONS.

23. EXISTING METAL GATE TO REMAIN. REFER TO INTERIOR ELEVATIONS.

VESTIBULE DOORS.

25. INSTALL NEW ANODIZED ALUMINUM WALL MOUNTED HANDRAILS EA. SIDE OF RAMP.

ROOM. REFER TO F/A2.91.

4. INSTALL NEW WINDOW IN NEW OPENING. REFER TO WINDOW SCHEDULE.

8. NO WORK THIS AREA.

PLUMBING DRAWINGS.

DRAWINGS.

14. FURNITURE & EQUIPMENT BY OWNER.

REFER TO INTERIOR ELEVATIONS.

16. INSTALL NEW STOREFRONT SYSTEM AND DOOR. REFER TO WINDOW & DOOR SCHEDULES.

20. INSTALL WALL COVERING [WC-I] ON EX. GYP. BD. WALL TO 36" A.F.F.

22. INSTALL NEW DOOR & HARDWARE AS SPECIFIED, IN EXISTING HOLLOW METAL

24. NEW METAL STUD WALL / DOOR / FRAME / HARDWARE AT LOCATION OF ORIGINAL

REFER TO DETAIL N/A2.71.

26. INSTALL NEW SOLID SURFACE COUNTERTOP AND STEEL SUPPORTS IN CONTROL

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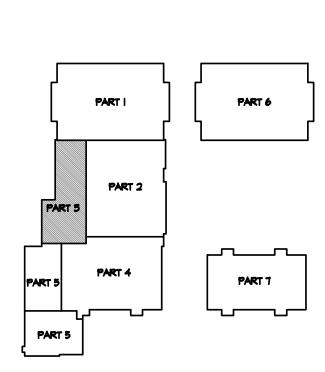
12/07/21 DESIGN REVIEW

11/16/21 REVIEW

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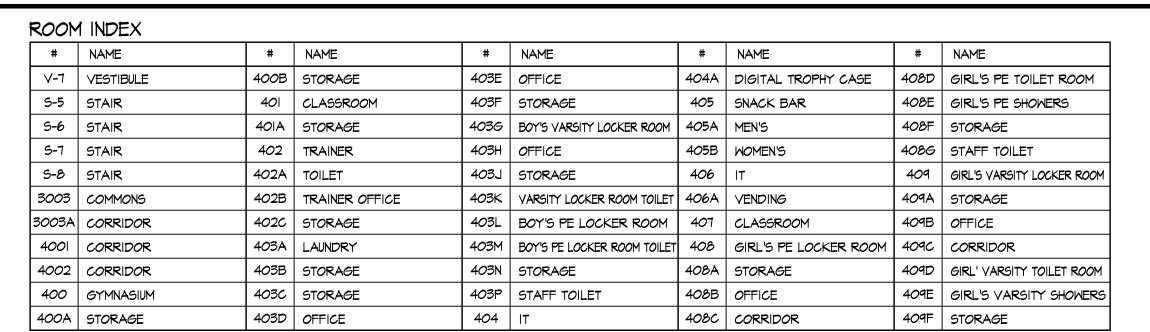
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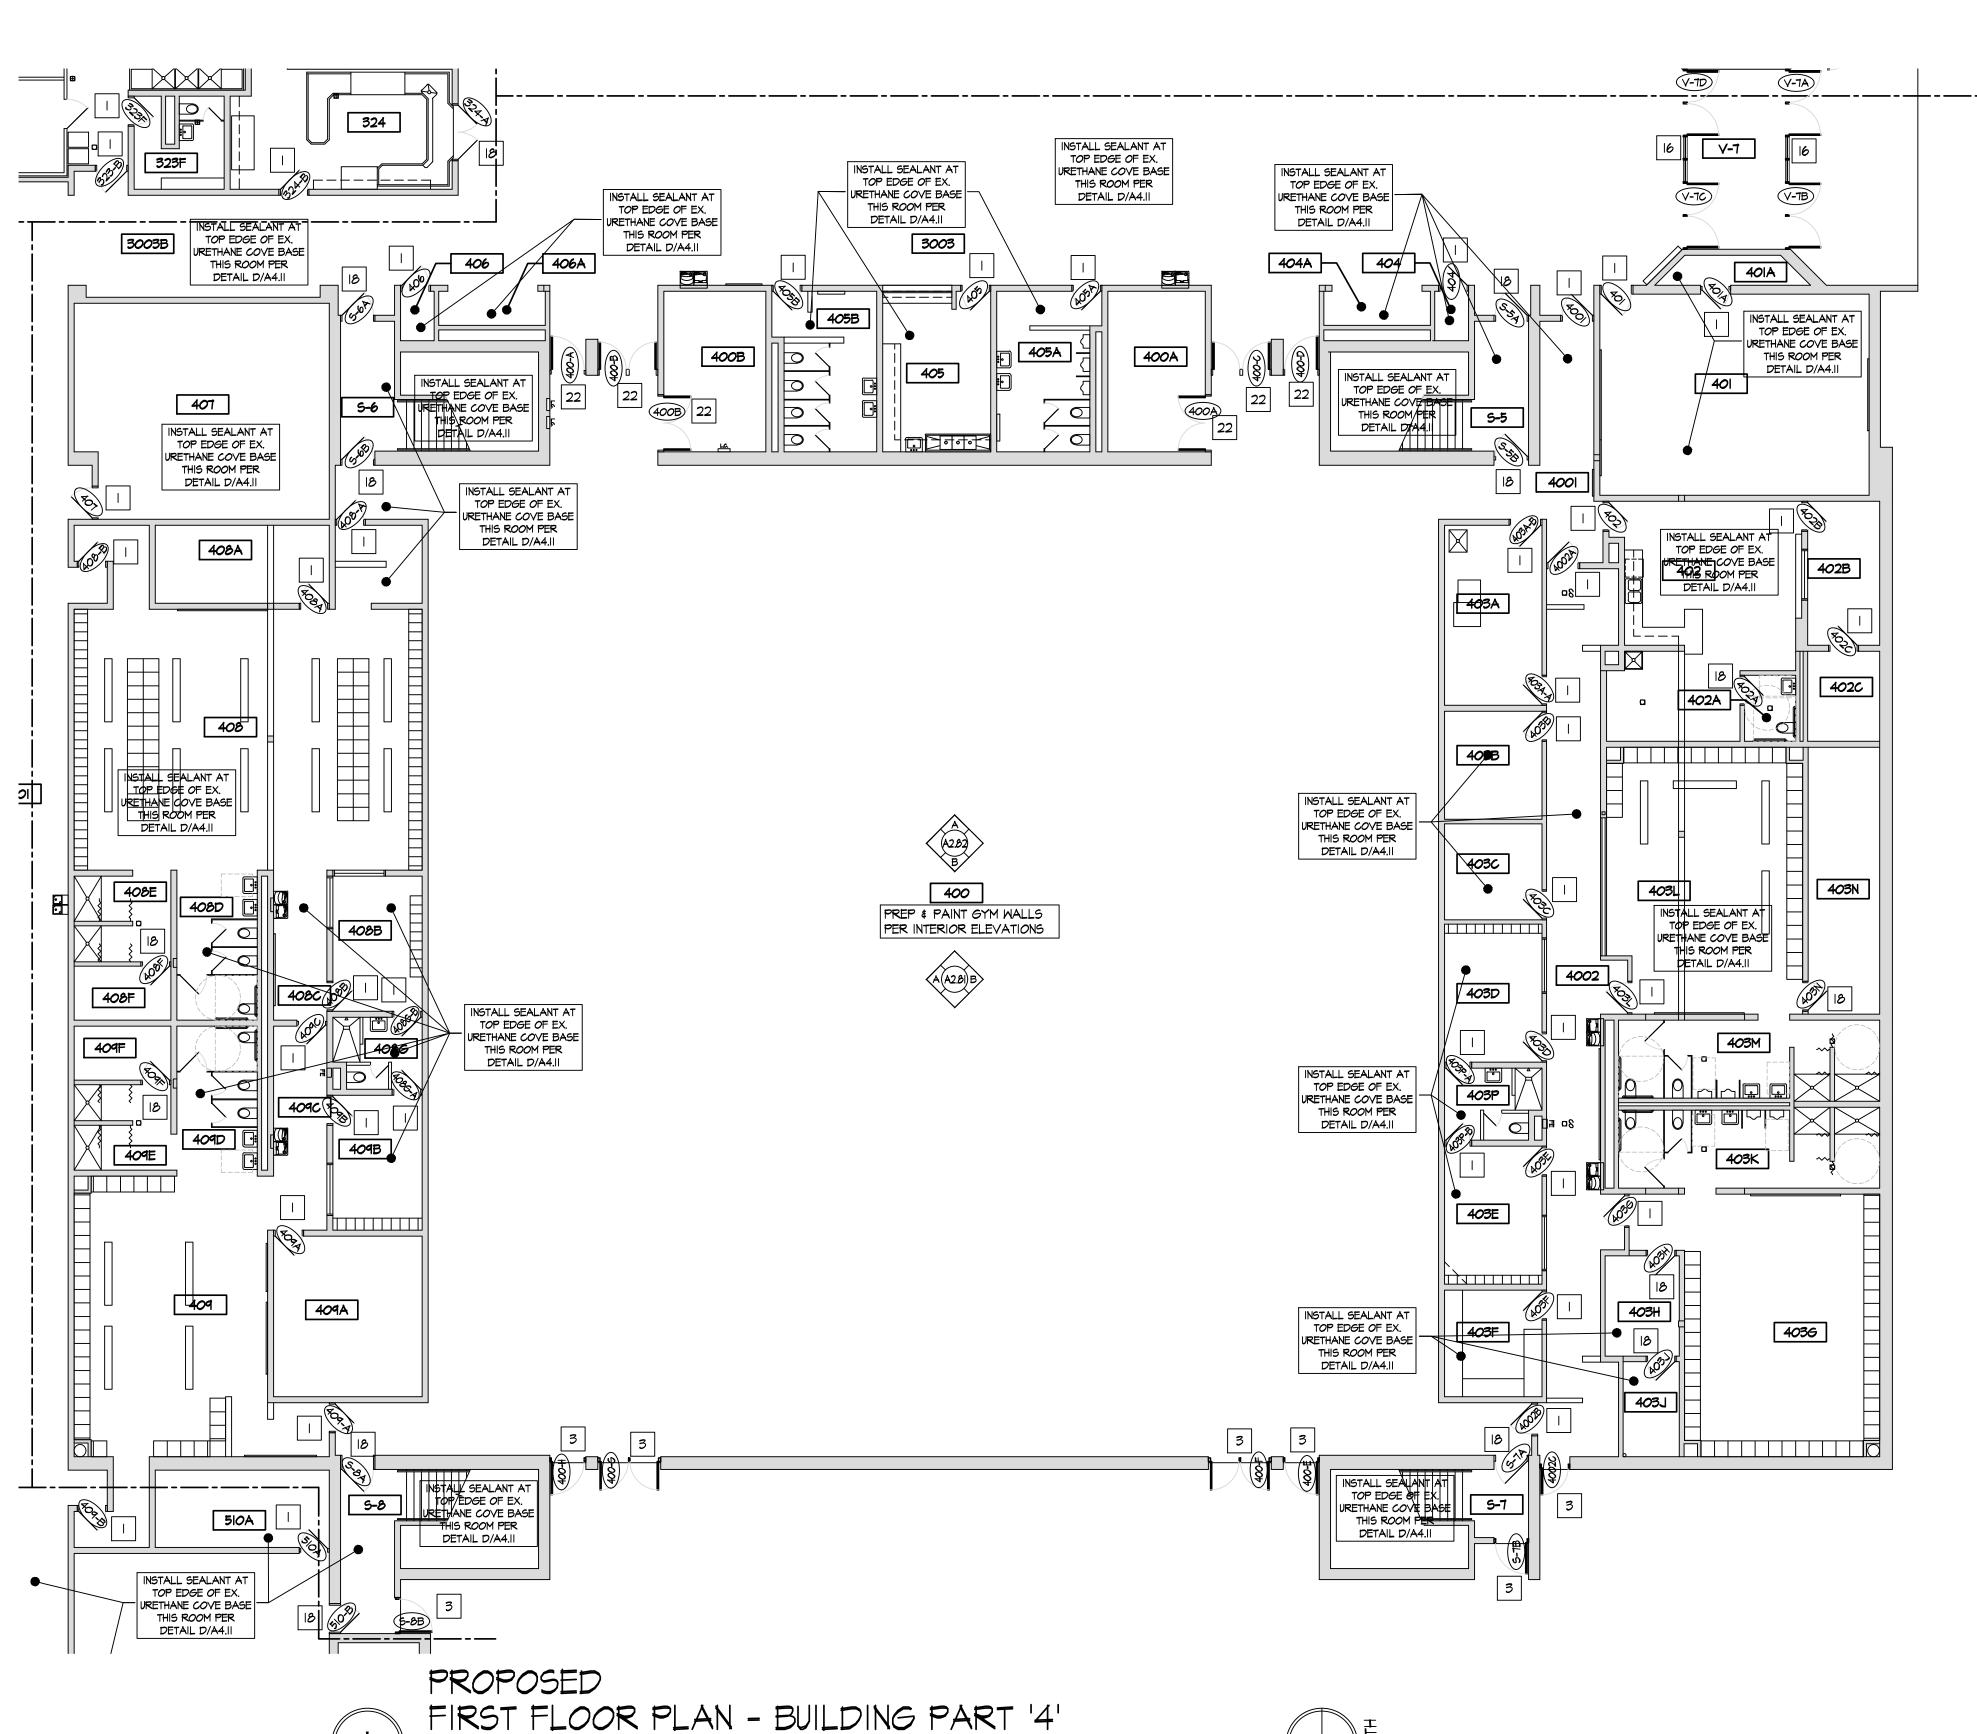
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KEY PLAN NOT TO SCALE

01/11/22 REVIEW 01/24/22 BID SET/ CONSTRUCTION Project Number 2021-203 Date January 24, 2022 Sheet Title PROPOSED FIRST FLOOR PLAN PART '3' Sheet Number





SCALE: 3/32" = 1'-0"

- EXISTING SOLID CORE WOOD DOOR AND HOLLOW METAL FRAME TO REMAIN. REPAIR & RE-FINISH EX. WOOD DOOR SLAB AND INSTALL NEW HARDWARE AS SPECIFIED. REFER TO DOOR SCHEDULE AND SPECIFICATIONS.
- 2. INSTALL NEW DOOR AND FRAME IN NEW OPENING. REFER TO DOOR SCHEDULE.
- 3. INSTALL NEW DOOR AND FRAME IN EXISTING OPENING. REFER TO DOOR
- 4. INSTALL NEW WINDOW IN NEW OPENING. REFER TO WINDOW SCHEDULE.
- 5. INSTALL NEW TACKBOARD. SEE SCHEDULE.
- 6. INSTALL NEW MAGNETIC MARKER BOARD. SEE SCHEDULE.
- 7. INFILL EXISTING OPENING W/ CMU, TOOTH INTO EXISTING, MATCH EX. EACH SIDE. 8. NO WORK THIS AREA.
- 9. INSTALL NEW HIGH-LOW DRINKING FOUNTAIN WITH BOTTLE FILLER. REFER TO PLUMBING DRAWINGS.
- IO. INSTALL NEW LOW DRINKING FOUNTAIN WITH BOTTLE FILLER. REFER TO PLUMBING DRAWINGS.
- II. ROOM SIGNAGE PROVIDED AND INSTALLED BY OWNER.
- 12. INSTALL NEW PARTITION WALL, REFER TO WALL TYPES.
- 13. NEW CASEWORK SEE INTERIOR ELEVATIONS
- 14. FURNITURE & EQUIPMENT BY OWNER.
- 15. NEW LOCKERS & BLOCKING BY OWNER, SET ON NEW/EXISTING LOCKER BASES. REFER TO INTERIOR ELEVATIONS.
- 16. INSTALL NEW STOREFRONT SYSTEM AND DOOR. REFER TO WINDOW & DOOR SCHEDULES.
- 17. WALL MOUNTED TV/DISPLAY BY OWNER INSTALLED BY CONTRACTOR, PROVIDE POWER/DATA - REFER TO ELECTRICAL DRAWINGS.
- 18. EXISTING DOOR AND HOLLOW METAL FRAME TO REMAIN. METAL DOORS: REPAIR, PREP, PAINT, & INSTALL NEW HARDWARE AS SPECIFIED; WOOD DOORS: INSTALL NEW HARDWARE AS SPECIFIED. REFER TO DOOR SCHEDULE AND SPECIFICATIONS.
- 19. PREP AND PAINT EXISTING WALLS IN CONTROL ROOM [P-6]. REMOVE EXISTING FLOORING AND INSTALL NEW CARPET [F-6].
- 20. INSTALL WALL COVERING [WC-I] ON EX. GYP. BD. WALL TO 36" A.F.F.
- 21. INSTALL WALL COVERING [WC-I] FULL HEIGHT TO UNDERSIDE OF CEILING AT EMERGENCY SHOWER. INSTALL STAINLESS STEEL WALL CAP FULL HEIGHT.
- 22. INSTALL NEW DOOR \$ HARDWARE AS SPECIFIED, IN EXISTING HOLLOW METAL
- FRAME. REFER TO DOOR SCHEDULE AND SPECIFICATIONS.
- 23. EXISTING METAL GATE TO REMAIN. REFER TO INTERIOR ELEVATIONS. 24. NEW METAL STUD WALL / DOOR / FRAME / HARDWARE AT LOCATION OF ORIGINAL
- VESTIBULE DOORS. 25. INSTALL NEW ANODIZED ALUMINUM WALL MOUNTED HANDRAILS EA. SIDE OF RAMP.
- REFER TO DETAIL N/A2.71.
- 26. INSTALL NEW SOLID SURFACE COUNTERTOP AND STEEL SUPPORTS IN CONTROL ROOM. REFER TO F/A2.91.

NEW CONSTRUCTION KEY NOTES



ARCHITECTS

GROUP



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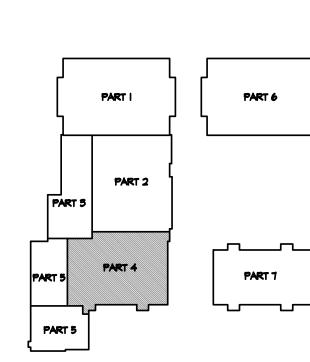
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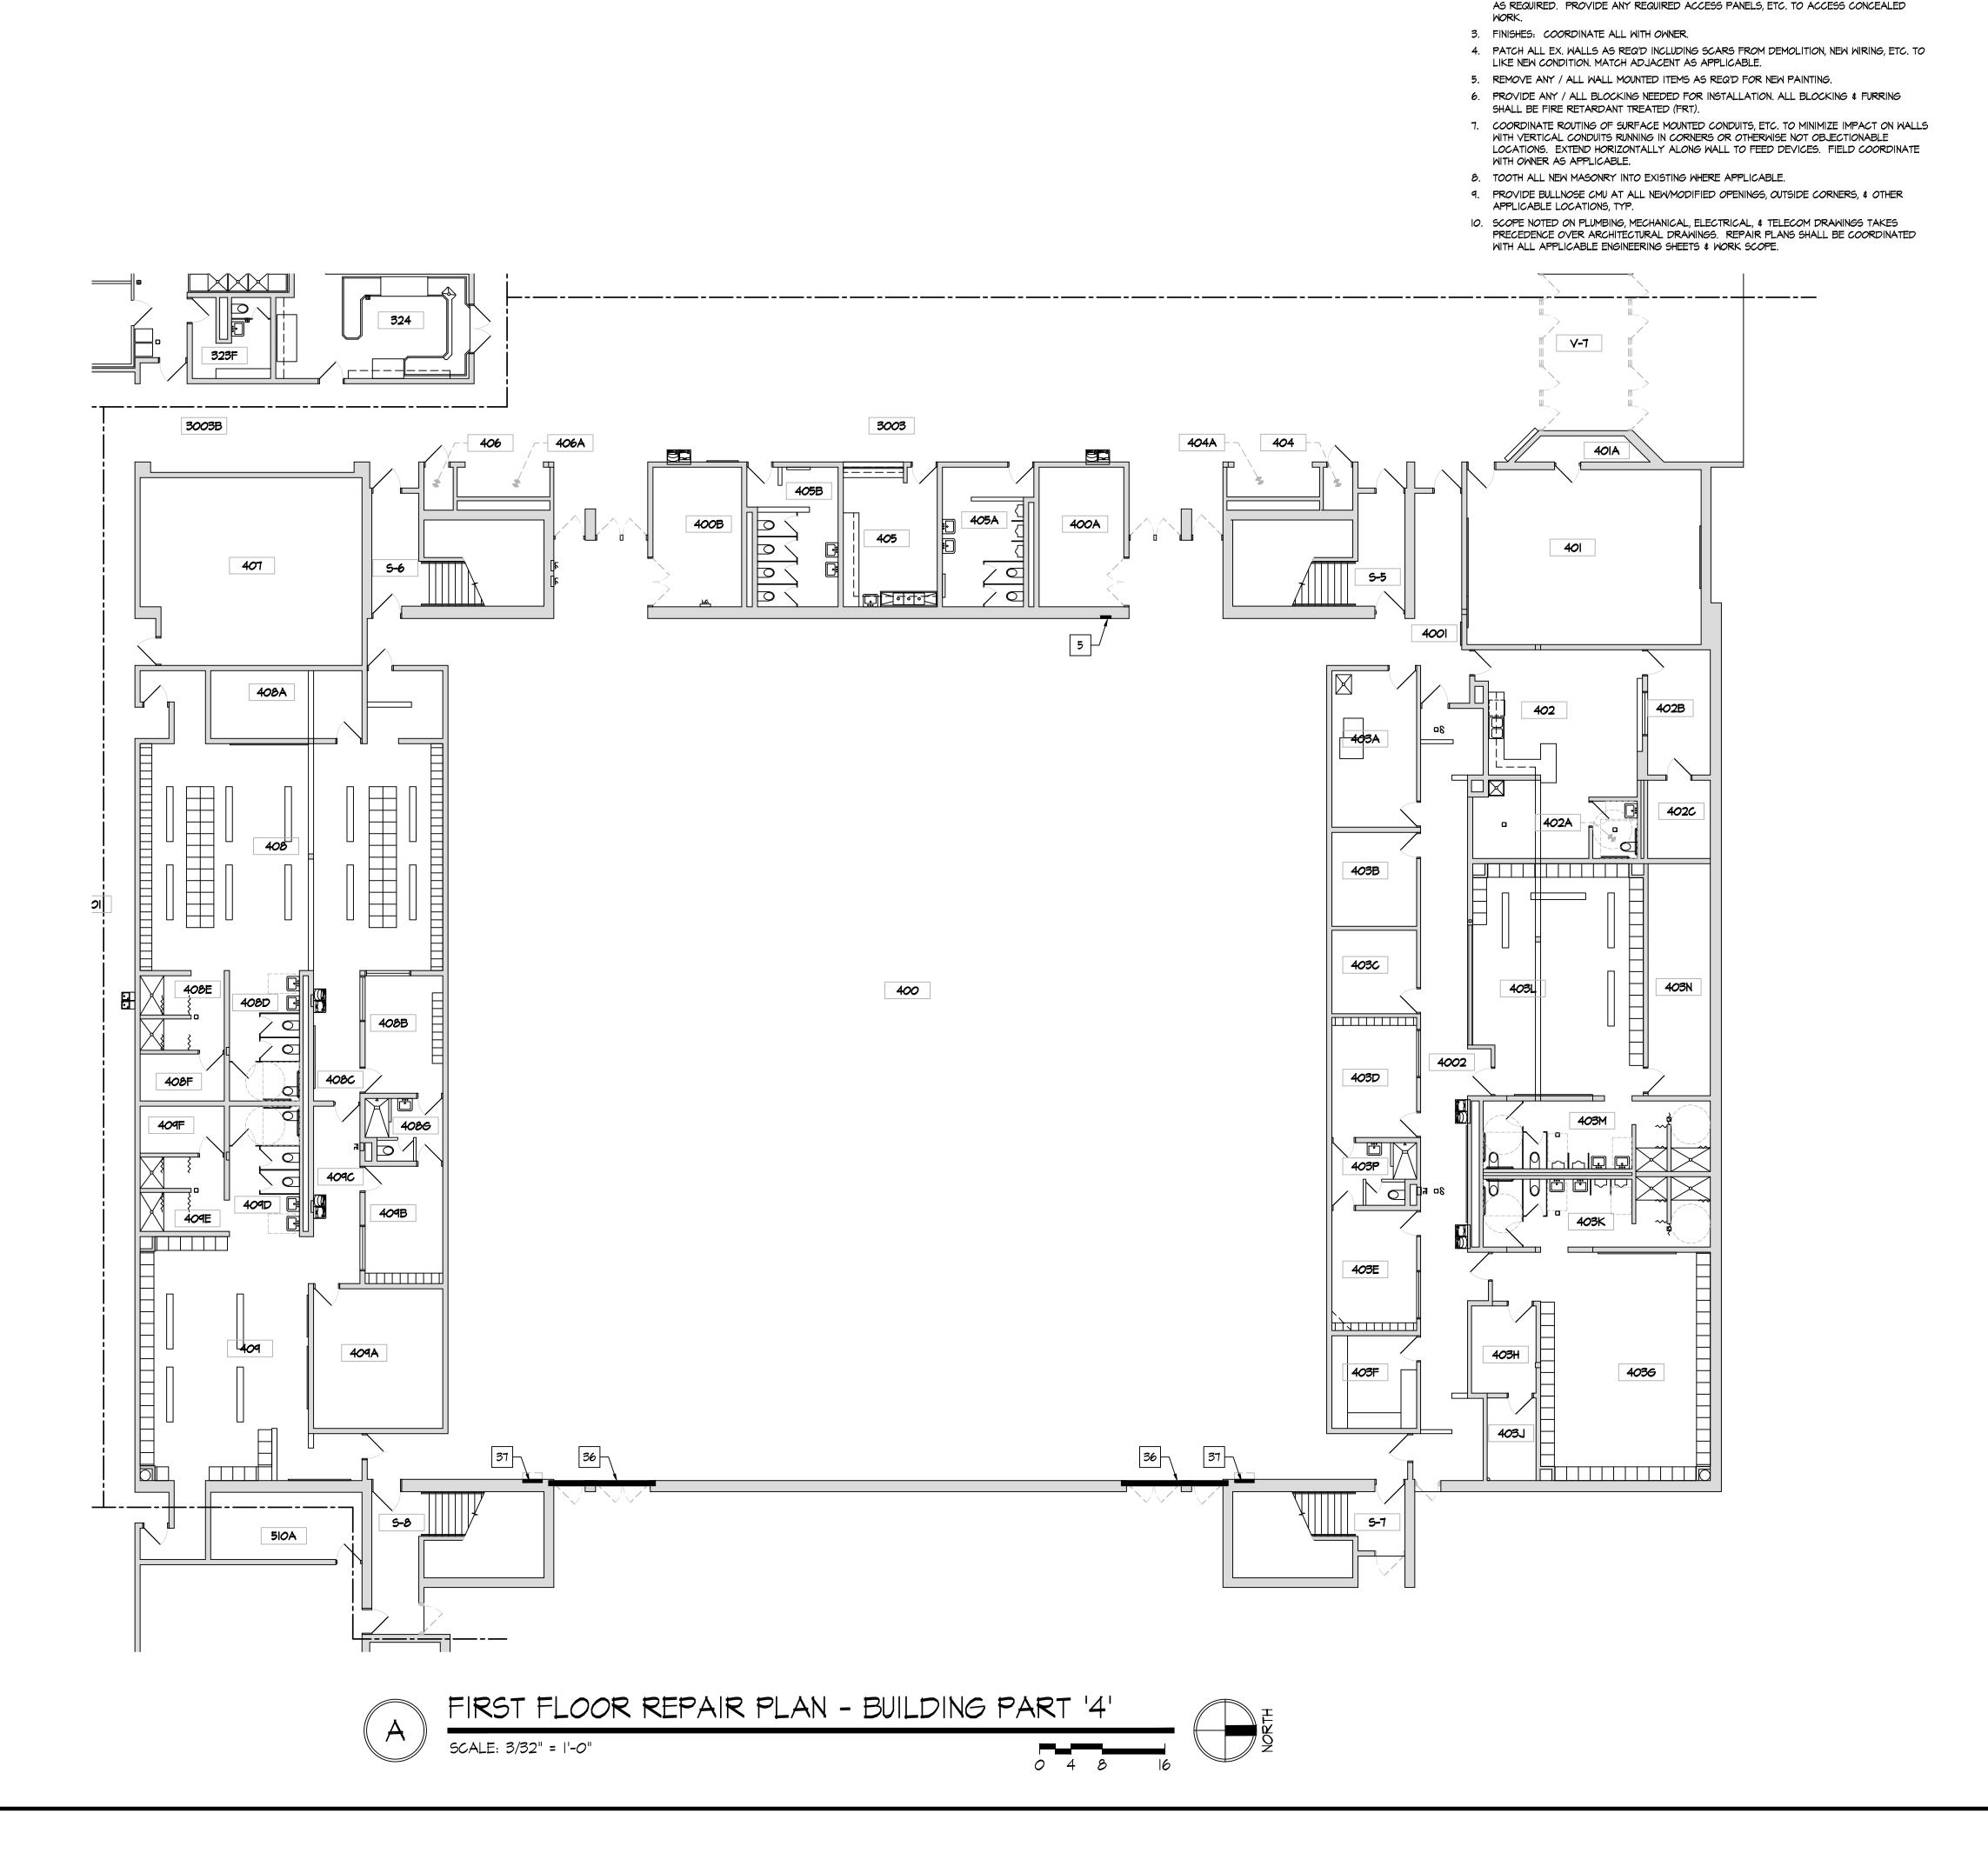
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KEY PLAN

NOT TO SCALE

01/24/22 BID SET/ CONSTRUCTION Project Number 2021-203 Date January 24, 2022 Sheet Title PROPOSED FIRST FLOOR PLAN PART '4' Sheet Number



REPAIR KEY NOTES

REPAIR GENERAL NOTES

CONTRACTOR TO FIELD VERIFY ALL DIMENSIONS & CONDITIONS.

2. COORDINATE WORK WITH APPLICABLE PLUMBING, MECHANICAL, AND ELECTRICAL DRAWINGS

- I. REMOVE EXISTING BLANK COVER PLATE, EXISTING BOX / DEVICE, ETC. TERMINATE EX. WIRING AS APPLICABLE. INFILL OPENING IN WALL WITH CMU TO MATCH ADJACENT. [EXAMPLES: BLANK PLATES, ABANDONED SWITCHES, ETC.]
- 2. REMOVE EXISTING SURFACE MOUNT PANDUIT / CONDUIT FROM WALL. RE-RUN EXISTING FEED WITHIN CMU WALL OR ABOVE CEILING. INSTALL NEW BOX, DEVICE, & COVER AS APPLICABLE. REFER TO ELECTRICAL DRAWINGS.
- 3. REMOVE EXISTING SURFACE MOUNTED DATA CABLING PANDUIT / CONDUIT FROM WALL. RE-RUN EXISTING DATA CABLING WITHIN CMU WALL. IF ROUTING WITHIN CMU WALL IS NOT POSSIBLE, RE-RUN EXISTING DATA CABLING THRU NEW PANDUIT / CONDUIT. INSTALL NEW ELECTRICAL DEVICE / LOW VOLTAGE BOX AND COVER PLATE AS APPLICABLE. FIELD COORDINATE ROUTING WITH OWNER.
- 4. REMOVE EXISTING SURFACE MOUNTED ELECTRICAL PANDUIT / CONDUIT FROM WALL.
 RE-RUN EXISTING ELECTRICAL FEED WITHIN CMU WALL. INSTALL NEW ELECTRICAL
 DEVICE / LOW VOLTAGE BOX AND COVER PLATE AS APPLICABLE. REFER TO
 ELECTRICAL DRAWINGS. FIELD COORDINATE ROUTING W/ OWNER
- ELECTRICAL DRAWINGS. FIELD COORDINATE ROUTING W/ OWNER.

 5. REMOVE EXISTING WALL CLOCK AND ASSOCIATED WIRING. INFILL OPENING IN WALL
- WITH CMU TO MATCH ADJACENT. REFER TO ELECTRICAL DRAWINGS.

 6. REMOVE EXISTING SURFACE MOUNT PLUG MOLD. REFER TO ELECTRICAL DRAWINGS.
- 7. REMOVE EXISTING SURFACE MOUNT ELECTRICAL DEVICE \$ CONDUIT FROM WALL REFER TO ELECTRICAL DRAWINGS.
- 8. REMOVE ABANDONED FIRE ALARM DEVICE. INFILL OPENING IN WALL WITH CMU TO MATCH ADJACENT.
- 9. RELOCATE EXISTING THERMOSTAT & CONTROL WIRING. REFER TO MECHANICAL DRAWINGS. F.Y. LOCATION WITH OWNER.
- IO. EXISTING THERMOSTAT TO REMAIN. REMOVE EXISTING VANDAL COVER, CONDUIT, BOX & RE-RUN IN NEW WHITE CONDUIT. REFER TO MECHANICAL DRAWINGS.
- II. REMOVE SURFACE MOUNTED LOW VOLTAGE / DATA DEVICE, BOX, EXISTING PANDUIT, ETC. PULL DATA UP TO CEILING. REFER TO ELECTRICAL DRAWINGS.
- 12. RELOCATE EXISTING OFFICE CALL DEVICE. INFILL OPENING IN WALL WITH CMU TO MATCH ADJACENT. F.V. NEW LOCATION WITH OWNER. REFER TO ELECTRICAL DRAWINGS
- 13. REPAIR EXISTING CMU WALL AS REQ'D, WHERE EXISTING WALL WAS REMOVED.
- 14. REPAIR EXISTING CONCRETE SLAB AS REQ'D, WHERE EXISTING WALL WAS REMOVED.
 [LIGHTWEIGHT CONCRETE AT SECOND FLOOR]
- 15. REPAIR/REPLACE EXISTING CRACKED/DAMAGED CMU AS REQ'D. PREP & PAINT.

 16. REMOVE EXISTING INSTALL NEW SEALANT AT CONTROL / EXPANSION JOINTS.
- REMOVE EXISTING ALUMINUM COVER IF APPLICABLE.


 17. REPAIR EXISTING CMU WALL AS REQ'D, WHERE EXISTING PLUMBING WAS REMOVED.
- 18. REPAIR CRACK IN EXISTING CMU WALL. REFER TO STRUCTURAL DRAWINGS.
- 19. REPAIR EXISTING CMU WALL AS REQ'D, WHERE EXISTING LOCKERS WERE REMOVED.
- 20. REMOVE EXISTING ELECTRICAL DEVICE, EXISTING BOX, COVER PLATE, ETC.
 RE-ROUTE / TERMINATE EX. WIRING AS APPLICABLE. INFILL OPENING IN WALL WITH
 CMU TO MATCH ADJACENT. REFER TO ELECTRICAL DRAWINGS.
- 21. REMOVE EXISTING WALL MOUNTED OCCUPANCY SENSOR. REFER TO ELECTRICAL DRAWINGS.
- 22. REPAIR EXISTING CMU WALL AS REQ'D, WHERE EXISTING DRINKING FOUNTAIN WAS REMOVED. EXTEND EXISTING PLUMBING AND ELECTRICAL AS REQ'D. INFILL OPENING IN WALL WITH CMU TO MATCH ADJACENT. REFER TO PLUMBING & ELECTRICAL DRAWINGS.
- 23. REPAIR EXISTING CMU WALL AS REQ'D, WHERE EXISTING OPERABLE PARTITION WAS REMOVED. INFILL OPENING IN WALL WITH CMU TO MATCH ADJACENT.
- 24. REPAIR EXISTING CMU WALL AS REQ'D, WHERE EXISTING DOOR AND FRAME WAS REMOVED.
- 25. REPAIR/REPLACE DETERIORATED STEEL LINTEL. REFER TO STRUCTURAL DRAWINGS.
- 26. REMOVE EXISTING ELECTRICAL DEVICE, EXISTING BOX, COVER PLATE, ETC. RE-ROUTE / TERMINATE EX. WIRING AS APPLICABLE.
- 27. RELOCATE EXISTING SWITCH AND DATA CABLING TO ABOVE CEILING. REF. TO ELEC. 28. EXISTING FIRE ALARM DEVICE & CONDUIT TO REMAIN. PAINT CONDUIT TO MATCH
- 29. REMOVE EXISTING POWER / DATA POLE. PULL DATA AND ELECTRICAL UP TO CEILING & TERMINATE AS REQ'D.
- 30. INSTALL NEW 5" CONCRETE SLAB AS REQ'D, WHERE EXISTING SLAB WAS REMOVED FOR UNDER SLAB PLUMBING WORK. FINISH FLUSH WITH EXISTING ADJACENT.
- 31. REMOVE EXISTING TV POWER/COAXIAL WALL OUTLET CABLING. EXISTING BACK BOX,
- AND CONDUIT TO REMAIN, INSTALL BLANK COVER PLATE.

 32. REPAIR CMU FROM REMOVAL OF PLUMBING ROUGH-INS. WALL CAPS/ESCUTCHEONS
 AT FACE OF WALL NOT PERMITTED. REMOVE CMU & REPLACE AS REQ'D TO MATCH
- 33. INSTALL/TOOTH IN NEW CMU AT NEW OPENING IN EXISTING CMU WALL AS REQ'D.
 INSTALL BULLNOSE CMU AT ALL OUTSIDE CORNERS.
- 34. REMOVE EXISTING TV POWER/COAXIAL WALL OUTLET CABLING, BACK BOX, CONDUIT ETC. RE-ROUTE / TERMINATE EX. WIRING AS APPLICABLE. INFILL OPENING IN WALL WITH CMU TO MATCH ADJACENT. REFER TO ELECTRICAL DRAWINGS.
- 35. REPAIR EXISTING CONCRETE SLAB AS REQ'D, WHERE EXISTING ELECTRICAL FLOOR BOXES WERE REMOVED. REFER TO ELECTRICAL DRAWINGS.
- 36. REPAIR/REPLACE EXISTING CMU SOAPS AS REQ'D AT EXISTING STEEL LINTEL. PREP & PAINT.
- 31. REPAIR/REPLACE CMU AS REQ'D WHERE EXISTING WALL HEATER WAS REMOVED. BLOCK FILL, PRIME, & PAINT. REFER TO INTERIOR ELECATIONS.
- 38. REMOVE/TOOTH CMU BLOCK/SOAPS AS REQ'D TO INSTALL NEW ELECTRICAL BOXES, CONDUIT, DEVICES, ETC. WITHIN EXISTING CMU WALL. INSTALL NEW CMU BLOCK/SOAPS AS REQ'D TO REPAIR WALL AND PROVIDE A UNIFORM FINISHED APPEARANCE. REFER TO DETAIL B/AI.15.

REPAIR SCOPE NOTES ARE INTENDED TO ILLUSTRATE GENERAL INTENT OF REQUIREMENTS. CONTRACTOR TO FIELD VERIFY CONDITIONS & COORDINATE WITH OWNER AS APPLICABLE TO DETERMINE ROUTING, CONFLICTS, ETC. SCOPE NOTES ARE APPLICABLE TO OTHER SIMILAR CONDITIONS WHICH MAY NOT BE SPECIFICALLY IDENTIFIED ON DRAWINGS, BUT REQUIRED FOR EXECUTION OF PROJECT. REFER TO PME DRAWINGS.

REPAIR EXISTING CMU/WALL FINISHES AS REQUIRED BY THE REMOVAL OF THE EXISTING MARKERBOARDS/CHALKBOARD/TACKBOARDS.

CONTRACTOR SHALL COORDINATE & ENSURE EXISTING BRANCH CIRCUITRY IS STILL OPERATIONAL AFTER SELECTIVE DEMOLITION. INTENT IS TO RE-ENERGIZE/RE-CONNECT ALL BRANCH CIRCUITRY WHICH IS DOWNSTREAM FROM ANY DEMOLITION WORK. FIELD COORDINATE CONDITIONS.

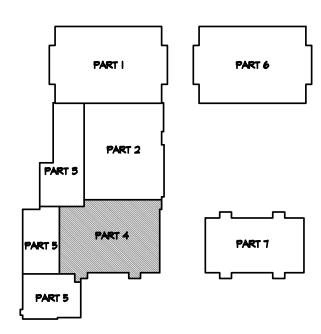

KEY PLAN

NOT TO SCALE



JONATHAN ROBERT SCHAAF 14503

Jonathan Robert Schaaf #14503

Expiration Date 12/31/2023

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January 24, 2022


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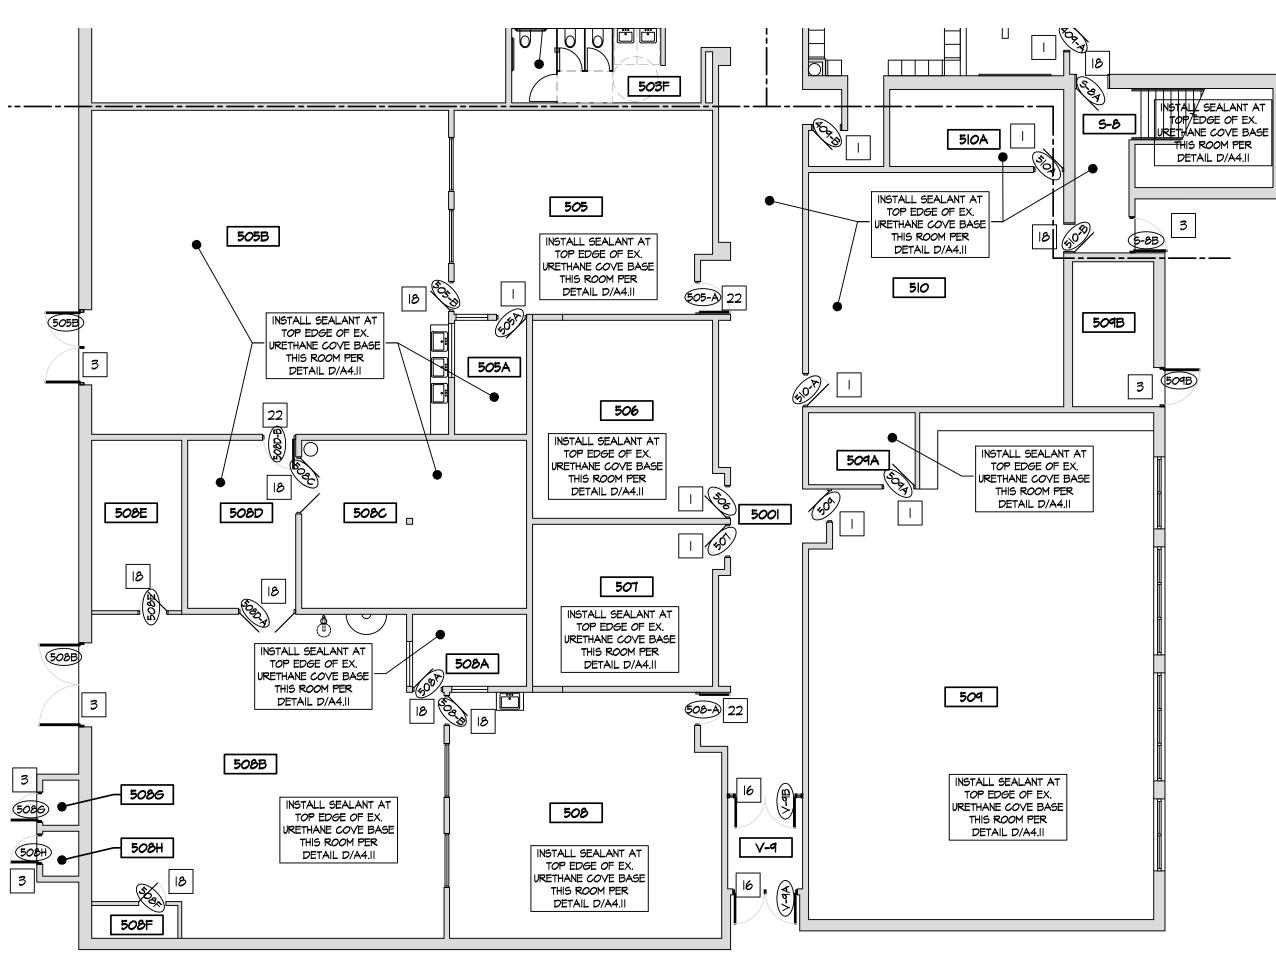
FIRST FLOOR REPAIR PLAN
PART '4'

Sheet Number

A1.45

ROOM INDEX							
#	NAME	#	NAME	#	NAME	#	NAME
V-8	VESTIBULE	502B	OFFICE	504	MEETING	508D	STORAGE
V-9	VESTIBULE	5020	TOILET	504A	BOY'S TOILET	508E	STORAGE
5-8	STAIR	502D	LOUNGE	505	CLASSROOM	508F	DATA
3003B	CORRIDOR	502E	OFFICE	505A	OFFICE	509	CLASSROOM
5001	CORRIDOR	503	MEDIA	505B	LAB	509A	OFFICE
500	CLASSROOM	503A	STORAGE	506	LAB	510	CLASSROOM
500A	STORAGE	503B	STORAGE	507	LAB	510A	STORAGE
501	CLASSROOM	5030	STORAGE	508	CLASSROOM	510B	STORAGE
50IA	STORAGE	503D	STORAGE	508A	OFFICE		
502	TECHNOLOGY	503E	OFFICE	508B	LAB		
502A	OFFICE	503F	GIRL'S TOILET	508C	MECHANICAL		



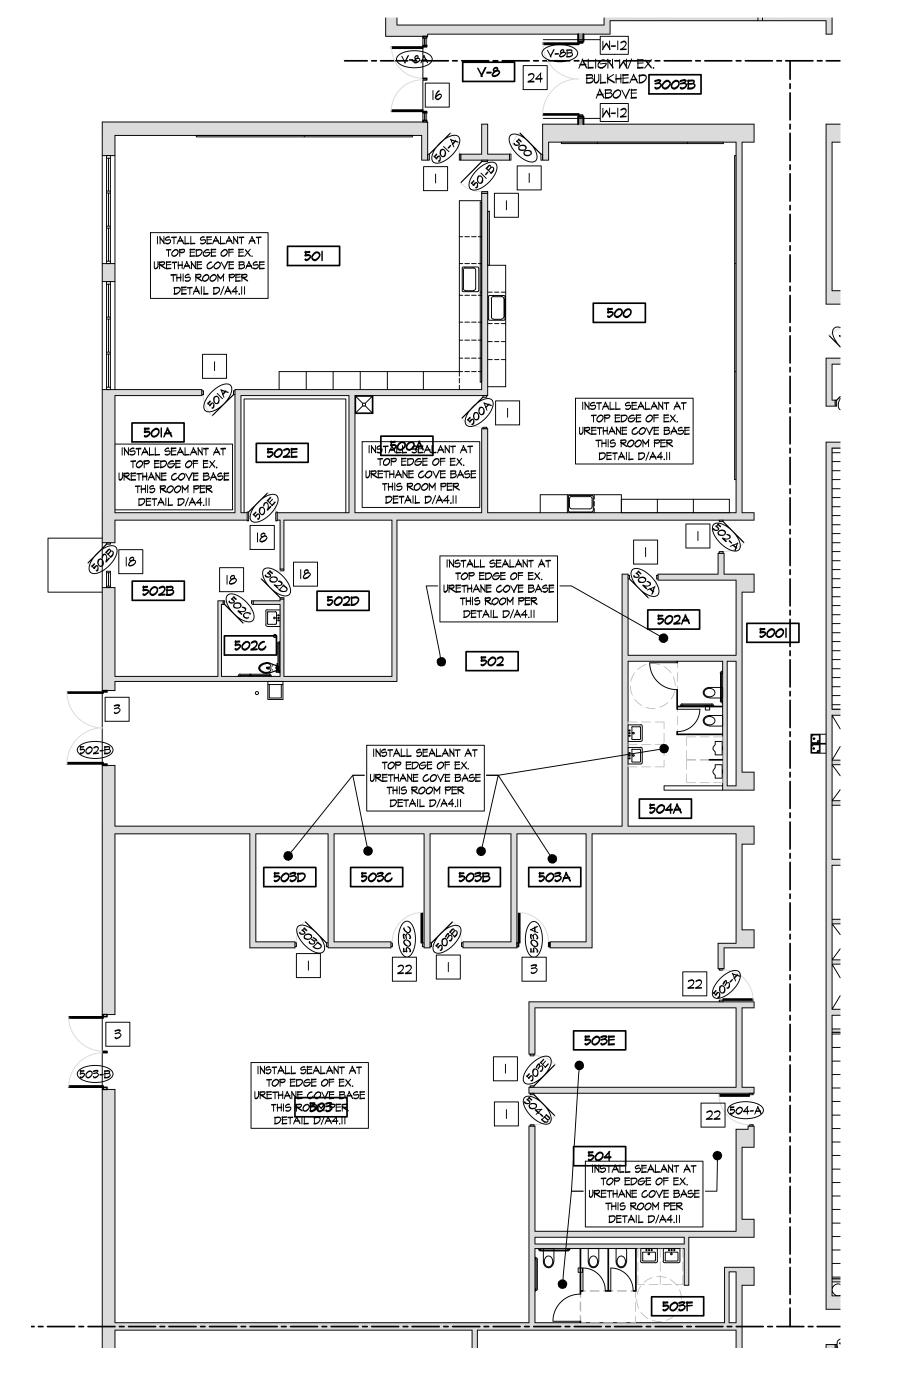


PROPOSED FIRST FLOOR PLAN - BUILDING PART '5'

SCALE: 3/32" = 1'-0"



SCALE: 3/32" = 1'-0"

PROPOSED FIRST FLOOR PLAN - BUILDING PART '5'

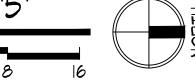


SPECIFIED. REFER TO DOOR SCHEDULE AND SPECIFICATIONS.

- 3. INSTALL NEW DOOR AND FRAME IN EXISTING OPENING. REFER TO DOOR
- 4. INSTALL NEW WINDOW IN NEW OPENING. REFER TO WINDOW SCHEDULE.
- 5. INSTALL NEW TACKBOARD. SEE SCHEDULE.
- 6. INSTALL NEW MAGNETIC MARKER BOARD. SEE SCHEDULE.
- 7. INFILL EXISTING OPENING W/ CMU, TOOTH INTO EXISTING, MATCH EX. EACH SIDE.
- PLUMBING DRAWINGS.

- 14. FURNITURE & EQUIPMENT BY OWNER.
- REFER TO INTERIOR ELEVATIONS.
- 18. EXISTING DOOR AND HOLLOW METAL FRAME TO REMAIN. METAL DOORS: REPAIR, PREP, PAINT, & INSTALL NEW HARDWARE AS SPECIFIED; WOOD DOORS: INSTALL NEW HARDWARE AS SPECIFIED. REFER TO DOOR SCHEDULE AND SPECIFICATIONS.
- 20. INSTALL WALL COVERING [WC-I] ON EX. GYP. BD. WALL TO 36" A.F.F.
- 21. INSTALL WALL COVERING [WC-I] FULL HEIGHT TO UNDERSIDE OF CEILING AT
- 22. INSTALL NEW DOOR & HARDWARE AS SPECIFIED, IN EXISTING HOLLOW METAL
- VESTIBULE DOORS.
- REFER TO DETAIL N/A2.71.
- 26. INSTALL NEW SOLID SURFACE COUNTERTOP AND STEEL SUPPORTS IN CONTROL ROOM. REFER TO F/A2.91.

NEW CONSTRUCTION KEY NOTES

EXISTING SOLID CORE WOOD DOOR AND HOLLOW METAL FRAME TO REMAIN. REPAIR & RE-FINISH EX. WOOD DOOR SLAB AND INSTALL NEW HARDWARE AS

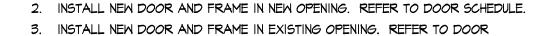

8. NO WORK THIS AREA. 9. INSTALL NEW HIGH-LOW DRINKING FOUNTAIN WITH BOTTLE FILLER. REFER TO

IO. INSTALL NEW LOW DRINKING FOUNTAIN WITH BOTTLE FILLER. REFER TO PLUMBING

DRAWINGS.

II. ROOM SIGNAGE PROVIDED AND INSTALLED BY OWNER. 12. INSTALL NEW PARTITION WALL, REFER TO WALL TYPES.

13. NEW CASEWORK - SEE INTERIOR ELEVATIONS

15. NEW LOCKERS & BLOCKING BY OWNER, SET ON NEW/EXISTING LOCKER BASES.

16. INSTALL NEW STOREFRONT SYSTEM AND DOOR. REFER TO WINDOW & DOOR SCHEDULES.

17. WALL MOUNTED TY/DISPLAY BY OWNER - INSTALLED BY CONTRACTOR, PROVIDE POWER/DATA - REFER TO ELECTRICAL DRAWINGS.

19. PREP AND PAINT EXISTING WALLS IN CONTROL ROOM [P-6]. REMOVE EXISTING FLOORING AND INSTALL NEW CARPET [F-6].

EMERGENCY SHOWER. INSTALL STAINLESS STEEL WALL CAP FULL HEIGHT.

FRAME. REFER TO DOOR SCHEDULE AND SPECIFICATIONS.

23. EXISTING METAL GATE TO REMAIN. REFER TO INTERIOR ELEVATIONS.

24. NEW METAL STUD WALL / DOOR / FRAME / HARDWARE AT LOCATION OF ORIGINAL

25. INSTALL NEW ANODIZED ALUMINUM WALL MOUNTED HANDRAILS EA. SIDE OF RAMP.

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FIRST FLOOR PLAN

2021-203

Sheet Title


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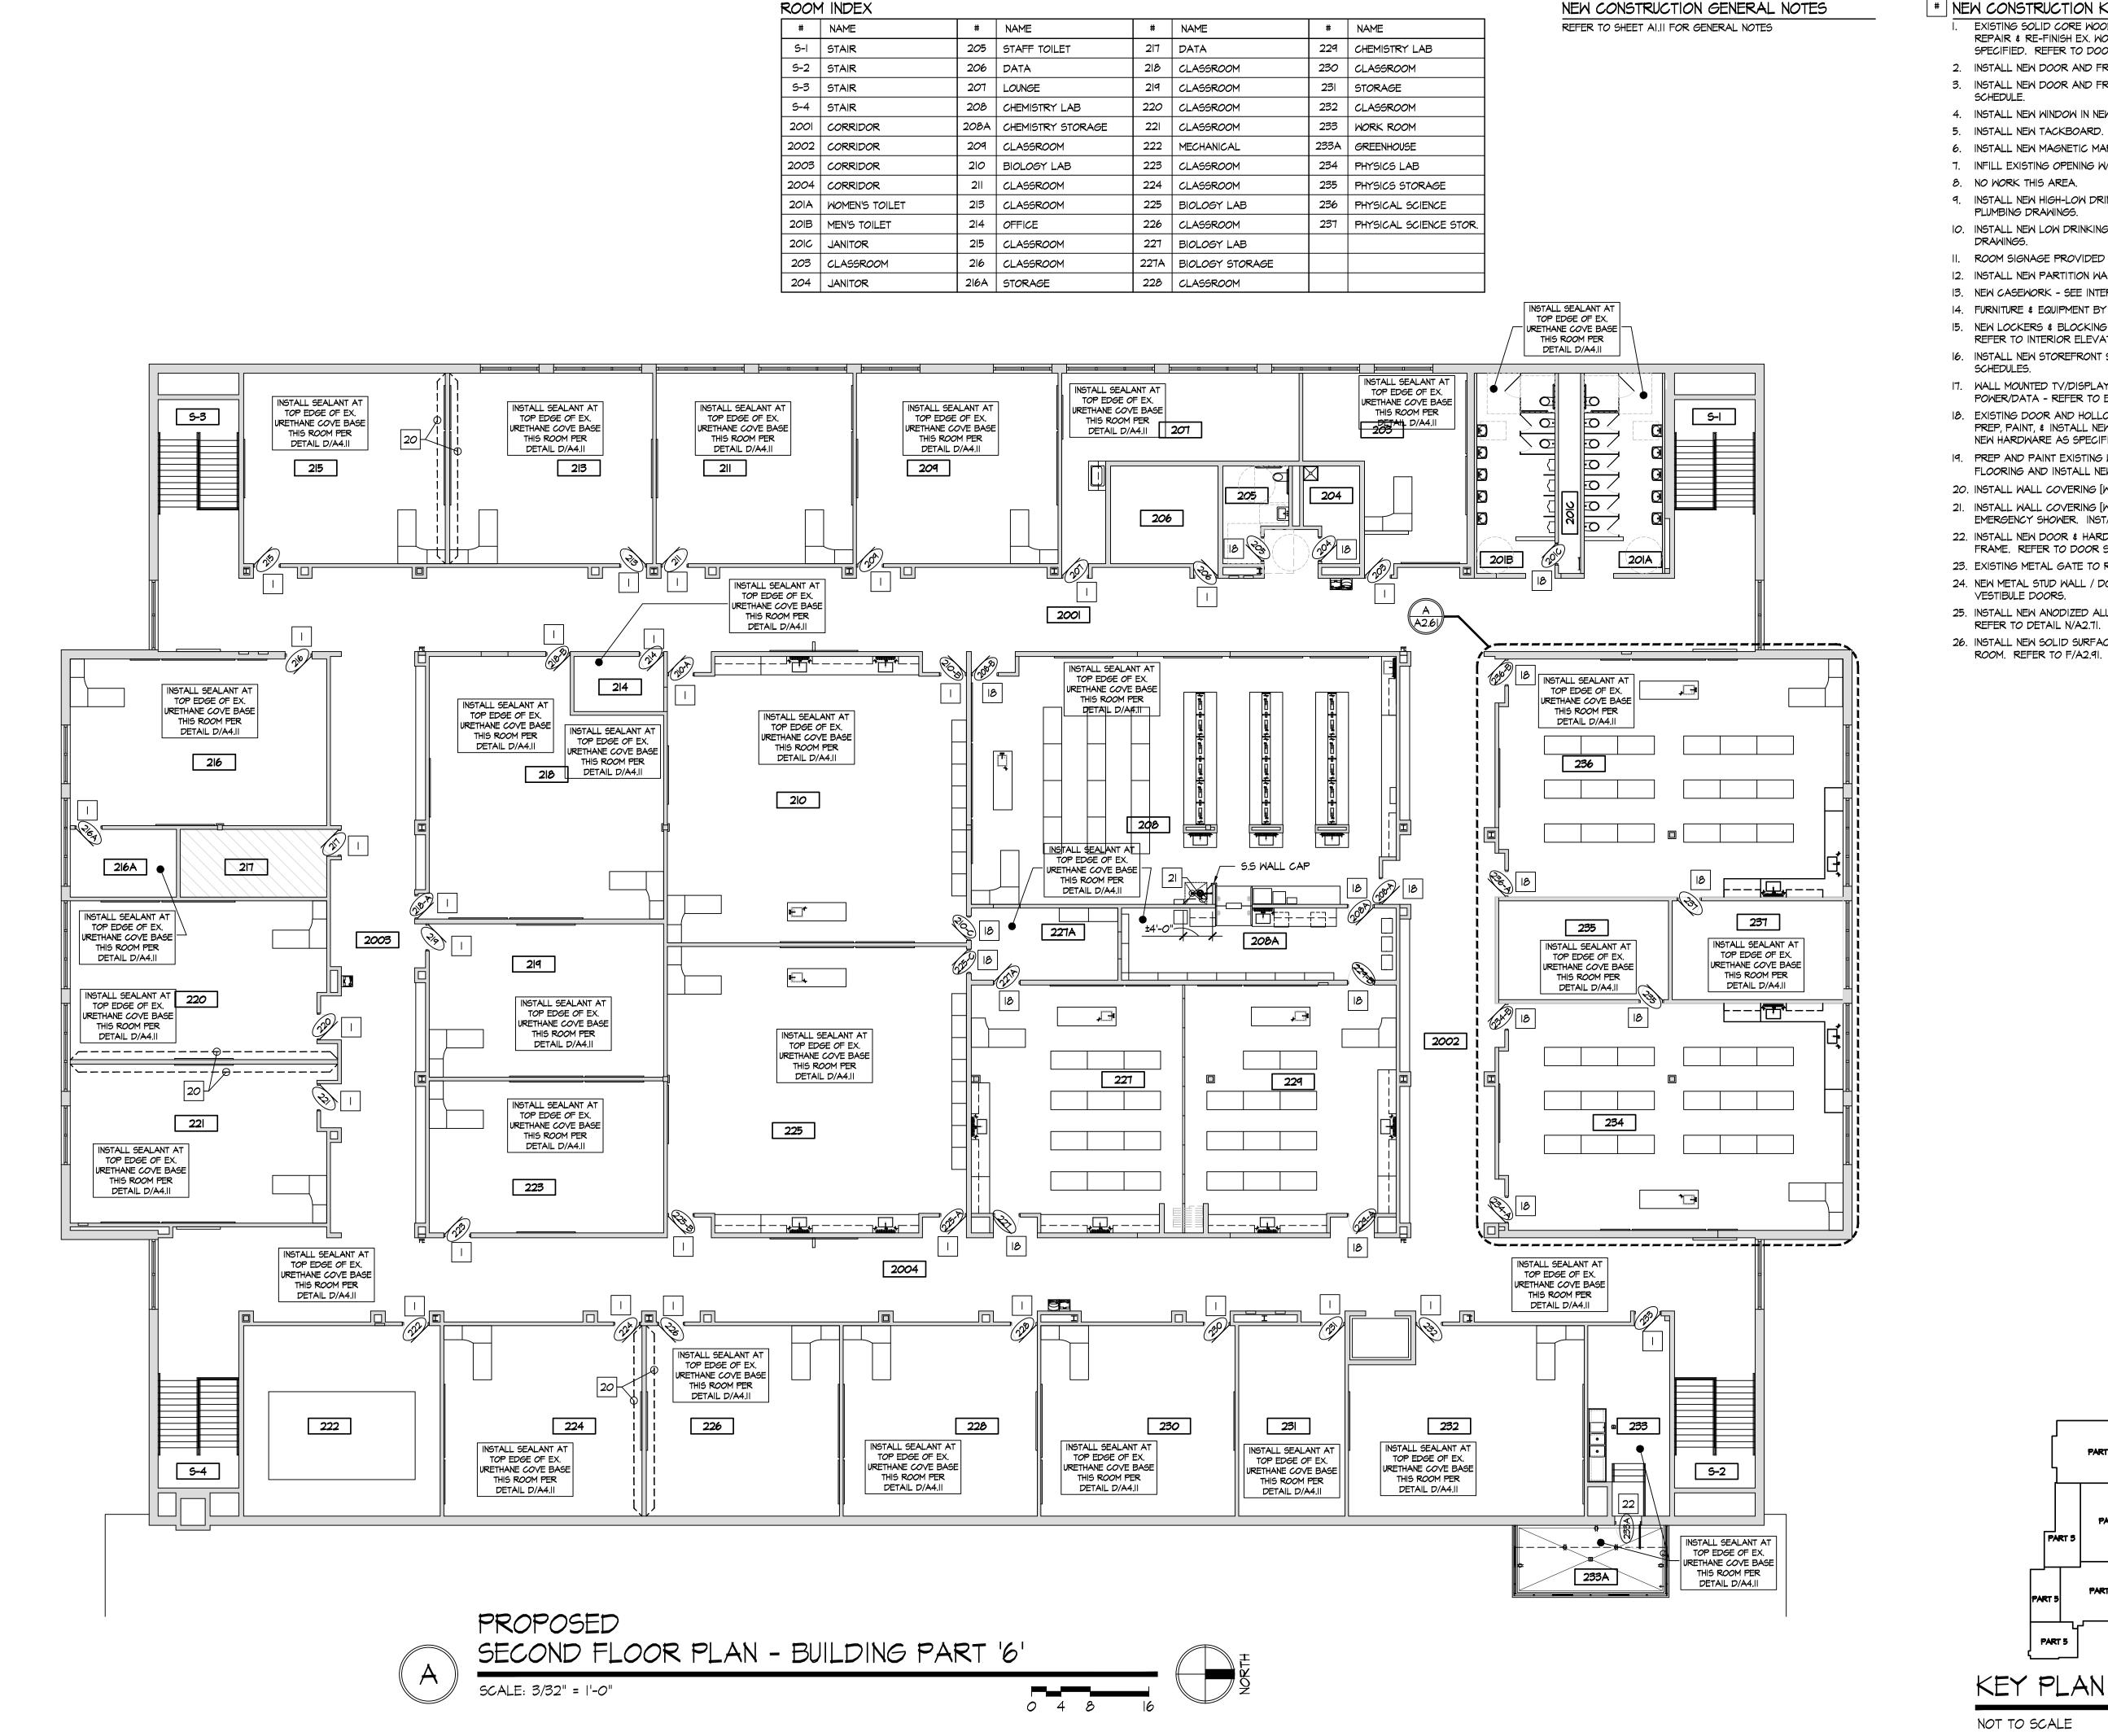
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PART '5' Sheet Number



NEW CONSTRUCTION KEY NOTES

- SPECIFIED. REFER TO DOOR SCHEDULE AND SPECIFICATIONS.
- 2. INSTALL NEW DOOR AND FRAME IN NEW OPENING. REFER TO DOOR SCHEDULE.
- 3. INSTALL NEW DOOR AND FRAME IN EXISTING OPENING. REFER TO DOOR
- 5. INSTALL NEW TACKBOARD. SEE SCHEDULE.
- 7. INFILL EXISTING OPENING W/ CMU, TOOTH INTO EXISTING, MATCH EX. EACH SIDE.
- 9. INSTALL NEW HIGH-LOW DRINKING FOUNTAIN WITH BOTTLE FILLER. REFER TO
- II. ROOM SIGNAGE PROVIDED AND INSTALLED BY OWNER.
- 13. NEW CASEMORK SEE INTERIOR ELEVATIONS
- 15. NEW LOCKERS & BLOCKING BY OWNER, SET ON NEW/EXISTING LOCKER BASES.
- 16. INSTALL NEW STOREFRONT SYSTEM AND DOOR. REFER TO WINDOW & DOOR
- 17. WALL MOUNTED TY/DISPLAY BY OWNER INSTALLED BY CONTRACTOR, PROVIDE
- 18. EXISTING DOOR AND HOLLOW METAL FRAME TO REMAIN. METAL DOORS: REPAIR,
- 19. PREP AND PAINT EXISTING WALLS IN CONTROL ROOM [P-6]. REMOVE EXISTING FLOORING AND INSTALL NEW CARPET [F-6].
- 20. INSTALL WALL COVERING [WC-I] ON EX. GYP. BD. WALL TO 36" A.F.F.
- 21. INSTALL WALL COVERING [WC-1] FULL HEIGHT TO UNDERSIDE OF CEILING AT
- 22. INSTALL NEW DOOR & HARDWARE AS SPECIFIED, IN EXISTING HOLLOW METAL FRAME. REFER TO DOOR SCHEDULE AND SPECIFICATIONS.
- VESTIBULE DOORS.
- 25. INSTALL NEW ANODIZED ALUMINUM WALL MOUNTED HANDRAILS EA. SIDE OF RAMP. REFER TO DETAIL N/A2.71.
- ROOM. REFER TO F/A2.91.

- EXISTING SOLID CORE WOOD DOOR AND HOLLOW METAL FRAME TO REMAIN. REPAIR & RE-FINISH EX. WOOD DOOR SLAB AND INSTALL NEW HARDWARE AS

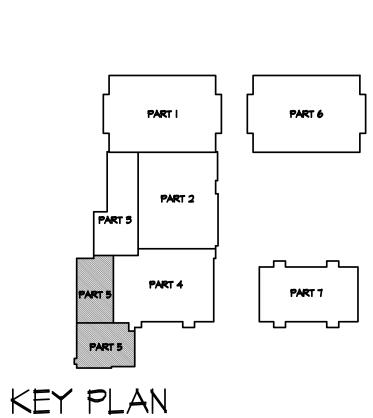- 4. INSTALL NEW WINDOW IN NEW OPENING. REFER TO WINDOW SCHEDULE.
- 6. INSTALL NEW MAGNETIC MARKER BOARD. SEE SCHEDULE.
- 8. NO WORK THIS AREA.
- PLUMBING DRAWINGS. 10. INSTALL NEW LOW DRINKING FOUNTAIN WITH BOTTLE FILLER. REFER TO PLUMBING
- DRAWINGS.
- 12. INSTALL NEW PARTITION WALL, REFER TO WALL TYPES.
- 14. FURNITURE & EQUIPMENT BY OWNER.
- REFER TO INTERIOR ELEVATIONS.
- SCHEDULES.
- POWER/DATA REFER TO ELECTRICAL DRAWINGS.
- PREP, PAINT, & INSTALL NEW HARDWARE AS SPECIFIED; WOOD DOORS: INSTALL NEW HARDWARE AS SPECIFIED. REFER TO DOOR SCHEDULE AND SPECIFICATIONS.

- EMERGENCY SHOWER. INSTALL STAINLESS STEEL WALL CAP FULL HEIGHT.
- 23. EXISTING METAL GATE TO REMAIN. REFER TO INTERIOR ELEVATIONS.
- 24. NEW METAL STUD WALL / DOOR / FRAME / HARDWARE AT LOCATION OF ORIGINAL
- 26. INSTALL NEW SOLID SURFACE COUNTERTOP AND STEEL SUPPORTS IN CONTROL

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TE OF . JONATHAN ROBERT SCHAAF Jonathan Robert Schaaf #14503 Expiration Date 12/31/2023

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Sheet Title

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PART '6'

Date

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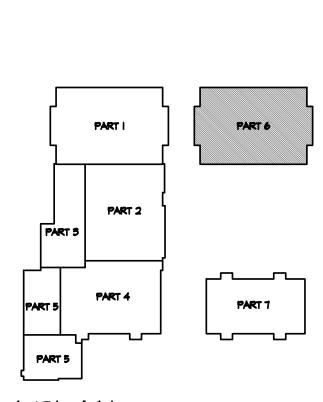
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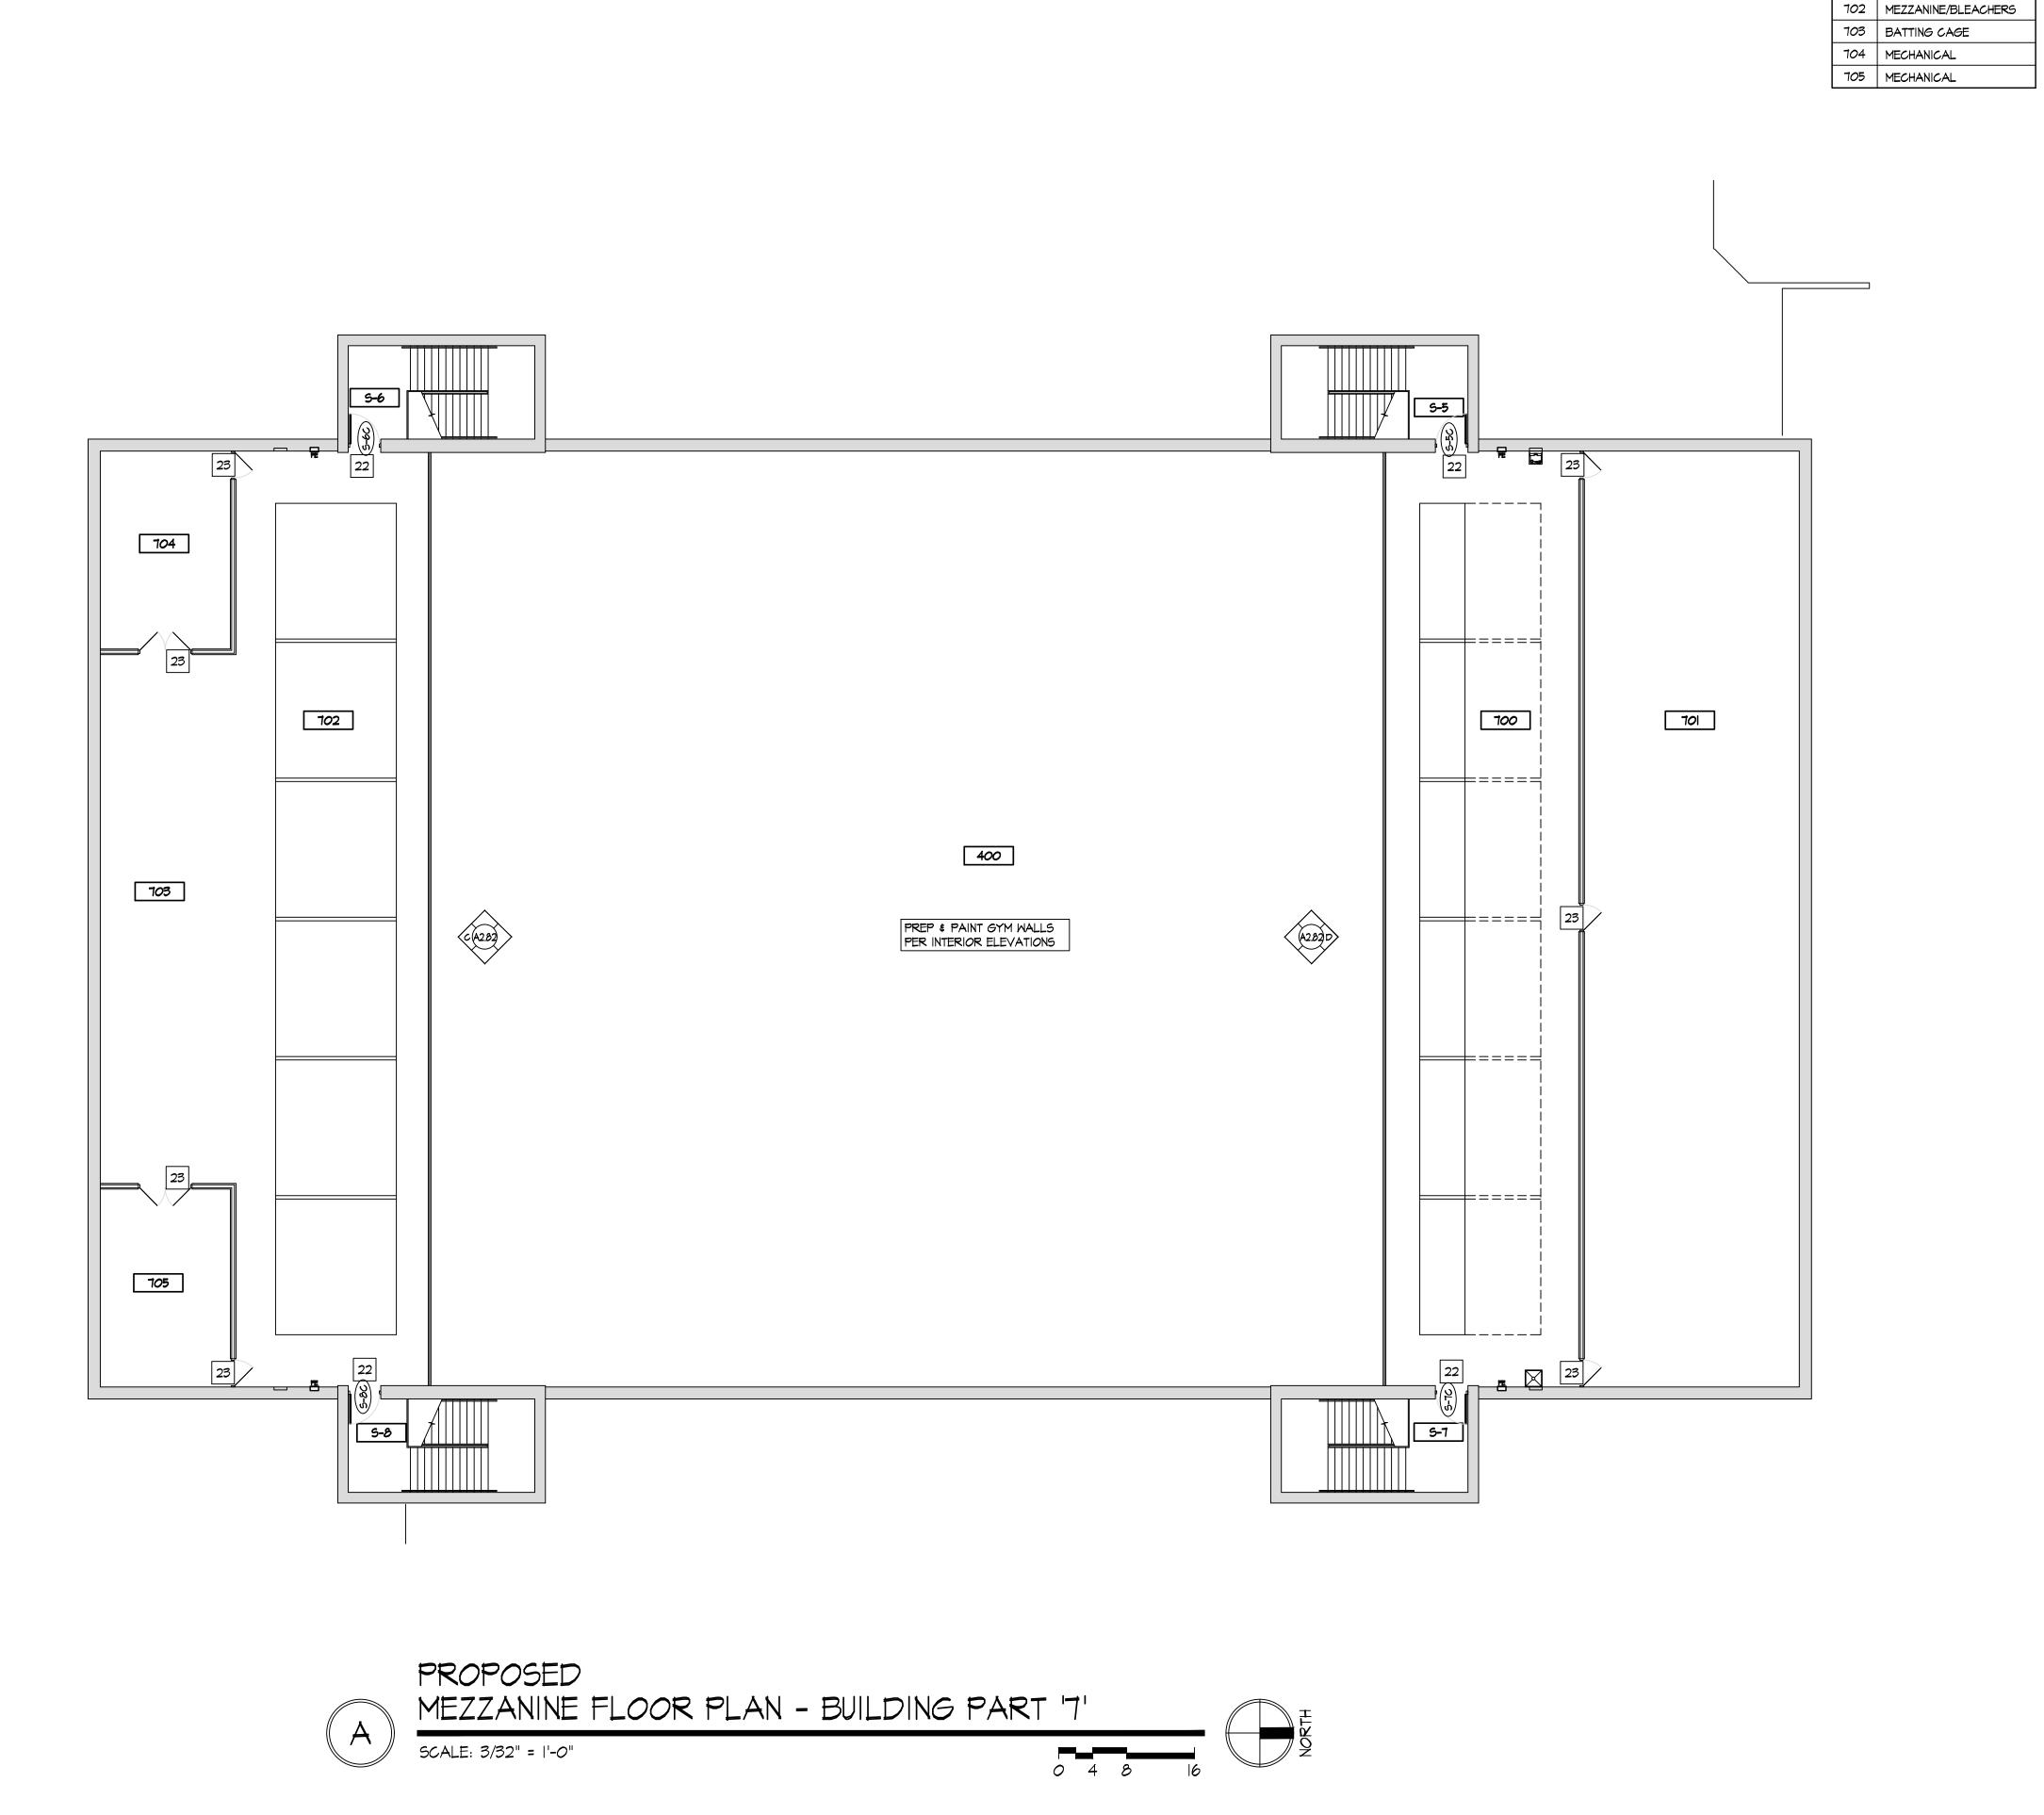
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Sheet Number

SECOND FLOOR PLAN



ROOM INDEX

NAME

S-5 STAIR

S-6 STAIR

S-7 STAIR

S-8 STAIR

400 GYMNASIUM

701 WEIGHT ROOM

700 MEZZANINE/BLEACHERS

SPECIFIED. REFER TO DOOR SCHEDULE AND SPECIFICATIONS.

2. INSTALL NEW DOOR AND FRAME IN NEW OPENING. REFER TO DOOR SCHEDULE.

5. INSTALL NEW TACKBOARD. SEE SCHEDULE.

6. INSTALL NEW MAGNETIC MARKER BOARD. SEE SCHEDULE.

7. INFILL EXISTING OPENING W/ CMU, TOOTH INTO EXISTING, MATCH EX. EACH SIDE.

8. NO WORK THIS AREA. 9. INSTALL NEW HIGH-LOW DRINKING FOUNTAIN WITH BOTTLE FILLER. REFER TO

IO. INSTALL NEW LOW DRINKING FOUNTAIN WITH BOTTLE FILLER. REFER TO PLUMBING

DRAWINGS.

12. INSTALL NEW PARTITION WALL, REFER TO WALL TYPES.

13. NEW CASEWORK - SEE INTERIOR ELEVATIONS

15. NEW LOCKERS & BLOCKING BY OWNER, SET ON NEW/EXISTING LOCKER BASES. REFER TO INTERIOR ELEVATIONS.

16. INSTALL NEW STOREFRONT SYSTEM AND DOOR. REFER TO WINDOW & DOOR

PREP, PAINT, & INSTALL NEW HARDWARE AS SPECIFIED; WOOD DOORS: INSTALL

FLOORING AND INSTALL NEW CARPET [F-6].

20. INSTALL WALL COVERING [WC-I] ON EX. GYP. BD. WALL TO 36" A.F.F.

21. INSTALL WALL COVERING [WC-I] FULL HEIGHT TO UNDERSIDE OF CEILING AT

FRAME. REFER TO DOOR SCHEDULE AND SPECIFICATIONS.

23. EXISTING METAL GATE TO REMAIN. REFER TO INTERIOR ELEVATIONS.

VESTIBULE DOORS.

REFER TO DETAIL N/A2.71.

ROOM. REFER TO F/A2.91.

NEW CONSTRUCTION KEY NOTES

EXISTING SOLID CORE WOOD DOOR AND HOLLOW METAL FRAME TO REMAIN. REPAIR & RE-FINISH EX. WOOD DOOR SLAB AND INSTALL NEW HARDWARE AS

3. INSTALL NEW DOOR AND FRAME IN EXISTING OPENING. REFER TO DOOR

4. INSTALL NEW WINDOW IN NEW OPENING. REFER TO WINDOW SCHEDULE.

PLUMBING DRAWINGS.

II. ROOM SIGNAGE PROVIDED AND INSTALLED BY OWNER.

14. FURNITURE & EQUIPMENT BY OWNER.

SCHEDULES.

17. WALL MOUNTED TV/DISPLAY BY OWNER - INSTALLED BY CONTRACTOR, PROVIDE POWER/DATA - REFER TO ELECTRICAL DRAWINGS.

18. EXISTING DOOR AND HOLLOW METAL FRAME TO REMAIN. METAL DOORS: REPAIR, NEW HARDWARE AS SPECIFIED. REFER TO DOOR SCHEDULE AND SPECIFICATIONS.

19. PREP AND PAINT EXISTING WALLS IN CONTROL ROOM [P-6]. REMOVE EXISTING

EMERGENCY SHOWER. INSTALL STAINLESS STEEL WALL CAP FULL HEIGHT. 22. INSTALL NEW DOOR & HARDWARE AS SPECIFIED, IN EXISTING HOLLOW METAL

24. NEW METAL STUD WALL / DOOR / FRAME / HARDWARE AT LOCATION OF ORIGINAL

25. INSTALL NEW ANODIZED ALUMINUM WALL MOUNTED HANDRAILS EA. SIDE OF RAMP.

26. INSTALL NEW SOLID SURFACE COUNTERTOP AND STEEL SUPPORTS IN CONTROL

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2021-203

Sheet Title

PROPOSED

Sheet Number

PART '7'


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KEY PLAN

NOT TO SCALE

MEZZANINE FLOOR PLAN

REPAIR GENERAL NOTES

- I. CONTRACTOR TO FIELD VERIFY ALL DIMENSIONS & CONDITIONS.
- COORDINATE WORK WITH APPLICABLE PLUMBING, MECHANICAL, AND ELECTRICAL DRAWINGS
 AS REQUIRED. PROVIDE ANY REQUIRED ACCESS PANELS, ETC. TO ACCESS CONCEALED
 WORK.
- 3. FINISHES: COORDINATE ALL WITH OWNER.

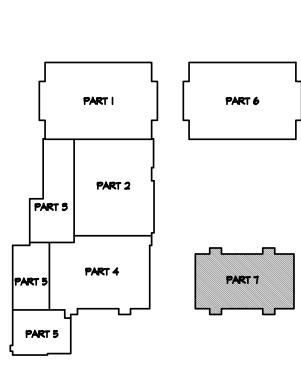
WITH OWNER AS APPLICABLE.

- 4. PATCH ALL EX. WALLS AS REQ'D INCLUDING SCARS FROM DEMOLITION, NEW WIRING, ETC. TO LIKE NEW CONDITION. MATCH ADJACENT AS APPLICABLE.
- 5. REMOVE ANY / ALL WALL MOUNTED ITEMS AS REQ'D FOR NEW PAINTING.
- SHALL BE FIRE RETARDANT TREATED (FRT).

 7. COORDINATE ROUTING OF SURFACE MOUNTED CONDUITS, ETC. TO MINIMIZE IMPACT ON WALLS WITH VERTICAL CONDUITS RUNNING IN CORNERS OR OTHERWISE NOT OBJECTIONABLE LOCATIONS. EXTEND HORIZONTALLY ALONG WALL TO FEED DEVICES. FIELD COORDINATE

6. PROVIDE ANY / ALL BLOCKING NEEDED FOR INSTALLATION. ALL BLOCKING & FURRING

- 8. TOOTH ALL NEW MASONRY INTO EXISTING WHERE APPLICABLE.
- PROVIDE BULLNOSE CMU AT ALL NEW/MODIFIED OPENINGS, OUTSIDE CORNERS, & OTHER APPLICABLE LOCATIONS, TYP.
- IO. SCOPE NOTED ON PLUMBING, MECHANICAL, ELECTRICAL, & TELECOM DRAWINGS TAKES PRECEDENCE OVER ARCHITECTURAL DRAWINGS. REPAIR PLANS SHALL BE COORDINATED WITH ALL APPLICABLE ENGINEERING SHEETS & WORK SCOPE.

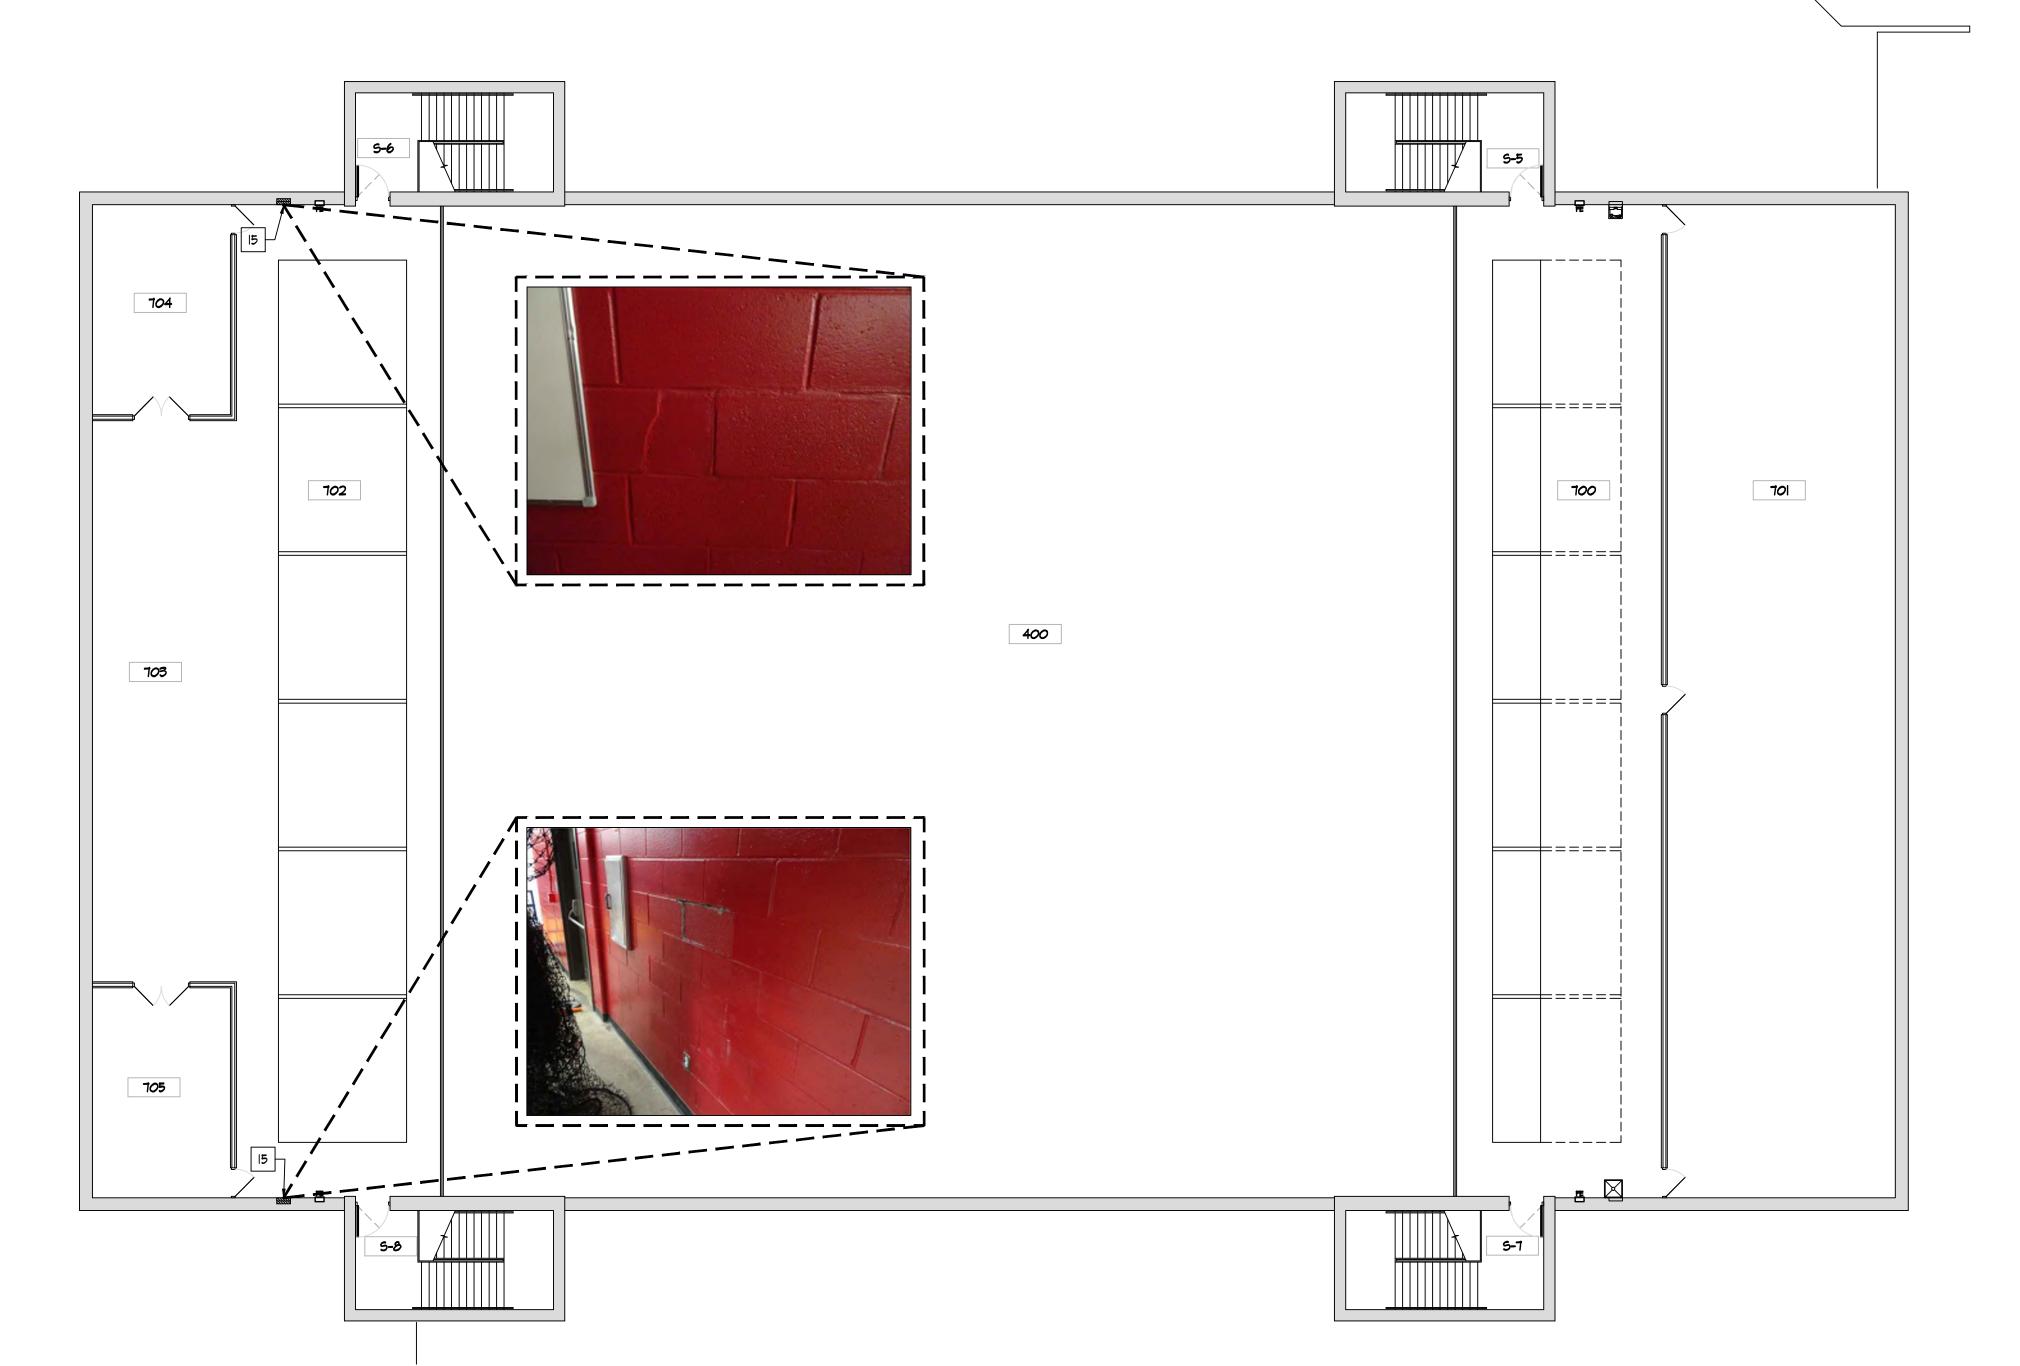

MEZZANINE REPAIR PLAN - BUILDING PART 'T' SCALE: 3/32" = 1'-0"

REPAIR KEY NOTES

- I. REMOVE EXISTING BLANK COVER PLATE, EXISTING BOX / DEVICE, ETC. TERMINATE EX. WIRING AS APPLICABLE. INFILL OPENING IN WALL WITH CMU TO MATCH ADJACENT. [EXAMPLES: BLANK PLATES, ABANDONED SWITCHES, ETC.]
- 2. REMOVE EXISTING SURFACE MOUNT PANDUIT / CONDUIT FROM WALL. RE-RUN EXISTING FEED WITHIN CMU WALL OR ABOVE CEILING. INSTALL NEW BOX, DEVICE, & COVER AS APPLICABLE. REFER TO ELECTRICAL DRAWINGS.
- 3. REMOVE EXISTING SURFACE MOUNTED DATA CABLING PANDUIT / CONDUIT FROM WALL. RE-RUN EXISTING DATA CABLING WITHIN CMU WALL. IF ROUTING WITHIN CMU WALL IS NOT POSSIBLE, RE-RUN EXISTING DATA CABLING THRU NEW PANDUIT / CONDUIT. INSTALL NEW ELECTRICAL DEVICE / LOW VOLTAGE BOX AND COVER PLATE AS APPLICABLE. FIELD COORDINATE ROUTING WITH OWNER.
- 4. REMOVE EXISTING SURFACE MOUNTED ELECTRICAL PANDUIT / CONDUIT FROM WALL. RE-RUN EXISTING ELECTRICAL FEED WITHIN CMU WALL. INSTALL NEW ELECTRICAL DEVICE / LOW VOLTAGE BOX AND COVER PLATE AS APPLICABLE. REFER TO ELECTRICAL DRAWINGS. FIELD COORDINATE ROUTING W/ OWNER.
- ELECTRICAL DRAWINGS. FIELD COORDINATE ROUTING W/ OWNER.

 5. REMOVE EXISTING WALL CLOCK AND ASSOCIATED WIRING. INFILL OPENING IN WALL
- WITH CMU TO MATCH ADJACENT. REFER TO ELECTRICAL DRAWINGS.

 6. REMOVE EXISTING SURFACE MOUNT PLUG MOLD. REFER TO ELECTRICAL DRAWINGS.
- 7. REMOVE EXISTING SURFACE MOUNT ELECTRICAL DEVICE & CONDUIT FROM WALL REFER TO ELECTRICAL DRAWINGS.
- REMOVE ABANDONED FIRE ALARM DEVICE. INFILL OPENING IN WALL WITH CMU TO MATCH ADJACENT.
- 9. RELOCATE EXISTING THERMOSTAT & CONTROL WIRING. REFER TO MECHANICAL DRAWINGS. F.Y. LOCATION WITH OWNER.
- IO. EXISTING THERMOSTAT TO REMAIN. REMOVE EXISTING VANDAL COVER, CONDUIT, BOX & RE-RUN IN NEW WHITE CONDUIT. REFER TO MECHANICAL DRAWINGS.
- BOX & RE-RUN IN NEW WHITE CONDUIT. REFER TO MECHANICAL DRAWINGS.

 II. REMOVE SURFACE MOUNTED LOW VOLTAGE / DATA DEVICE, BOX, EXISTING PANDUIT,

ETC. PULL DATA UP TO CEILING. REFER TO ELECTRICAL DRAWINGS.

- 12. RELOCATE EXISTING OFFICE CALL DEVICE. INFILL OPENING IN WALL WITH CMU TO MATCH ADJACENT. F.V. NEW LOCATION WITH OWNER. REFER TO ELECTRICAL DRAWINGS.
- 13. REPAIR EXISTING CMU WALL AS REQ'D, WHERE EXISTING WALL WAS REMOVED.
- 14. REPAIR EXISTING CONCRETE SLAB AS REQ'D, WHERE EXISTING WALL WAS REMOVED.
 [LIGHTWEIGHT CONCRETE AT SECOND FLOOR]
- 15. REPAIR/REPLACE EXISTING CRACKED/DAMAGED CMU AS REQ'D. PREP & PAINT.

 16. REMOVE EXISTING INSTALL NEW SEALANT AT CONTROL / EXPANSION JOINTS.
- REMOVE EXISTING ALUMINUM COVER IF APPLICABLE.

 17. REPAIR EXISTING CMU WALL AS REQ'D, WHERE EXISTING PLUMBING WAS REMOVED.
- 17. REPAIR EXISTING CMU WALL AS REQ D, WHERE EXISTING PLUMBING WAS REMOVED.

 18. REPAIR CRACK IN EXISTING CMU WALL. REFER TO STRUCTURAL DRAWINGS.
- 19. REPAIR EXISTING CMU WALL AS REQ'D, WHERE EXISTING LOCKERS WERE REMOVED.
- 20. REMOVE EXISTING ELECTRICAL DEVICE, EXISTING BOX, COVER PLATE, ETC.
 RE-ROUTE / TERMINATE EX. WIRING AS APPLICABLE. INFILL OPENING IN WALL WITH
 CMU TO MATCH ADJACENT. REFER TO ELECTRICAL DRAWINGS.
- 21. REMOVE EXISTING WALL MOUNTED OCCUPANCY SENSOR. REFER TO ELECTRICAL DRAWINGS.
- 22. REPAIR EXISTING CMU WALL AS REQ'D, WHERE EXISTING DRINKING FOUNTAIN WAS REMOVED. EXTEND EXISTING PLUMBING AND ELECTRICAL AS REQ'D. INFILL OPENING IN WALL WITH CMU TO MATCH ADJACENT. REFER TO PLUMBING & ELECTRICAL DRAWINGS.
- 23. REPAIR EXISTING CMU WALL AS REQ'D, WHERE EXISTING OPERABLE PARTITION WAS REMOVED. INFILL OPENING IN WALL WITH CMU TO MATCH ADJACENT.
- 24. REPAIR EXISTING CMU WALL AS REQ'D, WHERE EXISTING DOOR AND FRAME WAS
- 25. REPAIR/REPLACE DETERIORATED STEEL LINTEL. REFER TO STRUCTURAL DRAWINGS.
- 26. REMOVE EXISTING ELECTRICAL DEVICE, EXISTING BOX, COVER PLATE, ETC.
 RE-ROUTE / TERMINATE EX. WIRING AS APPLICABLE.
- 27. RELOCATE EXISTING SWITCH AND DATA CABLING TO ABOVE CEILING. REF. TO ELEC.
 28. EXISTING FIRE ALARM DEVICE & CONDUIT TO REMAIN. PAINT CONDUIT TO MATCH
- 29. REMOVE EXISTING POWER / DATA POLE. PULL DATA AND ELECTRICAL UP TO CEILING & TERMINATE AS REQ'D.
- 30. INSTALL NEW 5" CONCRETE SLAB AS REQ'D, WHERE EXISTING SLAB WAS REMOVED FOR UNDER SLAB PLUMBING WORK. FINISH FLUSH WITH EXISTING ADJACENT.
- 31. REMOVE EXISTING TV POWER/COAXIAL WALL OUTLET CABLING. EXISTING BACK BOX, AND CONDUIT TO REMAIN, INSTALL BLANK COVER PLATE.
- 32. REPAIR CMU FROM REMOVAL OF PLUMBING ROUGH-INS. WALL CAPS/ESCUTCHEONS AT FACE OF WALL NOT PERMITTED. REMOVE CMU & REPLACE AS REQ'D TO MATCH
- ADJACENT WALL.

 33. INSTALL/TOOTH IN NEW CMU AT NEW OPENING IN EXISTING CMU WALL AS REQ'D.
- INSTALL BULLNOSE CMU AT ALL OUTSIDE CORNERS.
- 34. REMOVE EXISTING TV POWER/COAXIAL WALL OUTLET CABLING, BACK BOX, CONDUIT ETC. RE-ROUTE / TERMINATE EX. WIRING AS APPLICABLE. INFILL OPENING IN WALL WITH CMU TO MATCH ADJACENT. REFER TO ELECTRICAL DRAWINGS.
- 35. REPAIR EXISTING CONCRETE SLAB AS REQ'D, WHERE EXISTING ELECTRICAL FLOOR BOXES WERE REMOVED. REFER TO ELECTRICAL DRAWINGS.
 36. REPAIR/REPLACE EXISTING CMU SOAPS AS REQ'D AT EXISTING STEEL LINTEL. PREP \$
- PAINT.

 37 REPAIR/REPLACE CMLAS REGIO WHERE EXISTING WALL HEATER WAS REMOVED.
- 37. REPAIR/REPLACE CMU AS REQ'D WHERE EXISTING WALL HEATER WAS REMOVED.
 BLOCK FILL, PRIME, & PAINT. REFER TO INTERIOR ELECATIONS.
 38. REMOVE/TOOTH CMU BLOCK/SOAPS AS REQ'D TO INSTALL NEW ELECTRICAL BOXES,

CONDUIT, DEVICES, ETC. WITHIN EXISTING CMU WALL. INSTALL NEW CMU BLOCK/SOAPS AS REQ'D TO REPAIR WALL AND PROVIDE A UNIFORM FINISHED APPEARANCE. REFER

TO DETAIL B/AI.15.


REPAIR SCOPE NOTES ARE INTENDED TO ILLUSTRATE GENERAL INTENT OF REQUIREMENTS. CONTRACTOR TO FIELD VERIFY CONDITIONS \$

CONDITIONS WHICH MAY NOT BE SPECIFICALLY IDENTIFIED ON DRAWINGS, BUT REQUIRED FOR EXECUTION OF PROJECT. REFER TO PME DRAWINGS.

REPAIR EXISTING CMU/WALL FINISHES AS REQUIRED BY THE REMOVAL OF THE EXISTING MARKERBOARDS/CHALKBOARD/TACKBOARDS.

COORDINATE WITH OWNER AS APPLICABLE TO DETERMINE ROUTING, CONFLICTS, ETC. SCOPE NOTES ARE APPLICABLE TO OTHER SIMILAR

CONTRACTOR SHALL COORDINATE & ENSURE EXISTING BRANCH CIRCUITRY IS STILL OPERATIONAL AFTER SELECTIVE DEMOLITION. INTENT IS TO RE-ENERGIZE/RE-CONNECT ALL BRANCH CIRCUITRY WHICH IS DOWNSTREAM FROM ANY DEMOLITION WORK. FIELD COORDINATE CONDITIONS.

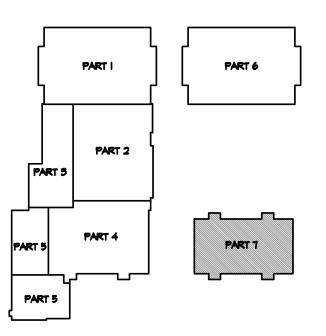

KEY PLAN

NOT TO SCALE



GROUP

ARCHITECTS

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Jonathan Robert Schaaf #14503

Expiration Date 12/31/2023

2022 Project at:

Igh School

Idian Trail

Ohio 45356

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Print Record

10/11/21 PRELIMINARY

01/24/22 BID SET/

CONSTRUCTION

Project Number

2021-203


Date
January 24, 2022


Sheet Title

MEZZANINE REPAIR PLAN PART '7'

Sheet Number

A1.75

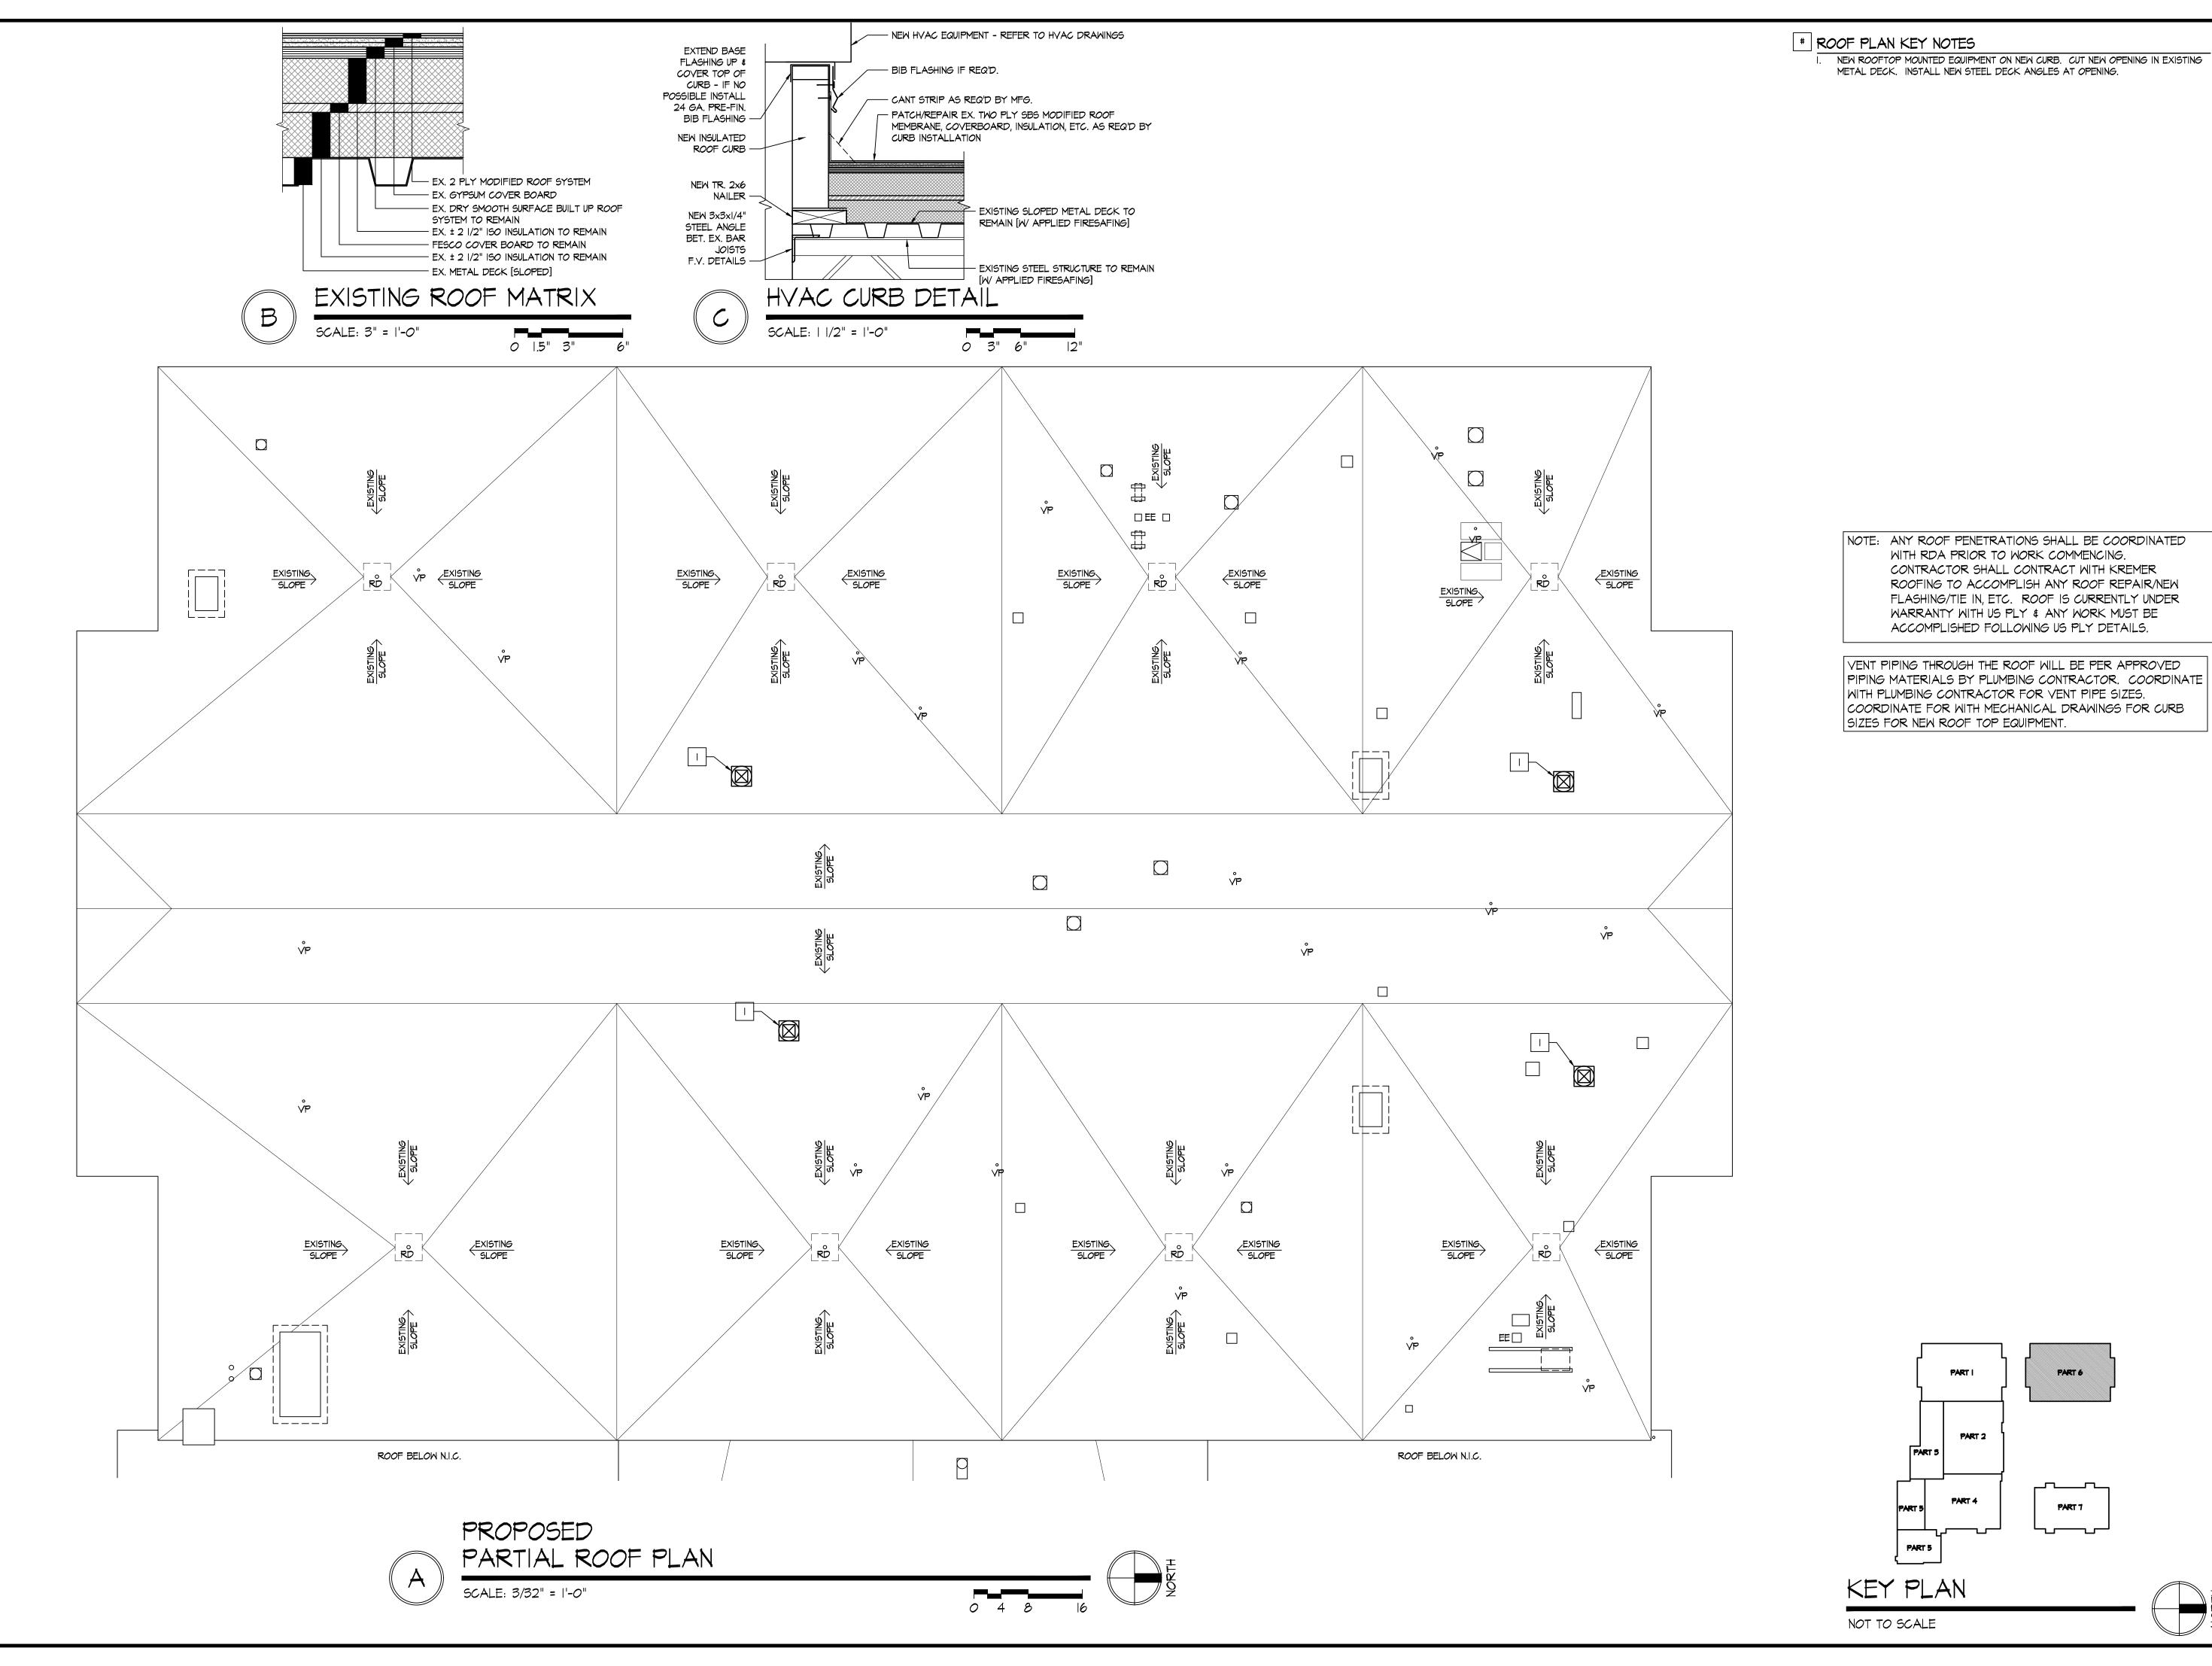

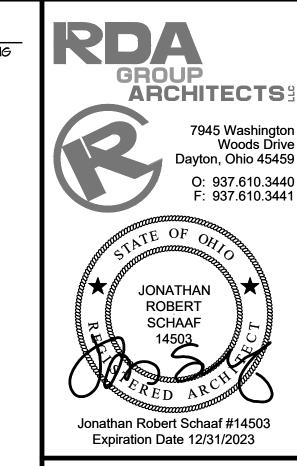

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Print Record

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12/07/21 DESIGN REVIEW

CONSTRUCTION

11/16/21 REVIEW

01/11/22 REVIEW 01/24/22 BID SET/

Project Number

January 24, 2022

PARTIAL ROOF PLAN

2021-203

Sheet Title

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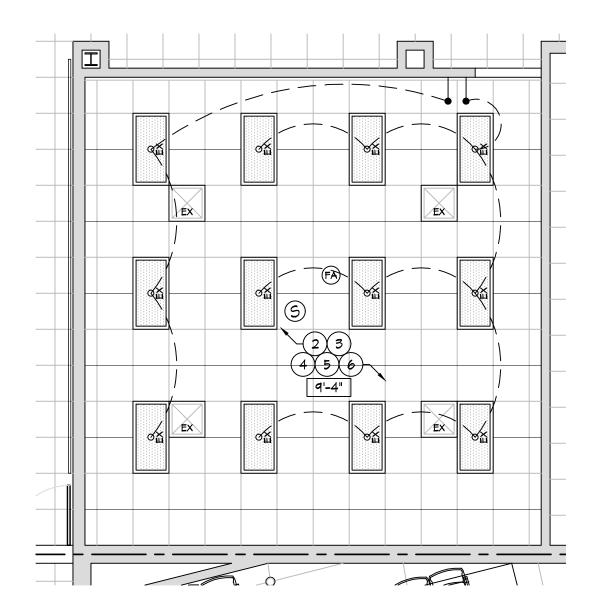
- INSTALL NEW 2x2 CEILING GRID AND ACOUSTIC CEILING TILES. REFER TO PLAN
- 2. EXISTING 2x4 CEILING GRID. INSTALL NEW GRID TEE. PAINT NEW & EXISTING CEILING GRID. INSTALL NEW 2x2 ACOUSTIC CEILING TILES.
- 3. RE-INSTALL EXISTING LIGHT FIXTURES INTO CEILING SYSTEM. REPLACE LENS. REFER TO PME DRAWINGS.
- 4. RE-INSTALL EXISTING HVAC DIFFUSERS INTO CEILING SYSTEM. REFER TO PME
- 5. RE-INSTALL EXISTING FIRE ALARM DEVICES INTO NEW CEILING SYSTEM.
- COORDINATE WITH PME DRAWINGS. 6. RE-INSTALL EXIST. SPEAKERS INTO NEW CEILING SYSTEM. COORDINATE WITH
- 7. INSTALL NEW LIGHT FIXTURES INTO NEW CEILING SYSTEM. REFER TO ELECTRICAL DRAWINGS.
- 8. CEILING MOUNTED PROJECTOR PROVIDED BY OWNER, INSTALLED BY CONTRACTOR. PROVIDE BLOCKING/BRACING AS REQ'D BY CONDITIONS. F.V. EXACT LOCATION WITH OWNER.
- 9. INSTALL NEW 5/8" GYPSUM BOARD OVER NEW 3 5/8" METAL STUD FRAMING.
- 10. INSTALL NEW 2x2 CEILING GRID AND ACOUSTIC CEILING TILES. ALIGN WITH EXISTING ADJACENT CEILING GRID.
- II. INSTALL NEW 2X4 LIGHT FIXTURES. REFER TO ELECTRICAL DRAWINGS. 12. INSTALL NEW HVAC DIFFUSERS. REFER TO MECHANICAL DRAWINGS.
- 13. INSTALL NEW LIGHT FIXTURES. REFER TO ELECTRICAL DRAWINGS.
- 14. CUTBACK/EXTEND/MODIFY EXISTING ATC THIS AREA, INSTALL NEW WALL MOLD # CEILING PADS AS REQ'D.
- 15. INSTALL NEW EXHAUST FAN. REFER TO MECHANICAL DRAWINGS.
- 16. RETURN AIR SLOT. REFER TO MECHANICAL DRAWINGS.

DRAWINGS.


- 17. EXISTING PLASTER/GYP. BD. CEILING TO REMAIN. PREP & PAINT [P-5]. 18. EXISTING LIGHTING TO REMAIN. CLEAN AND RE-LAMP. REFER TO ELECTRICAL
- 19. EXISTING HVAC DIFFUSERS TO REMAIN. REFER TO MECHANICAL DRAWINGS. 20. EXISTING CEILING TO REMAIN THIS ROOM. NO WORK.
- 21. EXISTING 2X2 CEILING GRID AND CEILING TILES TO REMAIN. CLEAN AND REPLACE ANY STAINED/DAMAGED CEILING AS REQ'D. INSTALL NEW LIGHT
- FIXTURES WHERE INDICATED. COORDINATE WITH PME DRAWINGS. 22. INSTALL NEW MOTORIZED WINDOW SHADES. REFER TO SPECIFICATION \$
- ELECTRICAL DRAWINGS. 23. INSTALL MOTORIZED DROP DOWN PROJECTOR SCREEN. REFER TO
- SPECIFICATIONS & ELECTRICAL DRAWINGS. 24. DESIGN INTENT IS FOR NEW CEILING TO BE INSTALLED AS HIGH AS POSSIBLE THIS ROOM. COORDINATE WITH OWNER & ARCHITECT AFTER DEMOLITION TO DETERMINE EXACT CEILING HEIGHT.
- 25. PROVIDE & INSTALL 16"x16" MIN. ACCESS PANELS PAINTED TO MATCH CEILING. FIELD COORDINATE EXACT LOCATION.
- 26. INSTALL NEW FIRE ALARM DEVICES IN NEW CEILING SYSTEM THIS ROOM. REFER TO ELECTRICAL DRAWINGS.
- 27. NEW SPEAKERS, CAMERAS, ACCESS POINTS, ETC. IN THIS ROOM WILL BE PROVIDED AND INSTALLED BY OWNER. FIELD COORDINATE LOCATIONS.

NOTE: RE-WIRE EXISTING LIGHT FIXTURES AS REQUIRED TO ACCOMMODATE SWITCHING FOR "NEW" FRONT OF CLASSROOM -

F.V. CONDITIONS, REFER TO ELECTRICAL DRAWINGS.



THE DESIGN INTENT IS FOR THIS SHEET SHALL BE USED AS A TEMPLATE FOR MARKER BOARD, TACK BOARD, AND TACK STRIP IDENTIFICATION, LOCATION, AND QUANTITY FOR THE FOLLOWING CLASSROOMS: 109, 110, | 112, 115, 116, 118, \$119. ACTUAL CLASSROOM ORIENTATION AND CONFIGURATION MAY VARY

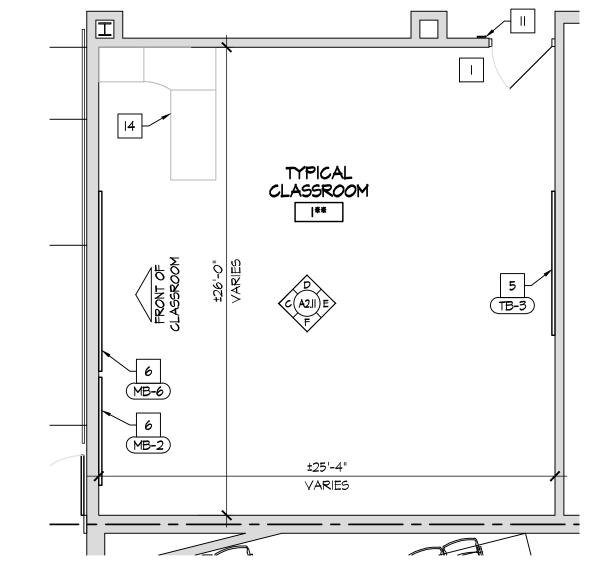

REFLECTED CEILING PLAN -TYPICAL CLASSROOM SCALE: 3/16" = 1'-0"

- OR LOCATE AS DIRECTED BY OWNER



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TB-3

OR LOCATE AS DIRECTED BY OWNER

TYPICAL CLASSROOM

SCALE: 3/8" = 1'-0"



(TS-I) 8 L.F.

3

* NEW CONSTRUCTION KEY NOTES

- EXISTING SOLID CORE WOOD DOOR AND HOLLOW METAL FRAME TO REMAIN. REPAIR & RE-FINISH EX. WOOD DOOR SLAB AND INSTALL NEW HARDWARE AS SPECIFIED. REFER TO DOOR SCHEDULE AND SPECIFICATIONS.
- 2. INSTALL NEW DOOR AND FRAME IN NEW OPENING. REFER TO DOOR SCHEDULE.
- 3. INSTALL NEW DOOR AND FRAME IN EXISTING OPENING. REFER TO DOOR
- 4. INSTALL NEW WINDOW IN NEW OPENING. REFER TO WINDOW SCHEDULE.
- 5. INSTALL NEW TACKBOARD. SEE SCHEDULE.
- 6. INSTALL NEW MAGNETIC MARKER BOARD. SEE SCHEDULE.
- 7. INFILL EXISTING OPENING W/ CMU, TOOTH INTO EXISTING, MATCH EX. EACH SIDE. 8. NO WORK THIS AREA.
- 9. INSTALL NEW HIGH-LOW DRINKING FOUNTAIN WITH BOTTLE FILLER. REFER TO PLUMBING DRAWINGS.
- IO. INSTALL NEW LOW DRINKING FOUNTAIN WITH BOTTLE FILLER. REFER TO
- PLUMBING DRAWINGS. II. INSTALL NEW ROOM SIGNAGE PROVIDED AND INSTALLED BY OWNER.
- 12. INSTALL NEW PARTITION WALL, REFER TO WALL TYPES.
- 13. NEW CASEMORK SEE INTERIOR ELEVATIONS
- 14. FURNITURE & EQUIPMENT PROVIDED BY AND INSTALLED BY OWNER G.C TO PROVIDE ALL REQUIRED UTILITY CONNECTIONS. REFER TO PME DRAWINGS
- 15. NEW LOCKERS & BLOCKING BY OWNER, SET ON NEW/EXISTING LOCKER BASES. REFER TO INTERIOR ELEVATIONS.
- 16. INSTALL NEW STOREFRONT SYSTEM AND DOOR. REFER TO WINDOW & DOOR
- 17. WALL MOUNTED TY/DISPLAY BY OWNER INSTALLED BY CONTRACTOR,
- PROVIDE POWER/DATA REFER TO ELECTRICAL DRAWINGS. 18. EXISTING DOOR AND HOLLOW METAL FRAME TO REMAIN. METAL DOORS: REPAIR, PREP. PAINT DOOR & FRAME AND INSTALL NEW HARDWARE AS SPECIFIED; WOOD DOORS: REPAIR, PREP, PAINT FRAME & INSTALL NEW
- 19. PREP AND PAINT EXISTING WALLS IN CONTROL ROOM [P-6]. REMOVE EXISTING FLOORING AND INSTALL NEW CARPET [F-6].

HARDWARE AS SPECIFIED. REFER TO DOOR SCHEDULE AND SPECIFICATIONS.

- 20. INSTALL WALL COVERING [WC-I] ON EX. GYP. BD. WALL TO 36" A.F.F.
- 21. INSTALL WALL COVERING [WC-I] FULL HEIGHT TO UNDERSIDE OF CEILING AT EMERGENCY SHOWER. INSTALL STAINLESS STEEL WALL CAP FULL HEIGHT.
- 22. NEW LOCKERS & BLOCKING BY OWNER, EXISTING LOCKER BASES TO REMAIN.
- 23. EXISTING ELECTRICAL PANEL. REFER TO ELECTRICAL DRAWINGS.
- 24. EXISTING FIRE EXTINGUISHER CABINET TO REMAIN. PROTECT DURING CONSTRUCTION.
- 25. REPAIR EXISTING WALL AS REQ'D.
- 26. EXISTING CASEWORK & EQUIPMENT TO REMAIN. PROTECT DURING CONSTRUCTION.
- 27. INSTALL 18" DIA. PRE-MANUFACTURED METAL COLUMN COVER. SEE SPECIFICATIONS. REFER TO B/A2.41.

REFER TO DIMENSIONED FLOOR PLAN SHEET AI.12. REFER TO SHEET GI.4 FOR WALL TYPES.

INTERIOR ELEVATION KEY NOTES

- EXISTING MASONRY WALLS. REPAIR, PREP, AND PAINT.
- NEW MASONRY WALLS. PREP & PAINT. WALL BASE, AS SCHEDULED. REFER TO ROOM FINISH SCHEDULE.
- TV/EQUIPMENT/APPLIANCES PROVIDED BY AND INSTALLED BY OWNER G.C TO PROVIDE ALL REQUIRED UTILITY CONNECTIONS. REFER TO PME DRAWINGS.
- DOOR. REFER TO DOOR SCHEDULE.
- 6. LINE OF WALL TRANSITION.
- 7. NEW PRE-FINISHED METAL SCIENCE WALL & BASE CABINETS / CASEWORK / COUNTERTOPS / EQUIPMENT - G.C TO PROVIDE ALL REQUIRED UTILITY CONNECTIONS. REFER TO PME DRAWINGS.
- 8. NEW FURNITURE/MILLWORK PROVIDED BY AND INSTALLED BY OWNER G.C TO PROVIDE ALL REQUIRED UTILITY CONNECTIONS. REFER TO PME DRAWINGS 9. EXISTING WINDOW TO REMAIN.
- IO. NEW WINDOW IN NEW OPENING. REFER TO PLAN. REFER TO WINDOW
- SCHEDULE. II. EXISTING COLUMN TO REMAIN. PREP & PAINT.
- 12. EXISTING ELECTRICAL PANEL. REPE & PAINT [P-I] TYP. REFER TO ELECTRICAL DRAWINGS.
- 13. METAL STUD GYP. BD. WALL. PREP & PAINT.
- 14. NEW TACK BOARD. REFER TO PLAN. SEE SCHEDULE.
- 15. NEW MAGNETIC MARKER BOARD. REFER TO PLAN. SEE SCHEDULE. 16. WALL MOUNTED PROJECTOR. PROVIDED & INSTALLED BY OWNER - EXTEND POWER AND DATA TO PROJECTOR LOCATION - REFER TO ELECTRICAL
- 17. MARKER BOARDS AT PROJECTOR LOCATIONS MUST BE INSTALLED PER MANUFACTURER REQUIREMENTS TO MAINTAIN REQUIRED FLATNESS FOR INTERACTIVE PROJECTION.
- 18. NO MARKER TRAY AT PROJECTOR LOCATIONS
- 19. CONTRACTOR SHALL INSTALL OWNER PROVIDED TACK STRIP. TACK STRIP MOUNTED AT HEIGHTS INDICATED ON INTERIOR ELEVATIONS. COORDINATE FINAL LOCATIONS W/ OWNER PRIOR TO INSTALLATION.
- 20. NEW ROOM SIGNAGE PROVIDED AND INSTALLED BY OWNER. 21. NEW PLASTIC LAMINATE WALL AND BASE CABINETS. COORDINATE WITH
- OWNER FOR FINISH SELECTION.
- 22. NEW PLASTIC LAMINATE COUNTERTOP AND BACKSPLASH. COORDINATE WITH OWNER FOR FINISH SELECTION.
- 23. PLASTIC LAMINATE FILLER TO MATCH CABINETS.
- 24. STAINLESS STEEL SINK AND FAUCET. REFER TO PLUMBING DRAWINGS. 25. STAINLESS STEEL PULLS.
- 26. FINISHED PLASTIC LAMINATE END PANEL.
- 27. PLASTIC LAMINATE ENDSPLASH. 28. INSTALL RUBBER BASE AT TOE KICK.
- 29. EXISTING COLUMN TO REMAIN. INSTALL 18" DIA. PRE-MANUFACTURED METAL COLUMN COVER. SEE SPECIFICATIONS.
- 30. NEW GYPSUM BOARD BULKHEAD. REFER TO REFLECTED CEILING PLAN.
- 31. EXISTING FIRE EXTINGUISHER CABINET TO REMAIN. PREP & PAINT [P-I] TYP.
- 32. NEW DRINKING FOUNTAIN. REFER TO PME DRAWING.
- 33. NEW ANODIZED ALUMINUM WALL MOUNTED HANDRAIL. 34. LOCKERS BY OWNER
- 35. PREP AND PAINT ENTIRE EXISTING RAIL SYSTEM, TYP.

O ACCESSORY SCHEDULE

\sim					
	MARK	DESCRIPTION	MODEL		
	Α	SOAP DISPENSER	PROVIDE BY OWNER / INST. BY CON		
	В	PAPER TOWEL DISPENSER	PROVIDE BY OWNER / INST. BY CON		

• ALL SHALL BE STAINLESS STEEL FINISH.

FIELD COORDINATE ALL ACCESSORY LOCATIONS, CONFORM TO ALL ACCESSIBILITY INSTALLATION REQUIREMENTS.

• PROVIDE AND INSTALL FRT BLOCKING AS REQUIRED FOR ALL ACCESSORIES.

GENERAL INTERIOR NOTES

REPAIR EX. CMU AS REQ'D AT EXISTING WALLS.

- NOMINAL CABINET SIZES INDICATED. VERIFY & PROVIDE ALL REQUIRED FILLERS, ETC. FOR CASEWORK TO ALLOW PROPER OPERATION OF DOORS \$
- 3 OF TO PROVIDE AND INSTALL ALL FREE BLOCKING AS RECHIRED FOR ALL

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GROUP

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JONATHAN

ROBERT

SCHAAF

14503

Jonathan Robert Schaaf #14503

Expiration Date 12/31/2023

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Woods Drive

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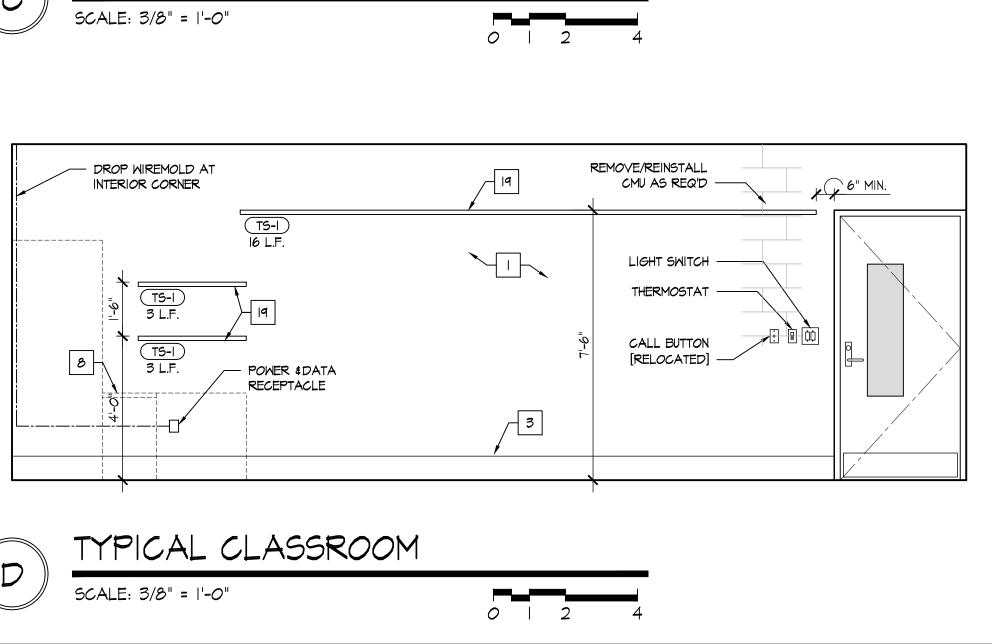
Date January 24, 2022

Sheet Title

ENLARGED TYPICAL CLASSROOM PLANS

Sheet Number


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POWER & DATA AT CEILING

TYPICAL CLASSROOM


MB-6






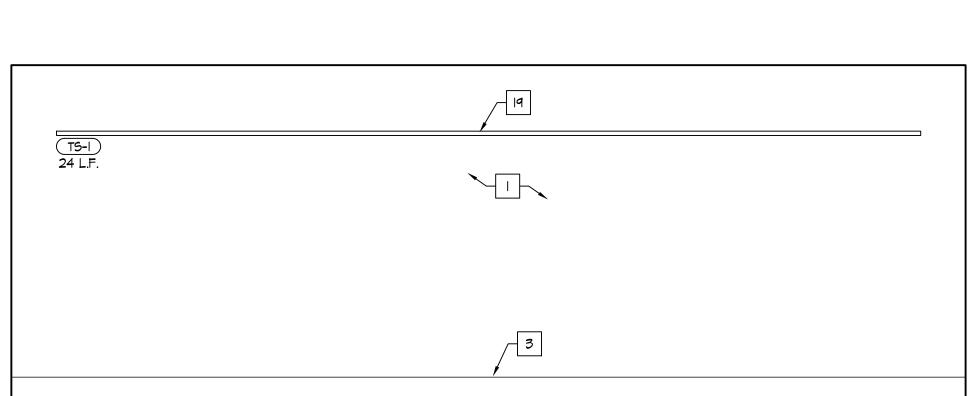



TYPICAL CLASSROOM

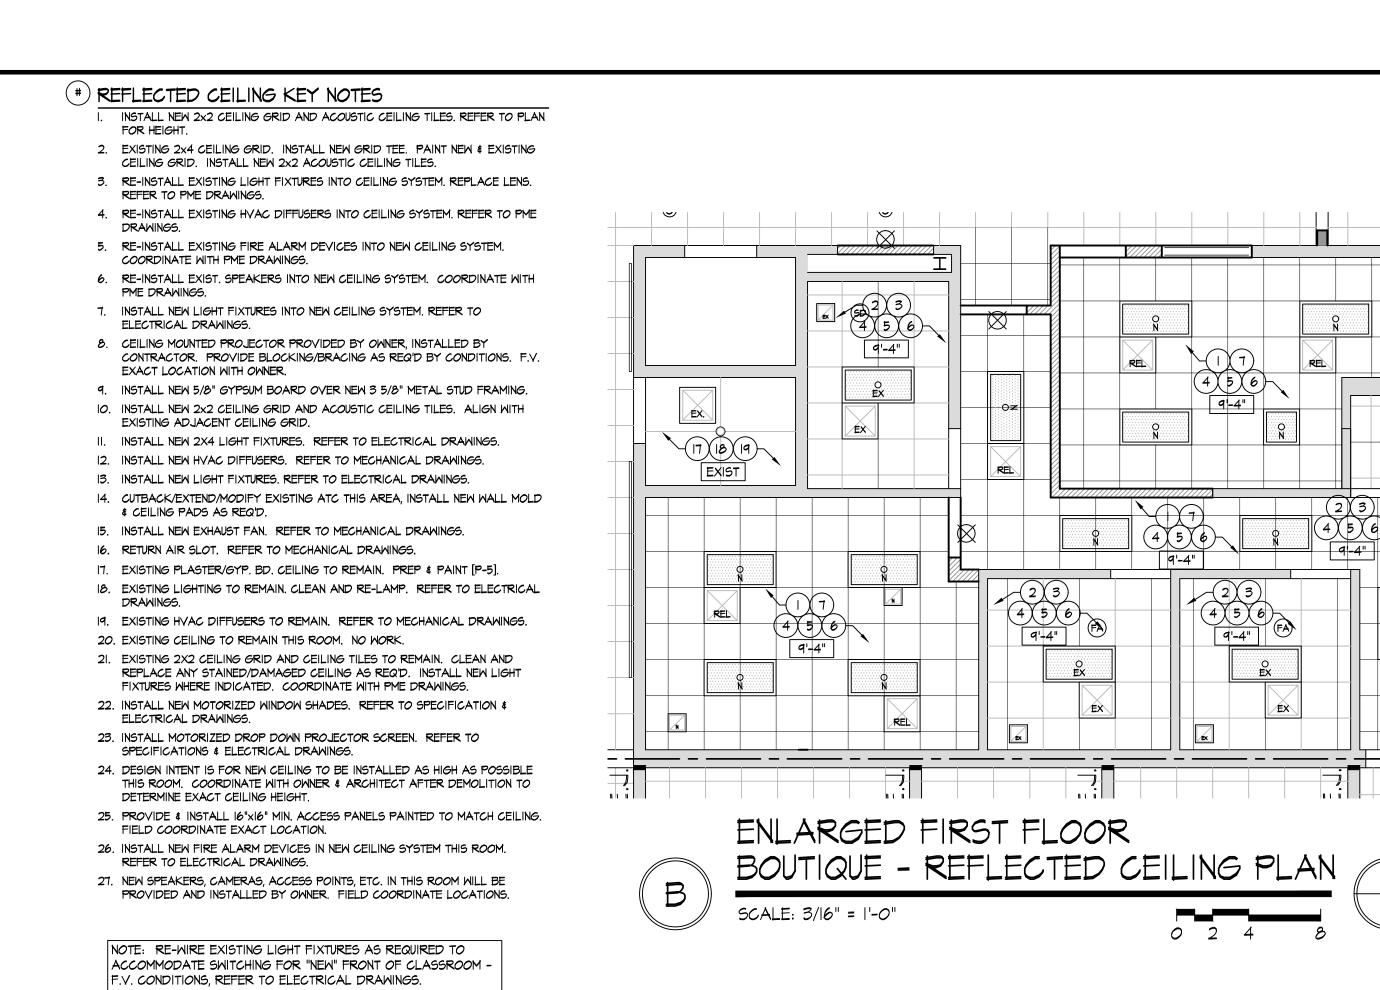

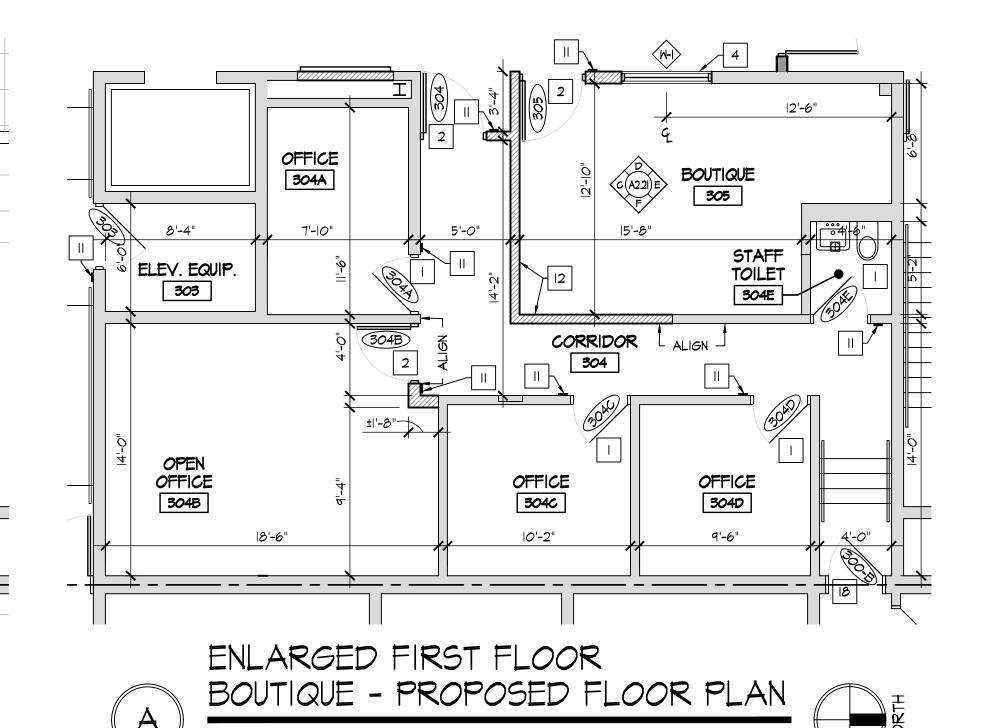

SCALE: 3/16" = 1'-0"

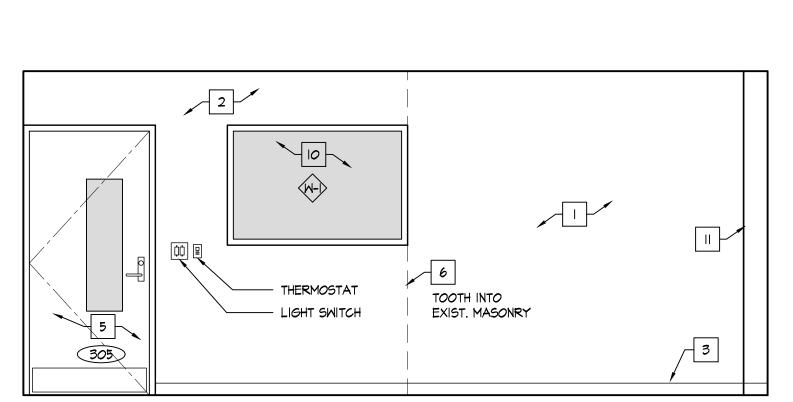

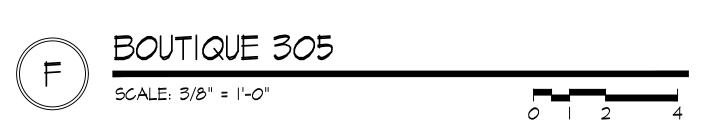



- EXISTING SOLID CORE WOOD DOOR AND HOLLOW METAL FRAME TO REMAIN. REPAIR & RE-FINISH EX. WOOD DOOR SLAB AND INSTALL NEW HARDWARE AS SPECIFIED. REFER TO DOOR SCHEDULE AND SPECIFICATIONS.
- 2. INSTALL NEW DOOR AND FRAME IN NEW OPENING. REFER TO DOOR SCHEDULE. 3. INSTALL NEW DOOR AND FRAME IN EXISTING OPENING. REFER TO DOOR
- 4. INSTALL NEW WINDOW IN NEW OPENING. REFER TO WINDOW SCHEDULE.
- 5. INSTALL NEW TACKBOARD. SEE SCHEDULE.
- 6. INSTALL NEW MAGNETIC MARKER BOARD. SEE SCHEDULE.
- 7. INFILL EXISTING OPENING W/ CMU, TOOTH INTO EXISTING, MATCH EX. EACH SIDE.
- 8. NO WORK THIS AREA. 9. INSTALL NEW HIGH-LOW DRINKING FOUNTAIN WITH BOTTLE FILLER. REFER TO
- PLUMBING DRAWINGS. 10. INSTALL NEW LOW DRINKING FOUNTAIN WITH BOTTLE FILLER. REFER TO
- PLUMBING DRAWINGS.
- II. INSTALL NEW ROOM SIGNAGE PROVIDED AND INSTALLED BY OWNER.
- 12. INSTALL NEW PARTITION WALL, REFER TO WALL TYPES. 13. NEW CASEMORK - SEE INTERIOR ELEVATIONS
- 14. FURNITURE & EQUIPMENT PROVIDED BY AND INSTALLED BY OWNER G.C TO PROVIDE ALL REQUIRED UTILITY CONNECTIONS. REFER TO PME DRAWINGS
- 15. NEW LOCKERS & BLOCKING BY OWNER, SET ON NEW/EXISTING LOCKER BASES. REFER TO INTERIOR ELEVATIONS.
- 16. INSTALL NEW STOREFRONT SYSTEM AND DOOR. REFER TO WINDOW & DOOR
- 17. WALL MOUNTED TY/DISPLAY BY OWNER INSTALLED BY CONTRACTOR,
- PROVIDE POWER/DATA REFER TO ELECTRICAL DRAWINGS. 18. EXISTING DOOR AND HOLLOW METAL FRAME TO REMAIN. METAL DOORS: REPAIR, PREP, PAINT DOOR & FRAME AND INSTALL NEW HARDWARE AS SPECIFIED; WOOD DOORS: REPAIR, PREP, PAINT FRAME & INSTALL NEW
- 19. PREP AND PAINT EXISTING WALLS IN CONTROL ROOM [P-6]. REMOVE EXISTING FLOORING AND INSTALL NEW CARPET [F-6].

HARDWARE AS SPECIFIED. REFER TO DOOR SCHEDULE AND SPECIFICATIONS.

- 20. INSTALL WALL COVERING [WC-I] ON EX. GYP. BD. WALL TO 36" A.F.F.
- 21. INSTALL WALL COVERING [WC-I] FULL HEIGHT TO UNDERSIDE OF CEILING AT EMERGENCY SHOWER. INSTALL STAINLESS STEEL WALL CAP FULL HEIGHT.
- 22. NEW LOCKERS & BLOCKING BY OWNER, EXISTING LOCKER BASES TO REMAIN.
- 23. EXISTING ELECTRICAL PANEL. REFER TO ELECTRICAL DRAWINGS.
- 24. EXISTING FIRE EXTINGUISHER CABINET TO REMAIN. PROTECT DURING CONSTRUCTION.
- 25. REPAIR EXISTING WALL AS REQ'D.
- 26. EXISTING CASEWORK & EQUIPMENT TO REMAIN. PROTECT DURING CONSTRUCTION.
- 27. INSTALL 18" DIA. PRE-MANUFACTURED METAL COLUMN COVER. SEE SPECIFICATIONS. REFER TO B/A2.41.

REFER TO DIMENSIONED FLOOR PLAN SHEET Al.12. REFER TO SHEET GI.4 FOR WALL TYPES.



- EXISTING MASONRY WALLS. REPAIR, PREP, AND PAINT.
- NEW MASONRY WALLS. PREP & PAINT.
- WALL BASE, AS SCHEDULED. REFER TO ROOM FINISH SCHEDULE. 4. TV/EQUIPMENT/APPLIANCES PROVIDED BY AND INSTALLED BY OWNER - G.C TO PROVIDE ALL REQUIRED UTILITY CONNECTIONS. REFER TO PME
- DRAWINGS. 5. DOOR. REFER TO DOOR SCHEDULE.
- 6. LINE OF WALL TRANSITION.
- 7. NEW PRE-FINISHED METAL SCIENCE WALL & BASE CABINETS / CASEWORK / COUNTERTOPS / EQUIPMENT - G.C TO PROVIDE ALL REQUIRED UTILITY CONNECTIONS. REFER TO PME DRAWINGS.
- 8. NEW FURNITURE/MILLWORK PROVIDED BY AND INSTALLED BY OWNER G.C TO PROVIDE ALL REQUIRED UTILITY CONNECTIONS. REFER TO PME DRAWINGS
- 9. EXISTING WINDOW TO REMAIN. IO. NEW WINDOW IN NEW OPENING. REFER TO PLAN. REFER TO WINDOW
- II. EXISTING COLUMN TO REMAIN. PREP & PAINT.
- 12. EXISTING ELECTRICAL PANEL. REPE & PAINT [P-I] TYP. REFER TO
- ELECTRICAL DRAWINGS. I3. METAL STUD GYP. BD. WALL. PREP & PAINT.
- 14. NEW TACK BOARD. REFER TO PLAN. SEE SCHEDULE. 15. NEW MAGNETIC MARKER BOARD. REFER TO PLAN. SEE SCHEDULE.
- 16. WALL MOUNTED PROJECTOR. PROVIDED & INSTALLED BY OWNER EXTEND POWER AND DATA TO PROJECTOR LOCATION - REFER TO ELECTRICAL
- 17. MARKER BOARDS AT PROJECTOR LOCATIONS MUST BE INSTALLED PER MANUFACTURER REQUIREMENTS TO MAINTAIN REQUIRED FLATNESS FOR
- INTERACTIVE PROJECTION. 18. NO MARKER TRAY AT PROJECTOR LOCATIONS.
- 19. CONTRACTOR SHALL INSTALL OWNER PROVIDED TACK STRIP. TACK STRIP MOUNTED AT HEIGHTS INDICATED ON INTERIOR ELEVATIONS. COORDINATE FINAL LOCATIONS W/ OWNER PRIOR TO INSTALLATION.
- 20. NEW ROOM SIGNAGE PROVIDED AND INSTALLED BY OWNER. 21. NEW PLASTIC LAMINATE WALL AND BASE CABINETS. COORDINATE WITH
- OWNER FOR FINISH SELECTION. 22. NEW PLASTIC LAMINATE COUNTERTOP AND BACKSPLASH. COORDINATE WITH
- OWNER FOR FINISH SELECTION.
- 23. PLASTIC LAMINATE FILLER TO MATCH CABINETS. 24. STAINLESS STEEL SINK AND FAUCET. REFER TO PLUMBING DRAWINGS.
- 25. STAINLESS STEEL PULLS.
- 26. FINISHED PLASTIC LAMINATE END PANEL.
- 27. PLASTIC LAMINATE ENDSPLASH. 28. INSTALL RUBBER BASE AT TOE KICK.
- 29. EXISTING COLUMN TO REMAIN. INSTALL 18" DIA. PRE-MANUFACTURED METAL
- COLUMN COVER. SEE SPECIFICATIONS. 30. NEW GYPSUM BOARD BULKHEAD. REFER TO REFLECTED CEILING PLAN.
- 31. EXISTING FIRE EXTINGUISHER CABINET TO REMAIN. PREP & PAINT [P-1] TYP.
- 32. NEW DRINKING FOUNTAIN. REFER TO PME DRAWING.
- 33. NEW ANODIZED ALUMINUM WALL MOUNTED HANDRAIL. 34. LOCKERS BY OWNER
- 35. PREP AND PAINT ENTIRE EXISTING RAIL SYSTEM, TYP.

○ ACCESSORY SCHEDULE MARK DESCRIPTION

- SOAP DISPENSER PROVIDE BY OWNER / INST. BY CONT. PAPER TOWEL DISPENSER PROVIDE BY OWNER / INST. BY CONT.
- ALL SHALL BE STAINLESS STEEL FINISH.
- FIELD COORDINATE ALL ACCESSORY LOCATIONS, CONFORM TO ALL ACCESSIBILITY INSTALLATION REQUIREMENTS.
- PROVIDE AND INSTALL FRT BLOCKING AS REQUIRED FOR ALL ACCESSORIES.

GENERAL INTERIOR NOTES

REPAIR EX. CMU AS REQ'D AT EXISTING WALLS.

NOMINAL CABINET SIZES INDICATED. VERIFY & PROVIDE ALL REQUIRED FILLERS, ETC. FOR CASEWORK TO ALLOW PROPER OPERATION OF DOORS & DRAWERS TYPICAL

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Expiration Date 12/31/2023

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CONSTRUCTION

Project Number

2021-203


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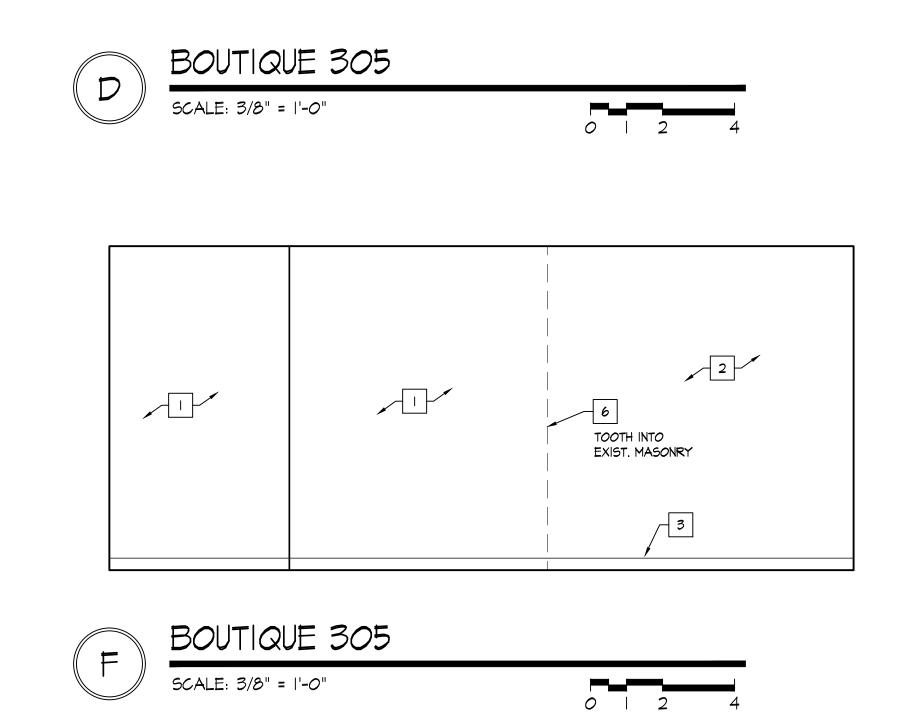
January 24, 2022


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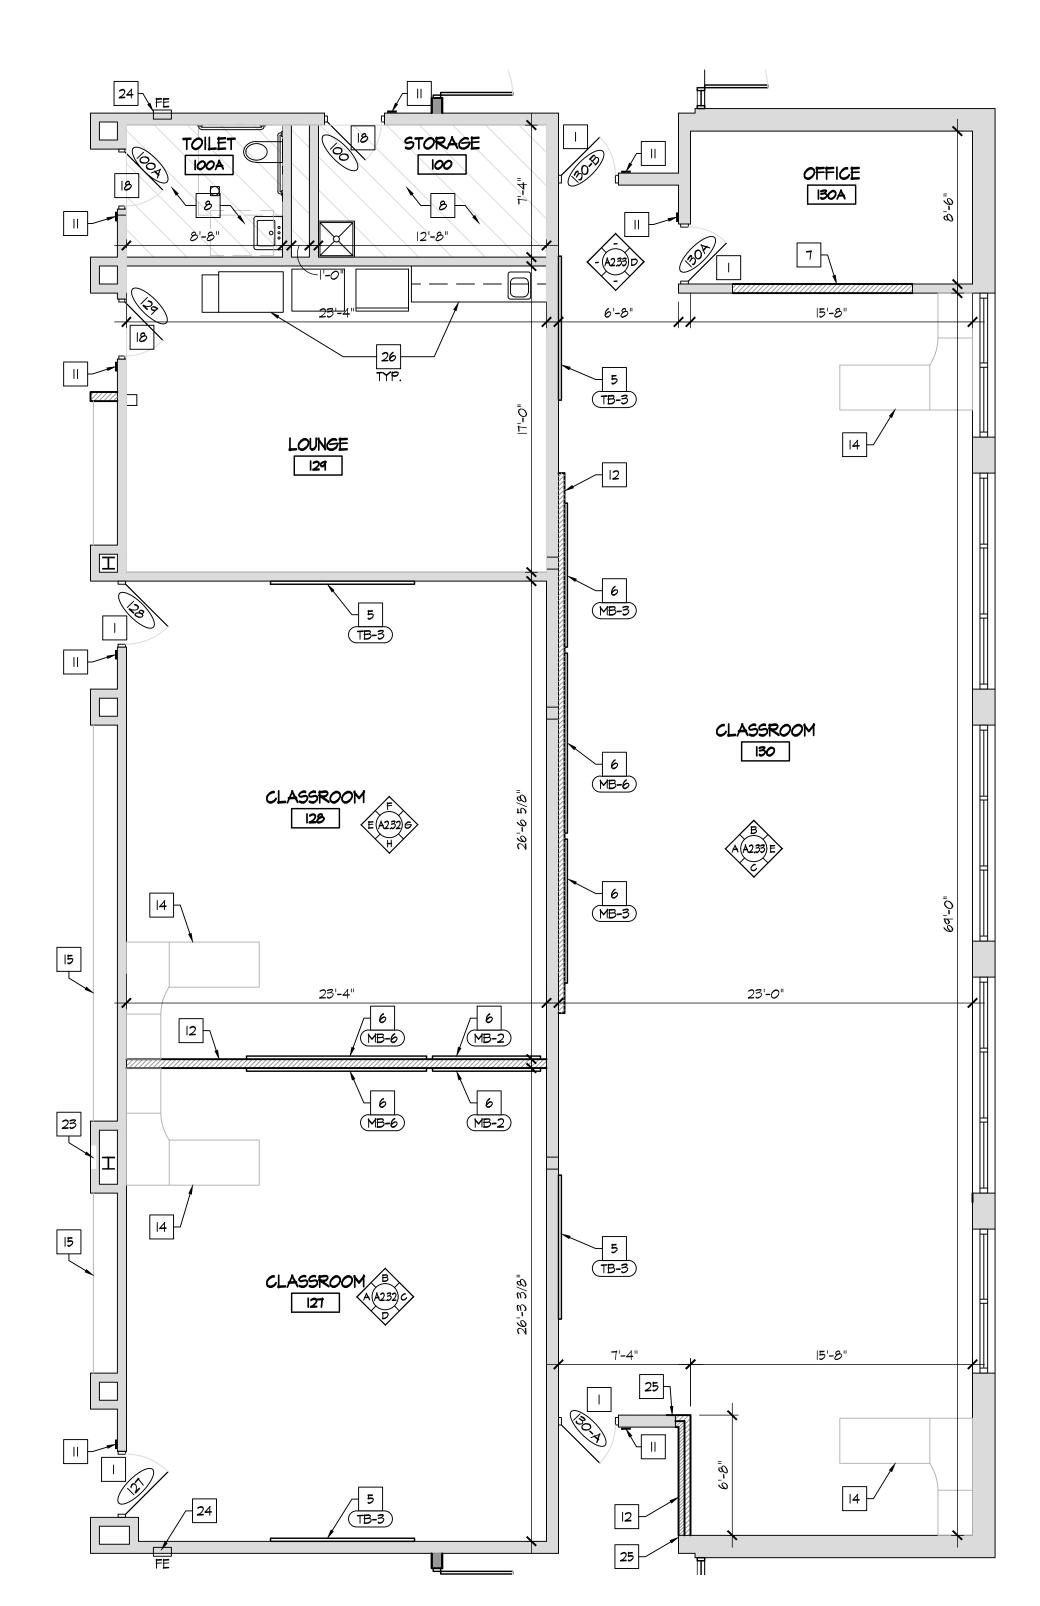
ENLARGED FIRST FLOOR BOUTIQUE PLANS

Sheet Number





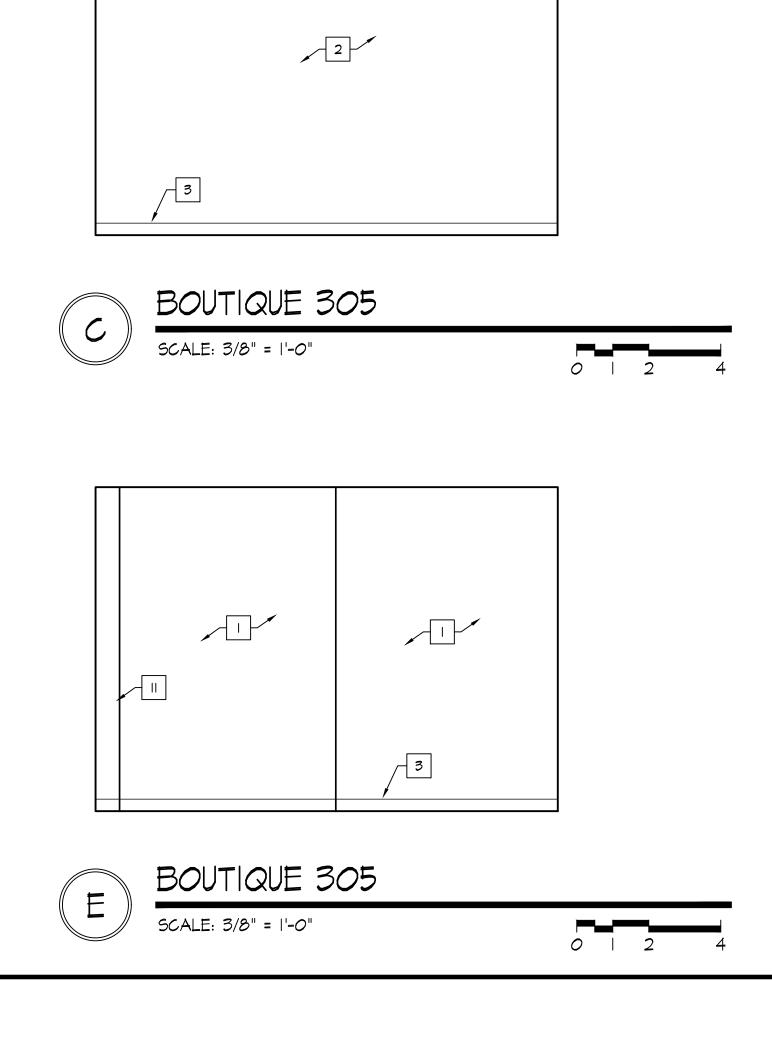

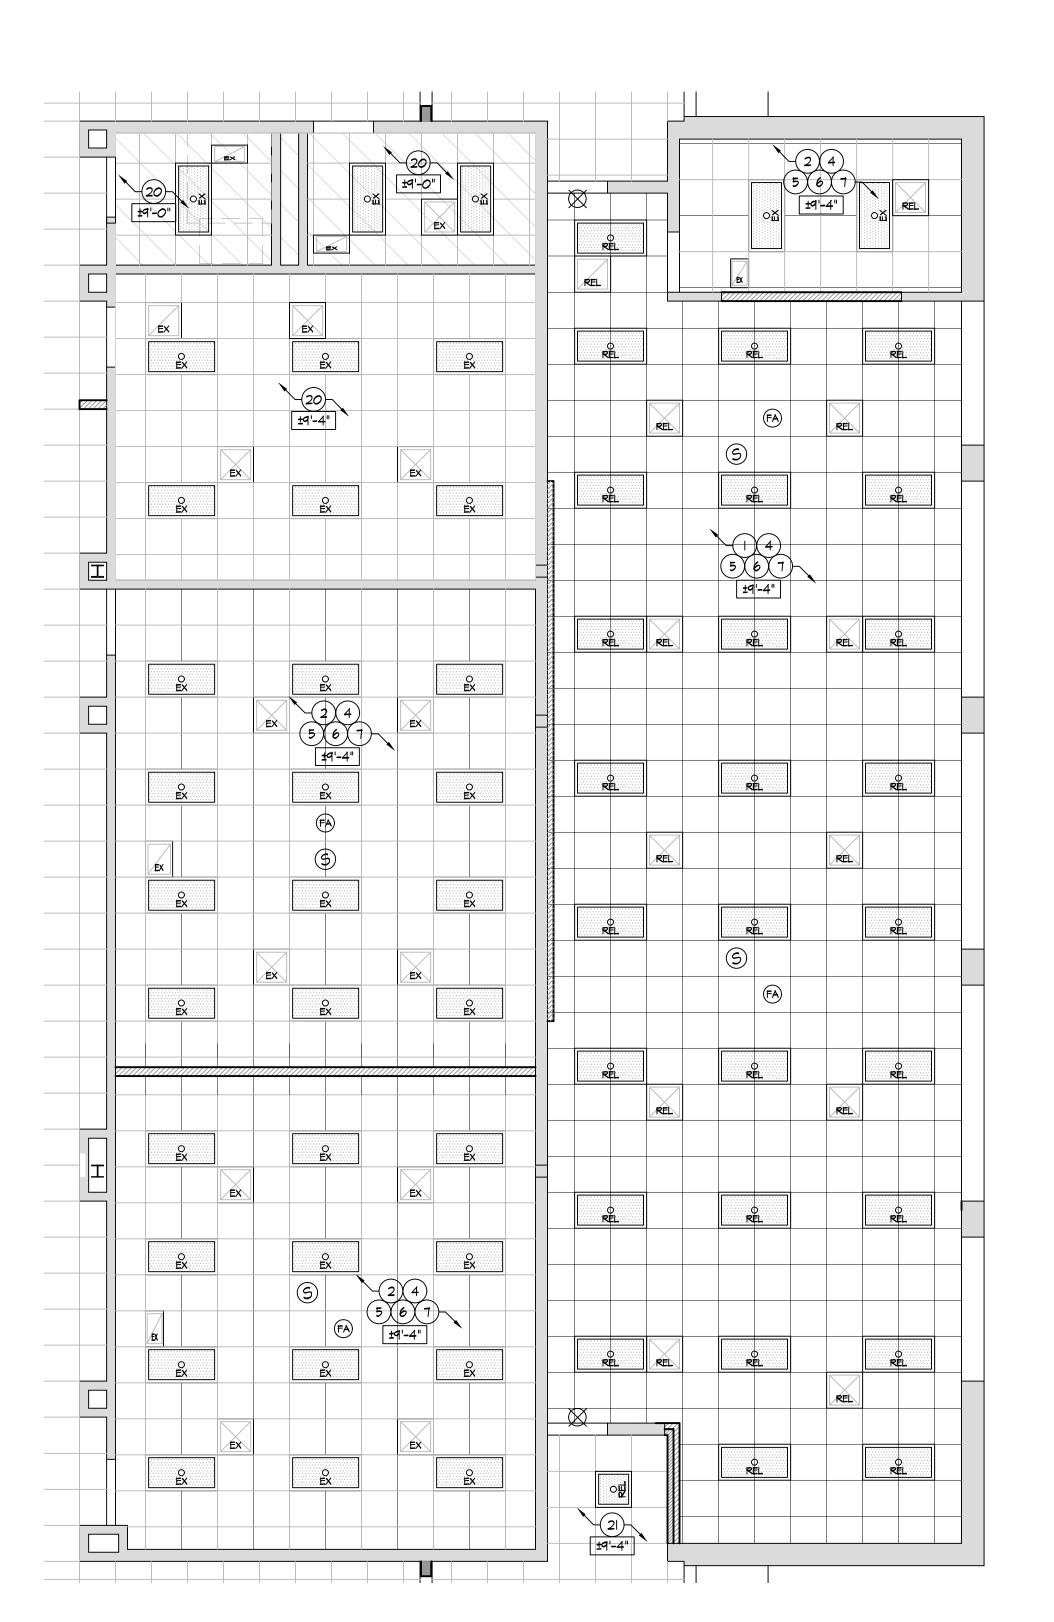

CLASSROOMS 127, 128, \$ 130 ENLARGED PROPOSED FLOOR PLAN

(#) REFLECTED CEILING KEY NOTES INSTALL NEW 2x2 CEILING GRID AND ACOUSTIC CEILING TILES. REFER TO PLAN

- 2. EXISTING 2x4 CEILING GRID. INSTALL NEW GRID TEE. PAINT NEW & EXISTING
- CEILING GRID. INSTALL NEW 2x2 ACOUSTIC CEILING TILES.
- 3. RE-INSTALL EXISTING LIGHT FIXTURES INTO CEILING SYSTEM. REPLACE LENS. REFER TO PME DRAWINGS.
- 4. RE-INSTALL EXISTING HVAC DIFFUSERS INTO CEILING SYSTEM. REFER TO PME
- 5. RE-INSTALL EXISTING FIRE ALARM DEVICES INTO NEW CEILING SYSTEM. COORDINATE WITH PME DRAWINGS.
- 6. RE-INSTALL EXIST. SPEAKERS INTO NEW CEILING SYSTEM. COORDINATE WITH 7. INSTALL NEW LIGHT FIXTURES INTO NEW CEILING SYSTEM. REFER TO
- ELECTRICAL DRAWINGS. 8. CEILING MOUNTED PROJECTOR PROVIDED BY OWNER, INSTALLED BY
- EXACT LOCATION WITH OWNER. 9. INSTALL NEW 5/8" GYPSUM BOARD OVER NEW 3 5/8" METAL STUD FRAMING. IO. INSTALL NEW 2x2 CEILING GRID AND ACOUSTIC CEILING TILES. ALIGN WITH
- EXISTING ADJACENT CEILING GRID.

CONTRACTOR. PROVIDE BLOCKING/BRACING AS REQ'D BY CONDITIONS. F.V.

- II. INSTALL NEW 2X4 LIGHT FIXTURES. REFER TO ELECTRICAL DRAWINGS.
- 12. INSTALL NEW HVAC DIFFUSERS. REFER TO MECHANICAL DRAWINGS. 13. INSTALL NEW LIGHT FIXTURES. REFER TO ELECTRICAL DRAWINGS.
- 14. CUTBACK/EXTEND/MODIFY EXISTING ATC THIS AREA, INSTALL NEW WALL MOLD & CEILING PADS AS REQ'D.
- 15. INSTALL NEW EXHAUST FAN. REFER TO MECHANICAL DRAWINGS.
- 16. RETURN AIR SLOT. REFER TO MECHANICAL DRAWINGS.
- 17. EXISTING PLASTER/GYP. BD. CEILING TO REMAIN. PREP & PAINT [P-5]. 18. EXISTING LIGHTING TO REMAIN. CLEAN AND RE-LAMP. REFER TO ELECTRICAL DRAWINGS.
- 19. EXISTING HVAC DIFFUSERS TO REMAIN. REFER TO MECHANICAL DRAWINGS. 20. EXISTING CEILING TO REMAIN THIS ROOM. NO WORK.
- 21. EXISTING 2X2 CEILING GRID AND CEILING TILES TO REMAIN. CLEAN AND REPLACE ANY STAINED/DAMAGED CEILING AS REQ'D. INSTALL NEW LIGHT FIXTURES WHERE INDICATED. COORDINATE WITH PME DRAWINGS.
- 22. INSTALL NEW MOTORIZED WINDOW SHADES. REFER TO SPECIFICATION \$ ELECTRICAL DRAWINGS.
- 23. INSTALL MOTORIZED DROP DOWN PROJECTOR SCREEN. REFER TO SPECIFICATIONS & ELECTRICAL DRAWINGS.
- 24. DESIGN INTENT IS FOR NEW CEILING TO BE INSTALLED AS HIGH AS POSSIBLE THIS ROOM. COORDINATE WITH OWNER & ARCHITECT AFTER DEMOLITION TO DETERMINE EXACT CEILING HEIGHT.
- 25. PROVIDE & INSTALL 16"x16" MIN. ACCESS PANELS PAINTED TO MATCH CEILING. FIELD COORDINATE EXACT LOCATION.
- 26. INSTALL NEW FIRE ALARM DEVICES IN NEW CEILING SYSTEM THIS ROOM. REFER TO ELECTRICAL DRAWINGS.
- 27. NEW SPEAKERS, CAMERAS, ACCESS POINTS, ETC. IN THIS ROOM WILL BE PROVIDED AND INSTALLED BY OWNER. FIELD COORDINATE LOCATIONS.

NOTE: RE-WIRE EXISTING LIGHT FIXTURES AS REQUIRED TO ACCOMMODATE SWITCHING FOR "NEW" FRONT OF CLASSROOM -F.V. CONDITIONS, REFER TO ELECTRICAL DRAWINGS.

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Expiration Date 12/31/2023

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NEW CONSTRUCTION KEY NOTES

EXISTING SOLID CORE WOOD DOOR AND HOLLOW METAL FRAME TO REMAIN. REPAIR & RE-FINISH EX. WOOD DOOR SLAB AND INSTALL NEW HARDWARE AS SPECIFIED. REFER TO DOOR SCHEDULE AND SPECIFICATIONS.

- 2. INSTALL NEW DOOR AND FRAME IN NEW OPENING. REFER TO DOOR SCHEDULE. 3. INSTALL NEW DOOR AND FRAME IN EXISTING OPENING. REFER TO DOOR
- 4. INSTALL NEW WINDOW IN NEW OPENING. REFER TO WINDOW SCHEDULE.
- 5. INSTALL NEW TACKBOARD. SEE SCHEDULE.
- 6. INSTALL NEW MAGNETIC MARKER BOARD. SEE SCHEDULE.
- 7. INFILL EXISTING OPENING W CMU, TOOTH INTO EXISTING, MATCH EX. EACH SIDE. 8. NO WORK THIS AREA.
- 9. INSTALL NEW HIGH-LOW DRINKING FOUNTAIN WITH BOTTLE FILLER. REFER TO PLUMBING DRAWINGS.
- 10. INSTALL NEW LOW DRINKING FOUNTAIN WITH BOTTLE FILLER. REFER TO PLUMBING DRAWINGS.
- II. INSTALL NEW ROOM SIGNAGE PROVIDED AND INSTALLED BY OWNER.
- 12. INSTALL NEW PARTITION WALL, REFER TO WALL TYPES. 13. NEW CASEMORK - SEE INTERIOR ELEVATIONS
- 14. FURNITURE & EQUIPMENT PROVIDED BY AND INSTALLED BY OWNER G.C TO
- PROVIDE ALL REQUIRED UTILITY CONNECTIONS. REFER TO PME DRAWINGS 15. NEW LOCKERS & BLOCKING BY OWNER, SET ON NEW/EXISTING LOCKER BASES.
- REFER TO INTERIOR ELEVATIONS.
- 16. INSTALL NEW STOREFRONT SYSTEM AND DOOR. REFER TO WINDOW & DOOR
- 17. WALL MOUNTED TV/DISPLAY BY OWNER INSTALLED BY CONTRACTOR, PROVIDE POWER/DATA - REFER TO ELECTRICAL DRAWINGS.
- 18. EXISTING DOOR AND HOLLOW METAL FRAME TO REMAIN. METAL DOORS: REPAIR, PREP, PAINT DOOR & FRAME AND INSTALL NEW HARDWARE AS SPECIFIED; WOOD DOORS: REPAIR, PREP, PAINT FRAME & INSTALL NEW HARDWARE AS SPECIFIED. REFER TO DOOR SCHEDULE AND SPECIFICATIONS.
- 19. PREP AND PAINT EXISTING WALLS IN CONTROL ROOM [P-6]. REMOVE EXISTING FLOORING AND INSTALL NEW CARPET [F-6].
- 20. INSTALL WALL COVERING [WC-I] ON EX. GYP. BD. WALL TO 36" A.F.F. 21. INSTALL WALL COVERING [WC-I] FULL HEIGHT TO UNDERSIDE OF CEILING AT
- EMERGENCY SHOWER. INSTALL STAINLESS STEEL WALL CAP FULL HEIGHT. 22. NEW LOCKERS & BLOCKING BY OWNER, EXISTING LOCKER BASES TO REMAIN.
- 23. EXISTING ELECTRICAL PANEL. REFER TO ELECTRICAL DRAWINGS. 24. EXISTING FIRE EXTINGUISHER CABINET TO REMAIN. PROTECT DURING CONSTRUCTION.
- 25. REPAIR EXISTING WALL AS REQ'D.
- 26. EXISTING CASEWORK & EQUIPMENT TO REMAIN. PROTECT DURING CONSTRUCTION.
- 27. INSTALL 18" DIA. PRE-MANUFACTURED METAL COLUMN COVER. SEE SPECIFICATIONS. REFER TO B/A2.41.

REFER TO DIMENSIONED FLOOR PLAN SHEET Al. 12. REFER TO SHEET GI.4 FOR WALL TYPES.

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12/07/21 DESIGN REVIEW

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January 24, 2022

Sheet Title

ENLARGED CLASSROOMS 127, 128, \$130 PLANS


Sheet Number

A2.3

CLASSROOMS 127, 128, \$ 130 ENLARGED PROPOSED REFLECTED CEILING PLAN SCALE: 3/16" = 1'-0"



SCALE: 3/16" = 1'-0"

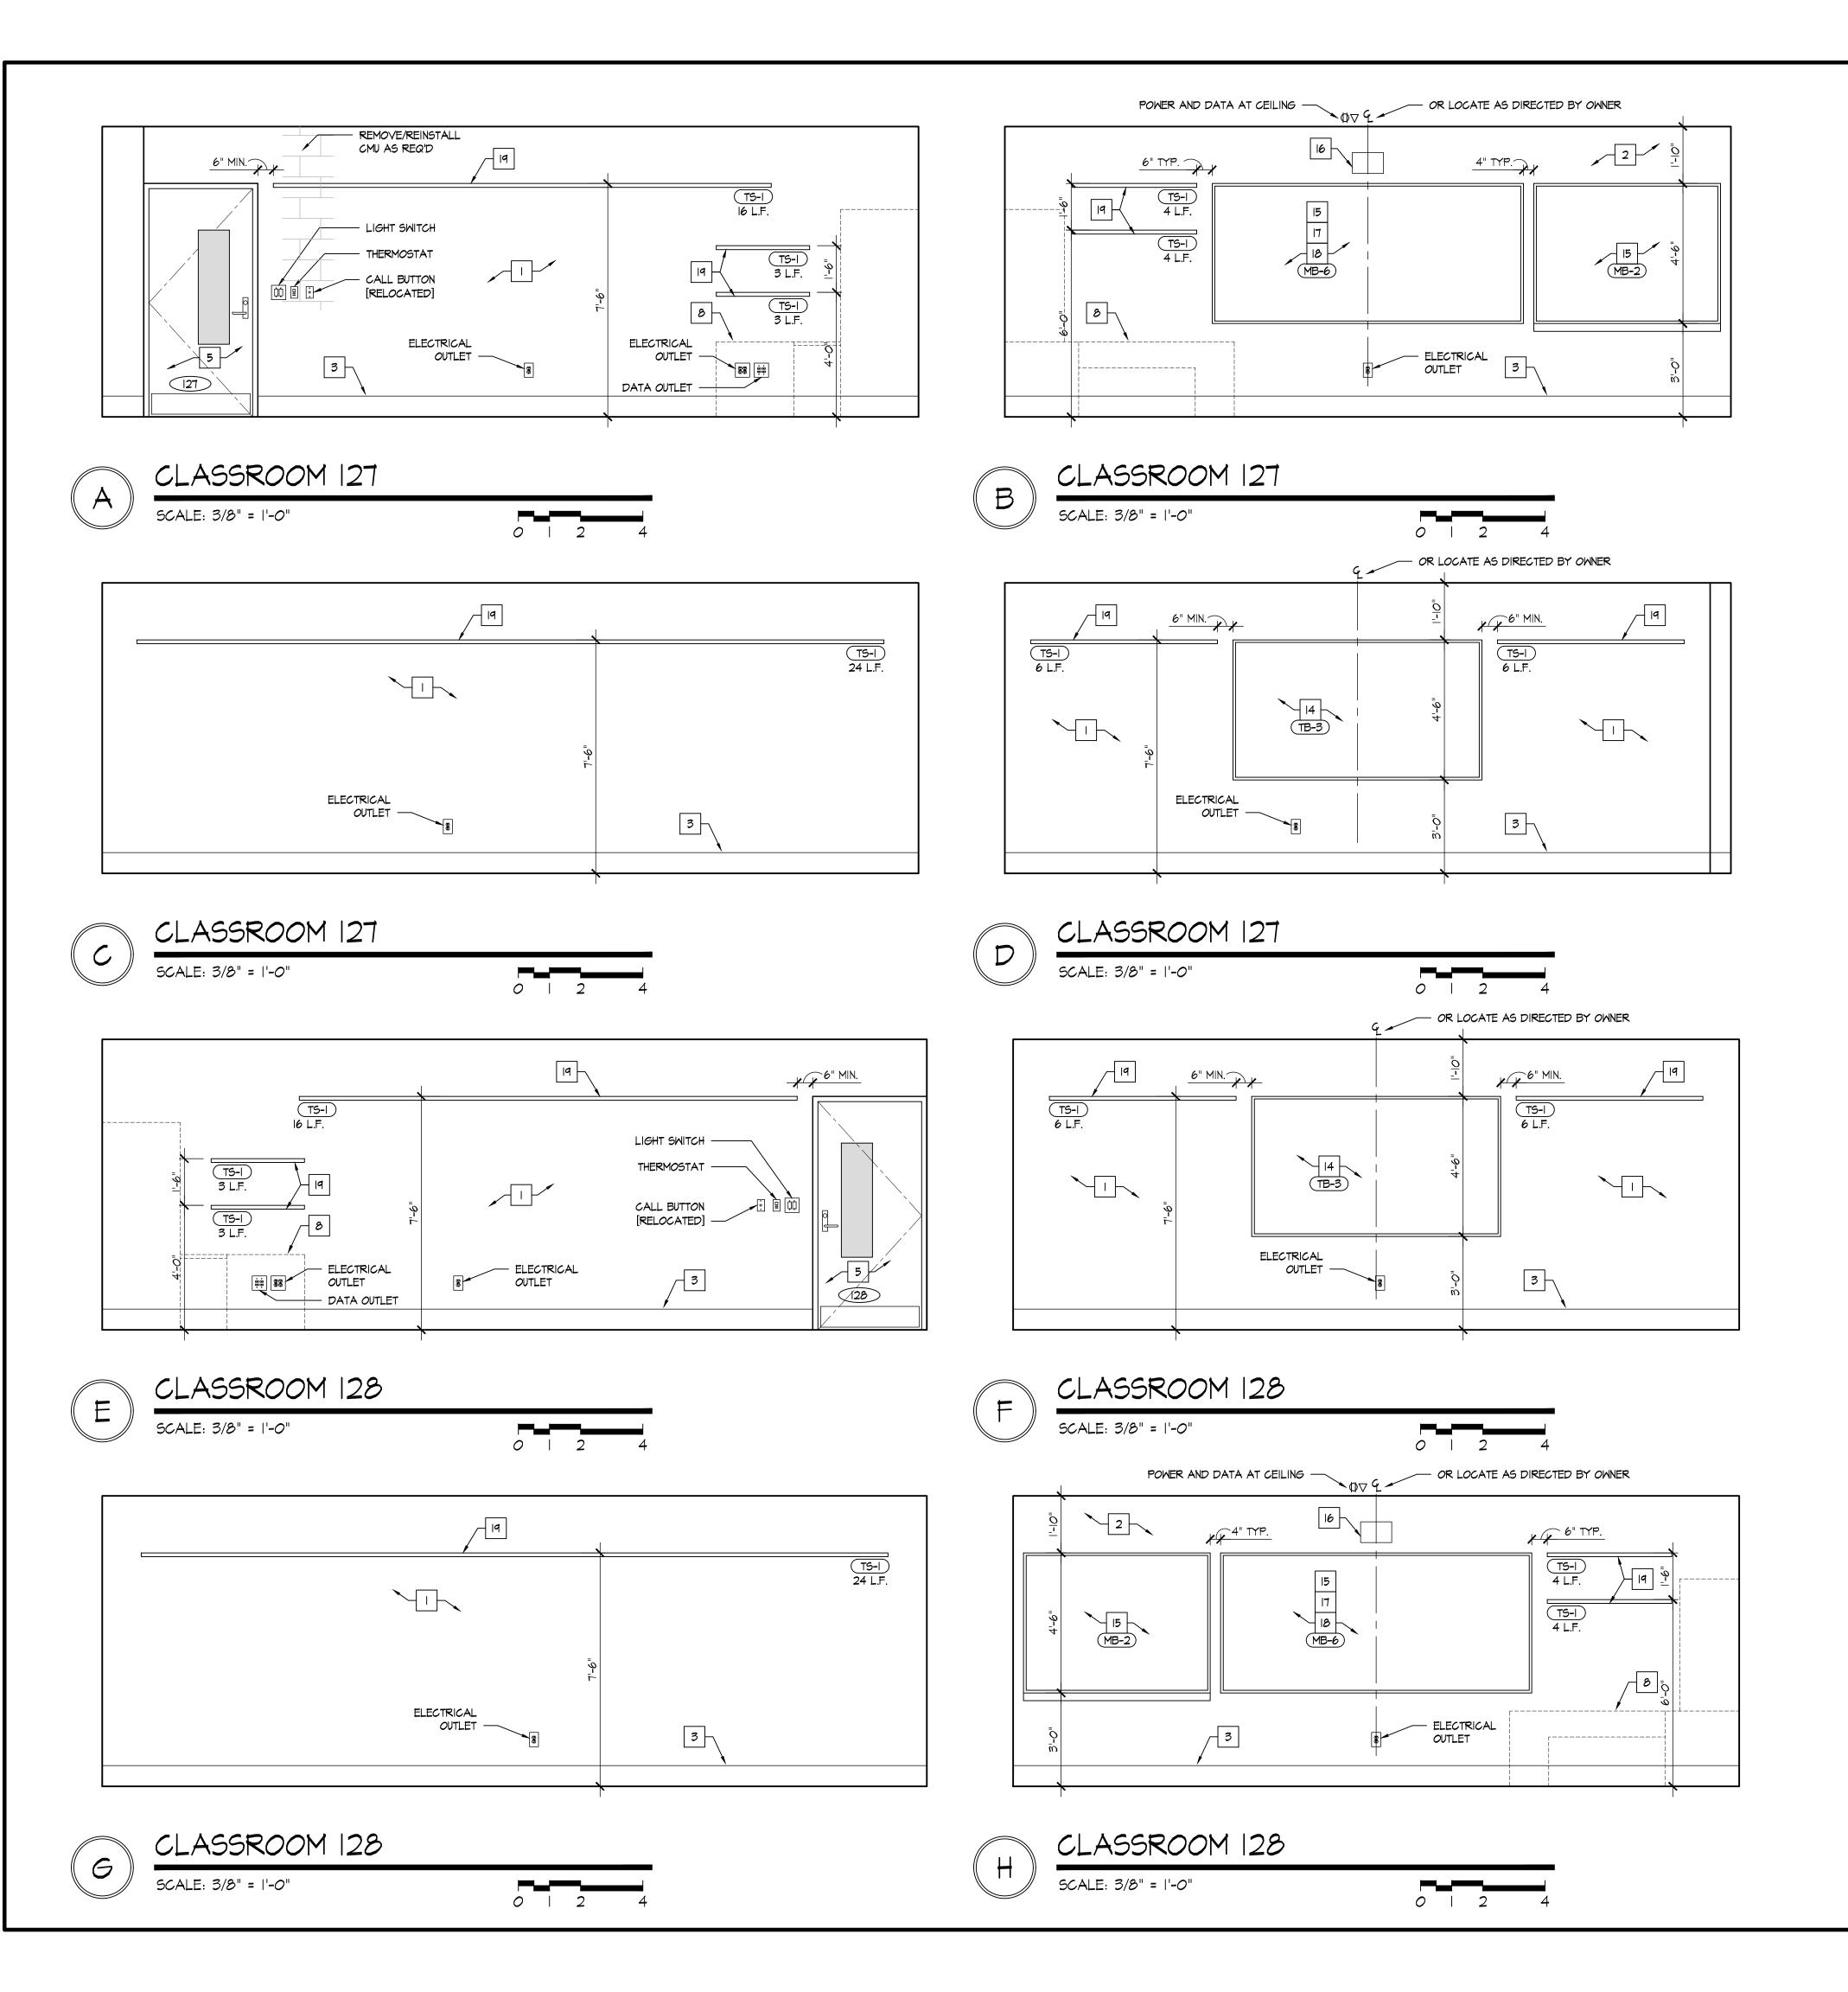

| INTERIOR ELEVATION KEY NOTES

- EXISTING MASONRY WALLS. REPAIR, PREP, AND PAINT.
- NEW MASONRY WALLS. PREP & PAINT.
- 3. WALL BASE, AS SCHEDULED. REFER TO ROOM FINISH SCHEDULE. 4. TV/EQUIPMENT/APPLIANCES PROVIDED BY AND INSTALLED BY OWNER - G.C TO PROVIDE ALL REQUIRED UTILITY CONNECTIONS. REFER TO PME
- 5. DOOR. REFER TO DOOR SCHEDULE.
- 6. LINE OF WALL TRANSITION.
- 7. NEW PRE-FINISHED METAL SCIENCE WALL & BASE CABINETS / CASEWORK / COUNTERTOPS / EQUIPMENT - G.C TO PROVIDE ALL REQUIRED UTILITY
- CONNECTIONS. REFER TO PME DRAWINGS. 8. NEW FURNITURE/MILLWORK PROVIDED BY AND INSTALLED BY OWNER - G.C TO
- PROVIDE ALL REQUIRED UTILITY CONNECTIONS. REFER TO PME DRAWINGS 9. EXISTING WINDOW TO REMAIN.
- 10. NEW WINDOW IN NEW OPENING. REFER TO PLAN. REFER TO WINDOW
- SCHEDULE. II. EXISTING COLUMN TO REMAIN. PREP & PAINT.
- 12. EXISTING ELECTRICAL PANEL. REPE & PAINT [P-I] TYP. REFER TO ELECTRICAL DRAWINGS.
- 13. METAL STUD GYP. BD. WALL. PREP & PAINT.
- 14. NEW TACK BOARD. REFER TO PLAN. SEE SCHEDULE. 15. NEW MAGNETIC MARKER BOARD. REFER TO PLAN. SEE SCHEDULE.
- 16. WALL MOUNTED PROJECTOR. PROVIDED & INSTALLED BY OWNER EXTEND POWER AND DATA TO PROJECTOR LOCATION - REFER TO ELECTRICAL
- 17. MARKER BOARDS AT PROJECTOR LOCATIONS MUST BE INSTALLED PER MANUFACTURER REQUIREMENTS TO MAINTAIN REQUIRED FLATNESS FOR
- INTERACTIVE PROJECTION. 18. NO MARKER TRAY AT PROJECTOR LOCATIONS.
- 19. CONTRACTOR SHALL INSTALL OWNER PROVIDED TACK STRIP. TACK STRIP MOUNTED AT HEIGHTS INDICATED ON INTERIOR ELEVATIONS. COORDINATE FINAL LOCATIONS W OWNER PRIOR TO INSTALLATION.
- 20. NEW ROOM SIGNAGE PROVIDED AND INSTALLED BY OWNER. 21. NEW PLASTIC LAMINATE WALL AND BASE CABINETS. COORDINATE WITH
- OWNER FOR FINISH SELECTION. 22. NEW PLASTIC LAMINATE COUNTERTOP AND BACKSPLASH. COORDINATE WITH OWNER FOR FINISH SELECTION.
- 23. PLASTIC LAMINATE FILLER TO MATCH CABINETS.
- 24. STAINLESS STEEL SINK AND FAUCET. REFER TO PLUMBING DRAWINGS.
- 25. STAINLESS STEEL PULLS.
- 26. FINISHED PLASTIC LAMINATE END PANEL. 27. PLASTIC LAMINATE ENDSPLASH.
- 28. INSTALL RUBBER BASE AT TOE KICK.
- 29. EXISTING COLUMN TO REMAIN. INSTALL 18" DIA. PRE-MANUFACTURED METAL COLUMN COVER. SEE SPECIFICATIONS.
- 30. NEW GYPSUM BOARD BULKHEAD. REFER TO REFLECTED CEILING PLAN.
- 31. EXISTING FIRE EXTINGUISHER CABINET TO REMAIN. PREP & PAINT [P-I] TYP.
- 32. NEW DRINKING FOUNTAIN. REFER TO PME DRAWING. 33. NEW ANODIZED ALUMINUM WALL MOUNTED HANDRAIL.
- 34. LOCKERS BY OWNER
- 35. PREP AND PAINT ENTIRE EXISTING RAIL SYSTEM, TYP.

○ ACCESSORY SCHEDULE

MARK	DESCRIPTION	MODEL
A	SOAP DISPENSER	PROVIDE BY OWNER / INST. BY CONT.
В	PAPER TOWEL DISPENSER	PROVIDE BY OWNER / INST. BY CONT.

- ALL SHALL BE STAINLESS STEEL FINISH.
- FIELD COORDINATE ALL ACCESSORY LOCATIONS, CONFORM TO ALL ACCESSIBILITY INSTALLATION REQUIREMENTS.
- PROVIDE AND INSTALL FRT BLOCKING AS REQUIRED FOR ALL ACCESSORIES.

GENERAL INTERIOR NOTES

- REPAIR EX. CMU AS REQ'D AT EXISTING WALLS.
- 2. NOMINAL CABINET SIZES INDICATED. VERIFY & PROVIDE ALL REQUIRED FILLERS, ETC. FOR CASEMORK TO ALLOW PROPER OPERATION OF DOORS &
- DRAWERS, TYPICAL. 3. GC TO PROVIDE AND INSTALL ALL FRT BLOCKING AS REQUIRED FOR ALL CABINETS, SHELVES, ACCESSORIES, ETC.



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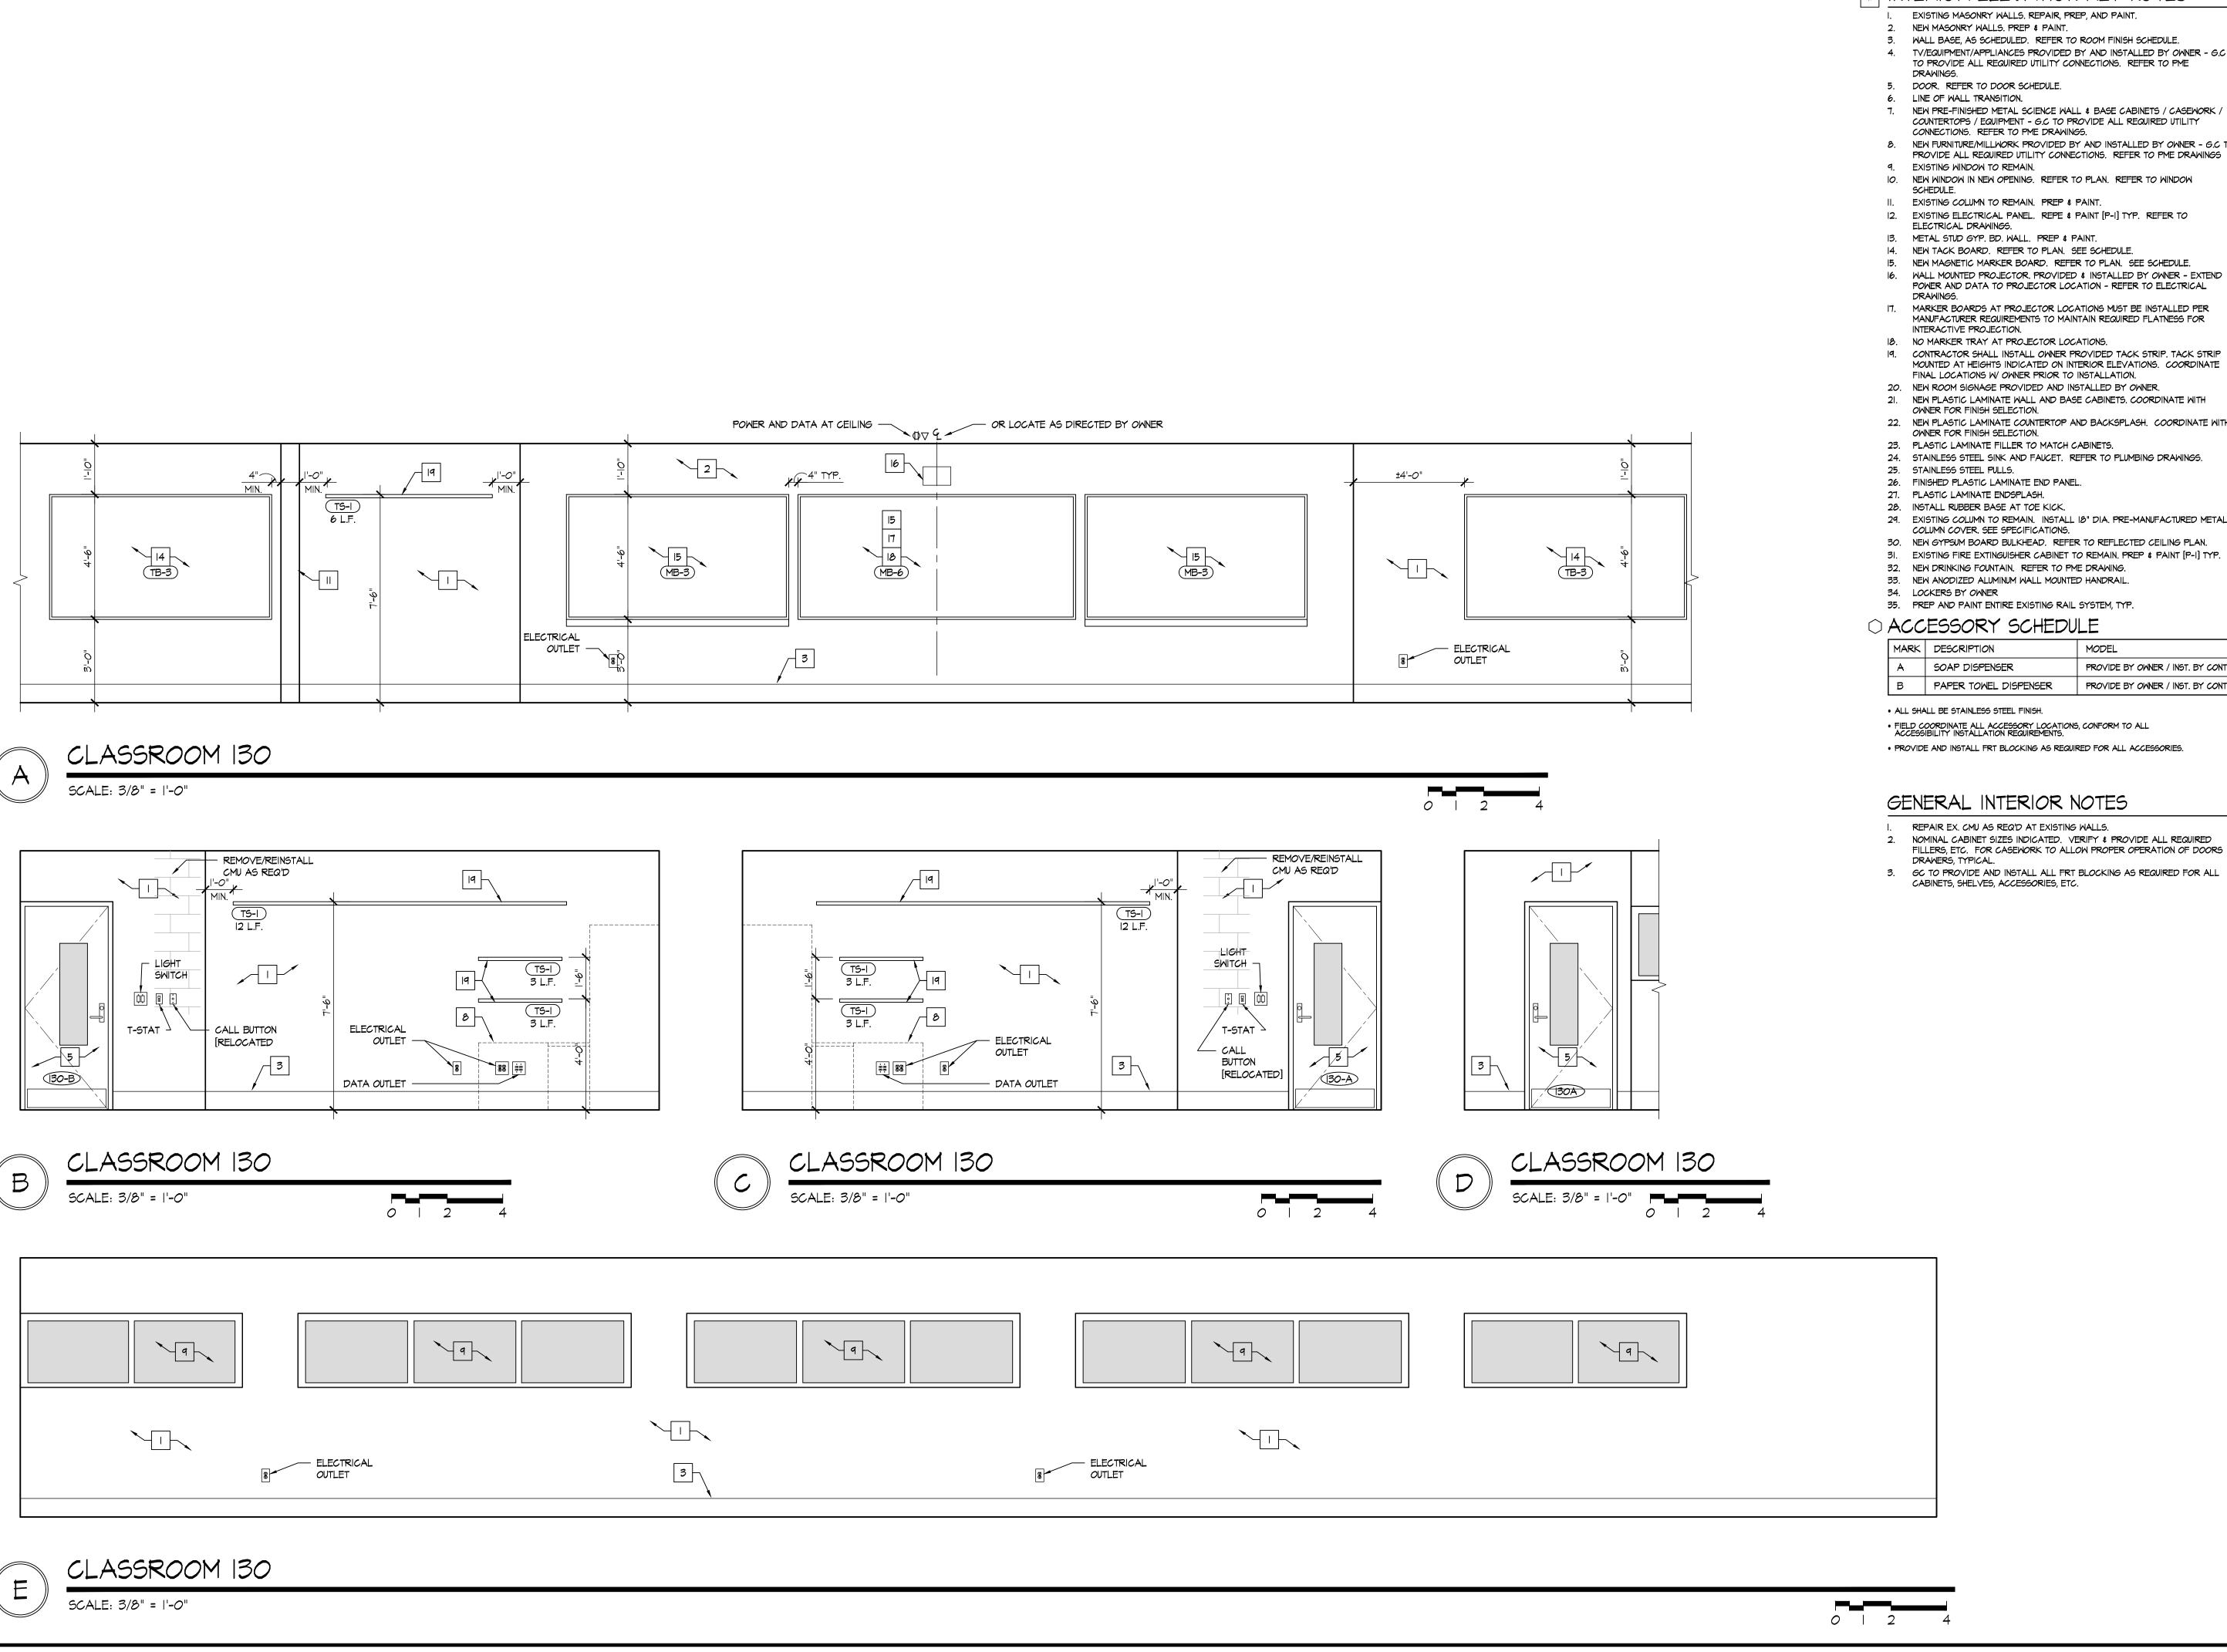
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Sheet Title

CLASSROOMS | 27 \$ | 28 INTERIOR ELEVATIONS

Sheet Number



| INTERIOR ELEVATION KEY NOTES

EXISTING MASONRY WALLS. REPAIR, PREP, AND PAINT.

NEW MASONRY WALLS. PREP & PAINT.

3. WALL BASE, AS SCHEDULED. REFER TO ROOM FINISH SCHEDULE. 4. TV/EQUIPMENT/APPLIANCES PROVIDED BY AND INSTALLED BY OWNER - G.C TO PROVIDE ALL REQUIRED UTILITY CONNECTIONS. REFER TO PME

5. DOOR. REFER TO DOOR SCHEDULE.

6. LINE OF WALL TRANSITION.

- 7. NEW PRE-FINISHED METAL SCIENCE WALL & BASE CABINETS / CASEWORK / COUNTERTOPS / EQUIPMENT - G.C TO PROVIDE ALL REQUIRED UTILITY
- 8. NEW FURNITURE/MILLWORK PROVIDED BY AND INSTALLED BY OWNER G.C TO PROVIDE ALL REQUIRED UTILITY CONNECTIONS. REFER TO PME DRAWINGS
- 10. NEW WINDOW IN NEW OPENING. REFER TO PLAN. REFER TO WINDOW

II. EXISTING COLUMN TO REMAIN. PREP & PAINT.

- 12. EXISTING ELECTRICAL PANEL. REPE & PAINT [P-I] TYP. REFER TO ELECTRICAL DRAWINGS.
- 13. METAL STUD GYP. BD. WALL. PREP & PAINT.
- 14. NEW TACK BOARD. REFER TO PLAN. SEE SCHEDULE. 15. NEW MAGNETIC MARKER BOARD. REFER TO PLAN. SEE SCHEDULE.
- POWER AND DATA TO PROJECTOR LOCATION REFER TO ELECTRICAL
- 17. MARKER BOARDS AT PROJECTOR LOCATIONS MUST BE INSTALLED PER MANUFACTURER REQUIREMENTS TO MAINTAIN REQUIRED FLATNESS FOR
- 18. NO MARKER TRAY AT PROJECTOR LOCATIONS.
- 19. CONTRACTOR SHALL INSTALL OWNER PROVIDED TACK STRIP. TACK STRIP MOUNTED AT HEIGHTS INDICATED ON INTERIOR ELEVATIONS. COORDINATE FINAL LOCATIONS W OWNER PRIOR TO INSTALLATION.
- 21. NEW PLASTIC LAMINATE WALL AND BASE CABINETS. COORDINATE WITH OWNER FOR FINISH SELECTION.
- 22. NEW PLASTIC LAMINATE COUNTERTOP AND BACKSPLASH. COORDINATE WITH
- 23. PLASTIC LAMINATE FILLER TO MATCH CABINETS.
- 24. STAINLESS STEEL SINK AND FAUCET. REFER TO PLUMBING DRAWINGS.
- 26. FINISHED PLASTIC LAMINATE END PANEL.
- 28. INSTALL RUBBER BASE AT TOE KICK.
- 29. EXISTING COLUMN TO REMAIN. INSTALL 18" DIA. PRE-MANUFACTURED METAL
- 30. NEW GYPSUM BOARD BULKHEAD. REFER TO REFLECTED CEILING PLAN.
- 31. EXISTING FIRE EXTINGUISHER CABINET TO REMAIN. PREP & PAINT [P-I] TYP.
- 33. NEW ANODIZED ALUMINUM WALL MOUNTED HANDRAIL.
- 35. PREP AND PAINT ENTIRE EXISTING RAIL SYSTEM, TYP.

○ ACCESSORY SCHEDULE


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A	SOAP DISPENSER	PROVIDE BY OWNER / INST. BY CONT.
В	PAPER TOWEL DISPENSER	PROVIDE BY OWNER / INST. BY CONT.

ALL SHALL BE STAINLESS STEEL FINISH.

- FIELD COORDINATE ALL ACCESSORY LOCATIONS, CONFORM TO ALL ACCESSIBILITY INSTALLATION REQUIREMENTS.
- PROVIDE AND INSTALL FRT BLOCKING AS REQUIRED FOR ALL ACCESSORIES.

GENERAL INTERIOR NOTES

- REPAIR EX. CMU AS REQ'D AT EXISTING WALLS.
- 2. NOMINAL CABINET SIZES INDICATED. VERIFY & PROVIDE ALL REQUIRED FILLERS, ETC. FOR CASEMORK TO ALLOW PROPER OPERATION OF DOORS &
- 3. GC TO PROVIDE AND INSTALL ALL FRT BLOCKING AS REQUIRED FOR ALL CABINETS, SHELVES, ACCESSORIES, ETC.

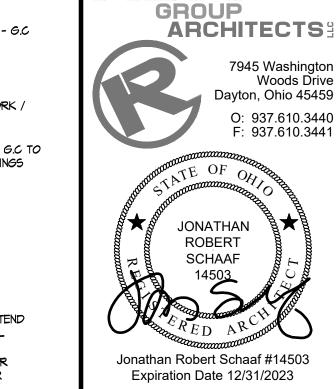

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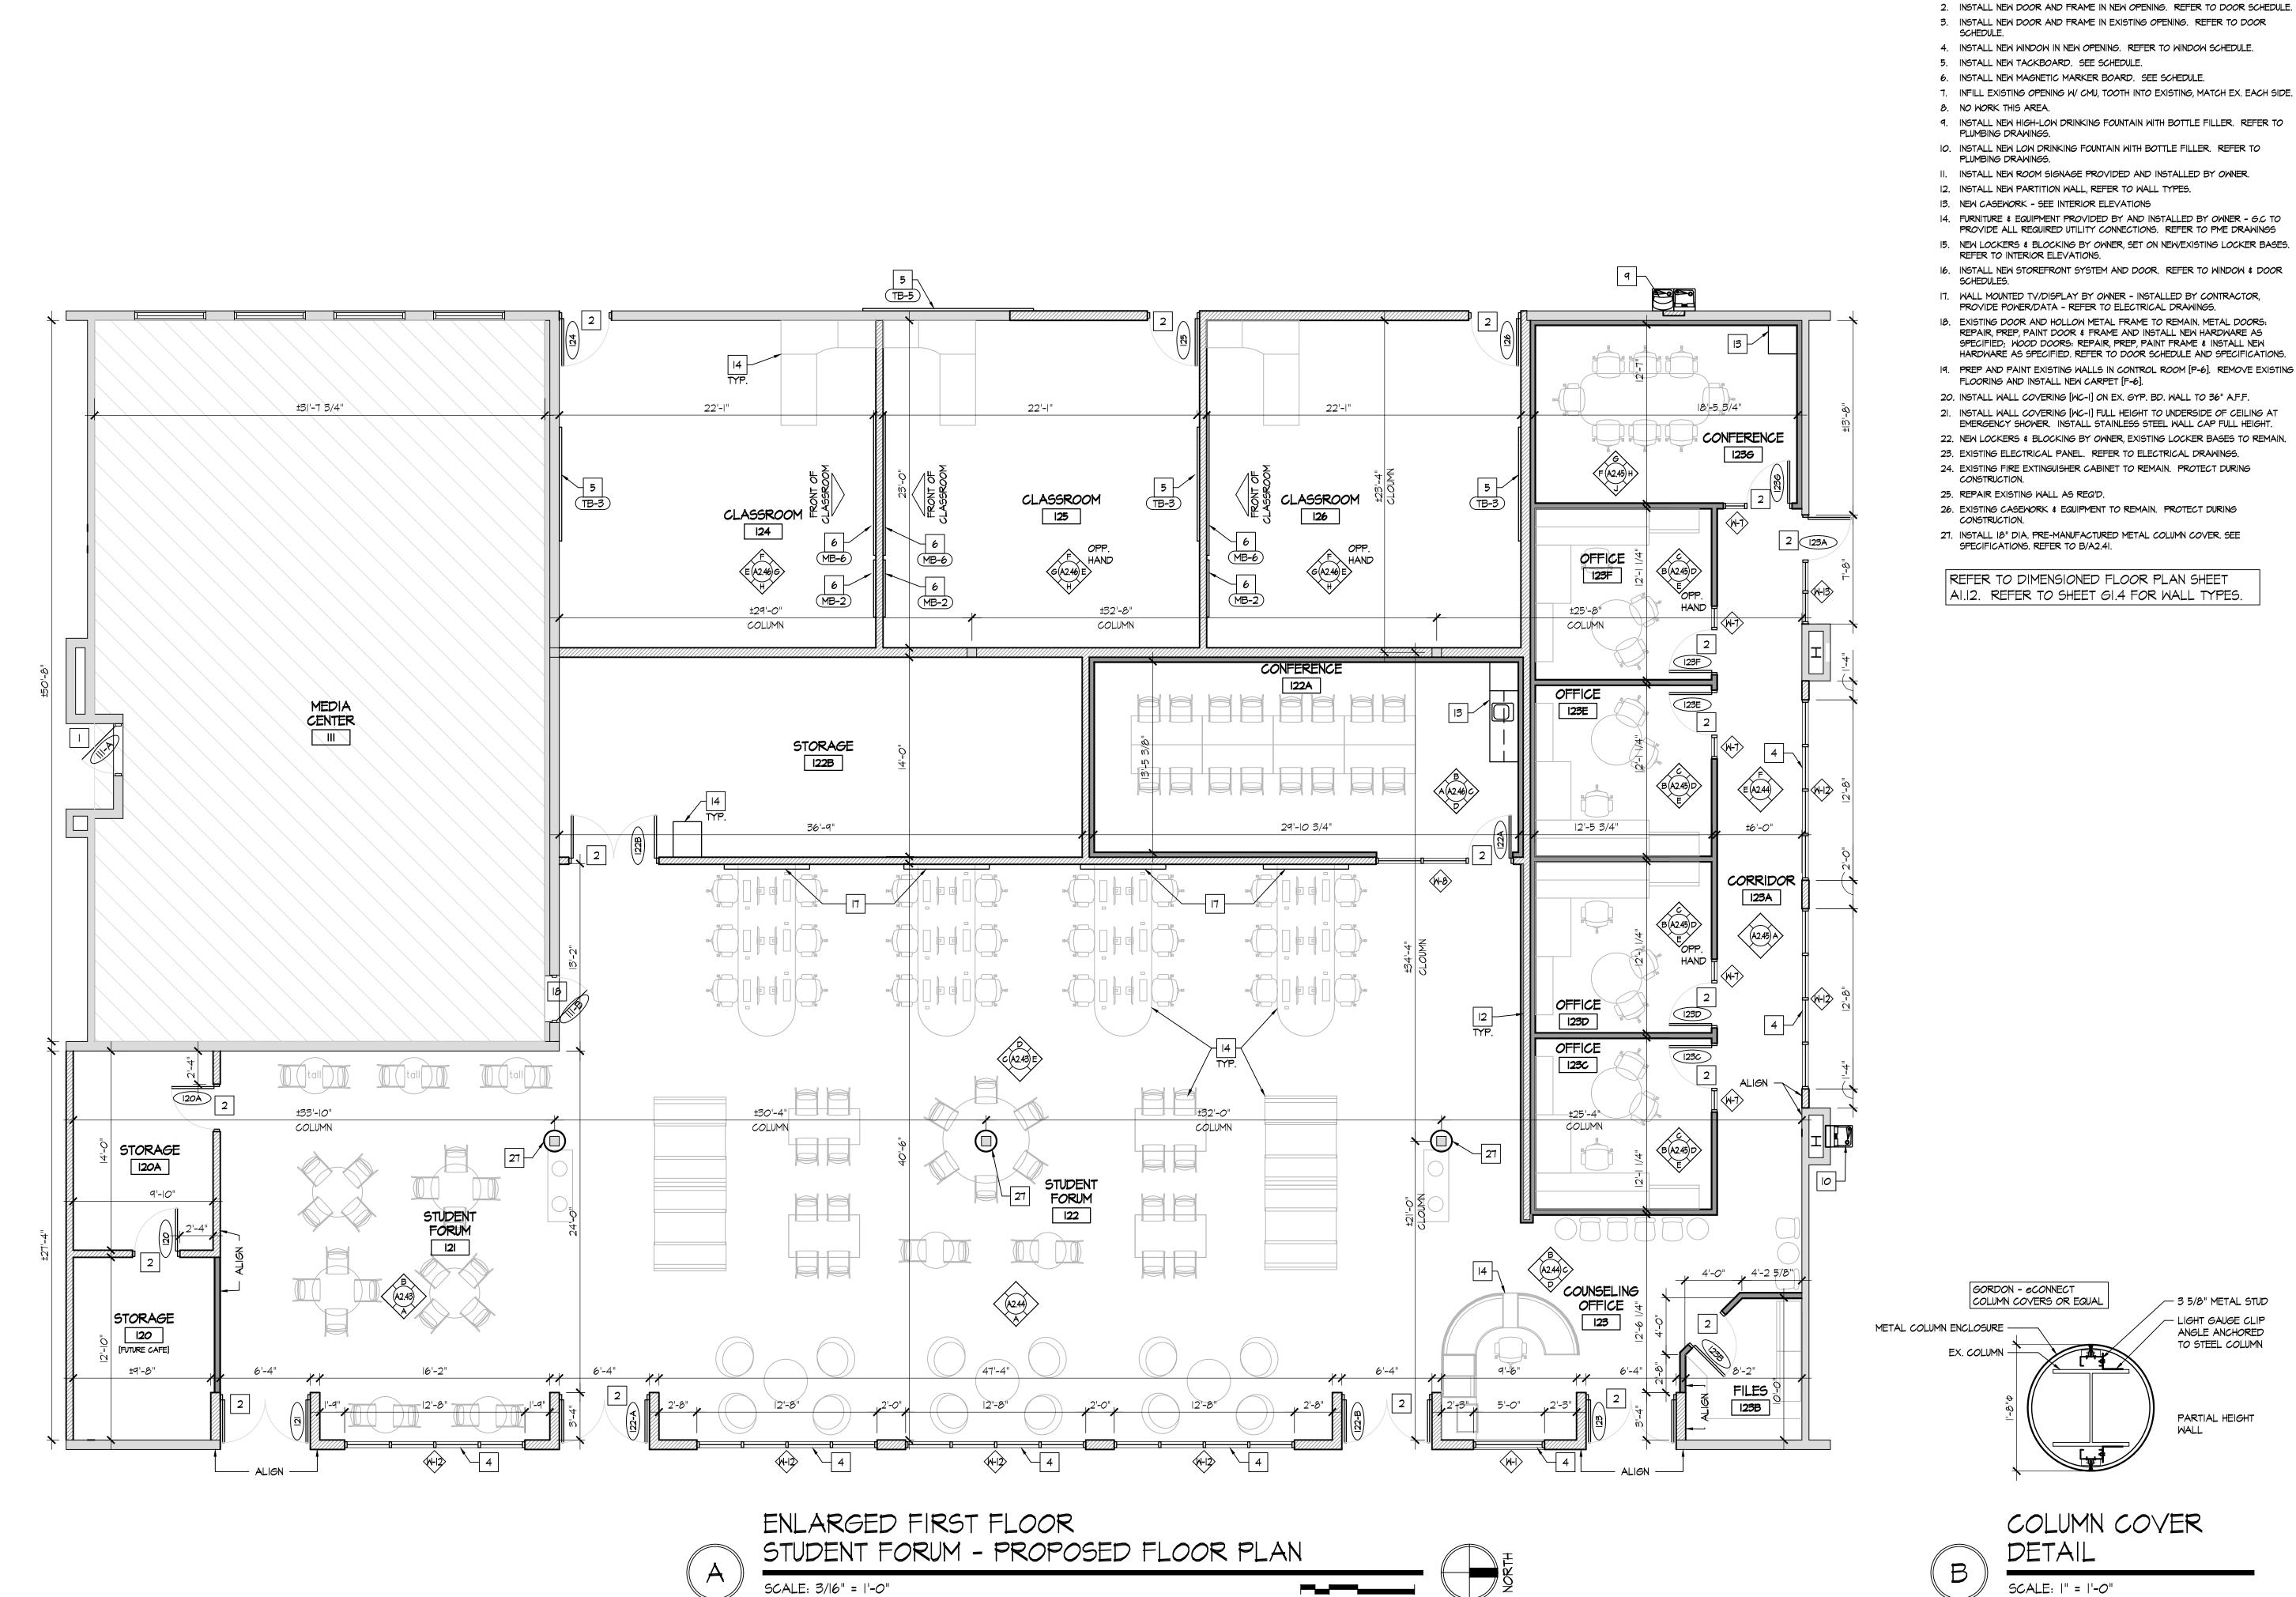
Date

January 24, 2022

Sheet Title

CLASSROOM 130 INTERIOR ELEVATIONS

Sheet Number



* NEW CONSTRUCTION KEY NOTES

EXISTING SOLID CORE WOOD DOOR AND HOLLOW METAL FRAME TO REMAIN. REPAIR & RE-FINISH EX. WOOD DOOR SLAB AND INSTALL NEW HARDWARE AS SPECIFIED. REFER TO DOOR SCHEDULE AND SPECIFICATIONS.

2. INSTALL NEW DOOR AND FRAME IN NEW OPENING. REFER TO DOOR SCHEDULE.

3. INSTALL NEW DOOR AND FRAME IN EXISTING OPENING. REFER TO DOOR

4. INSTALL NEW WINDOW IN NEW OPENING. REFER TO WINDOW SCHEDULE.

5. INSTALL NEW TACKBOARD. SEE SCHEDULE.

6. INSTALL NEW MAGNETIC MARKER BOARD. SEE SCHEDULE.

7. INFILL EXISTING OPENING W/ CMU, TOOTH INTO EXISTING, MATCH EX. EACH SIDE. 8. NO WORK THIS AREA.

9. INSTALL NEW HIGH-LOW DRINKING FOUNTAIN WITH BOTTLE FILLER. REFER TO PLUMBING DRAWINGS.

IO. INSTALL NEW LOW DRINKING FOUNTAIN WITH BOTTLE FILLER. REFER TO PLUMBING DRAWINGS.

II. INSTALL NEW ROOM SIGNAGE PROVIDED AND INSTALLED BY OWNER. 12. INSTALL NEW PARTITION WALL, REFER TO WALL TYPES.

13. NEW CASEWORK - SEE INTERIOR ELEVATIONS

14. FURNITURE & EQUIPMENT PROVIDED BY AND INSTALLED BY OWNER - G.C TO PROVIDE ALL REQUIRED UTILITY CONNECTIONS. REFER TO PME DRAWINGS

15. NEW LOCKERS & BLOCKING BY OWNER, SET ON NEW/EXISTING LOCKER BASES.

16. INSTALL NEW STOREFRONT SYSTEM AND DOOR. REFER TO WINDOW & DOOR

17. WALL MOUNTED TV/DISPLAY BY OWNER - INSTALLED BY CONTRACTOR,

PROVIDE POWER/DATA - REFER TO ELECTRICAL DRAWINGS. 18. EXISTING DOOR AND HOLLOW METAL FRAME TO REMAIN. METAL DOORS:

REPAIR, PREP, PAINT DOOR & FRAME AND INSTALL NEW HARDWARE AS SPECIFIED; WOOD DOORS: REPAIR, PREP, PAINT FRAME & INSTALL NEW HARDWARE AS SPECIFIED. REFER TO DOOR SCHEDULE AND SPECIFICATIONS.

FLOORING AND INSTALL NEW CARPET [F-6].

20. INSTALL WALL COVERING [WC-I] ON EX. GYP. BD. WALL TO 36" A.F.F.

EMERGENCY SHOWER. INSTALL STAINLESS STEEL WALL CAP FULL HEIGHT. 22. NEW LOCKERS & BLOCKING BY OWNER, EXISTING LOCKER BASES TO REMAIN.

23. EXISTING ELECTRICAL PANEL. REFER TO ELECTRICAL DRAWINGS. 24. EXISTING FIRE EXTINGUISHER CABINET TO REMAIN. PROTECT DURING

CONSTRUCTION.

25. REPAIR EXISTING WALL AS REQ'D.

26. EXISTING CASEWORK & EQUIPMENT TO REMAIN. PROTECT DURING CONSTRUCTION.

27. INSTALL 18" DIA. PRE-MANUFACTURED METAL COLUMN COVER. SEE SPECIFICATIONS. REFER TO B/A2.41.

REFER TO DIMENSIONED FLOOR PLAN SHEET AI.12. REFER TO SHEET GI.4 FOR WALL TYPES.

GROUP

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ARCHITECTS



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— 3 5/8" METAL STUD

— LIGHT GAUGE CLIP ANGLE ANCHORED TO STEEL COLUMN

PARTIAL HEIGHT

COLUMN COVER

DETAIL

SCALE: |" = |'-0"


January 24, 2022 Sheet Title

Date

ENLARGED STUDENT FORUM PROPOSED

FLOOR PLAN

Sheet Number

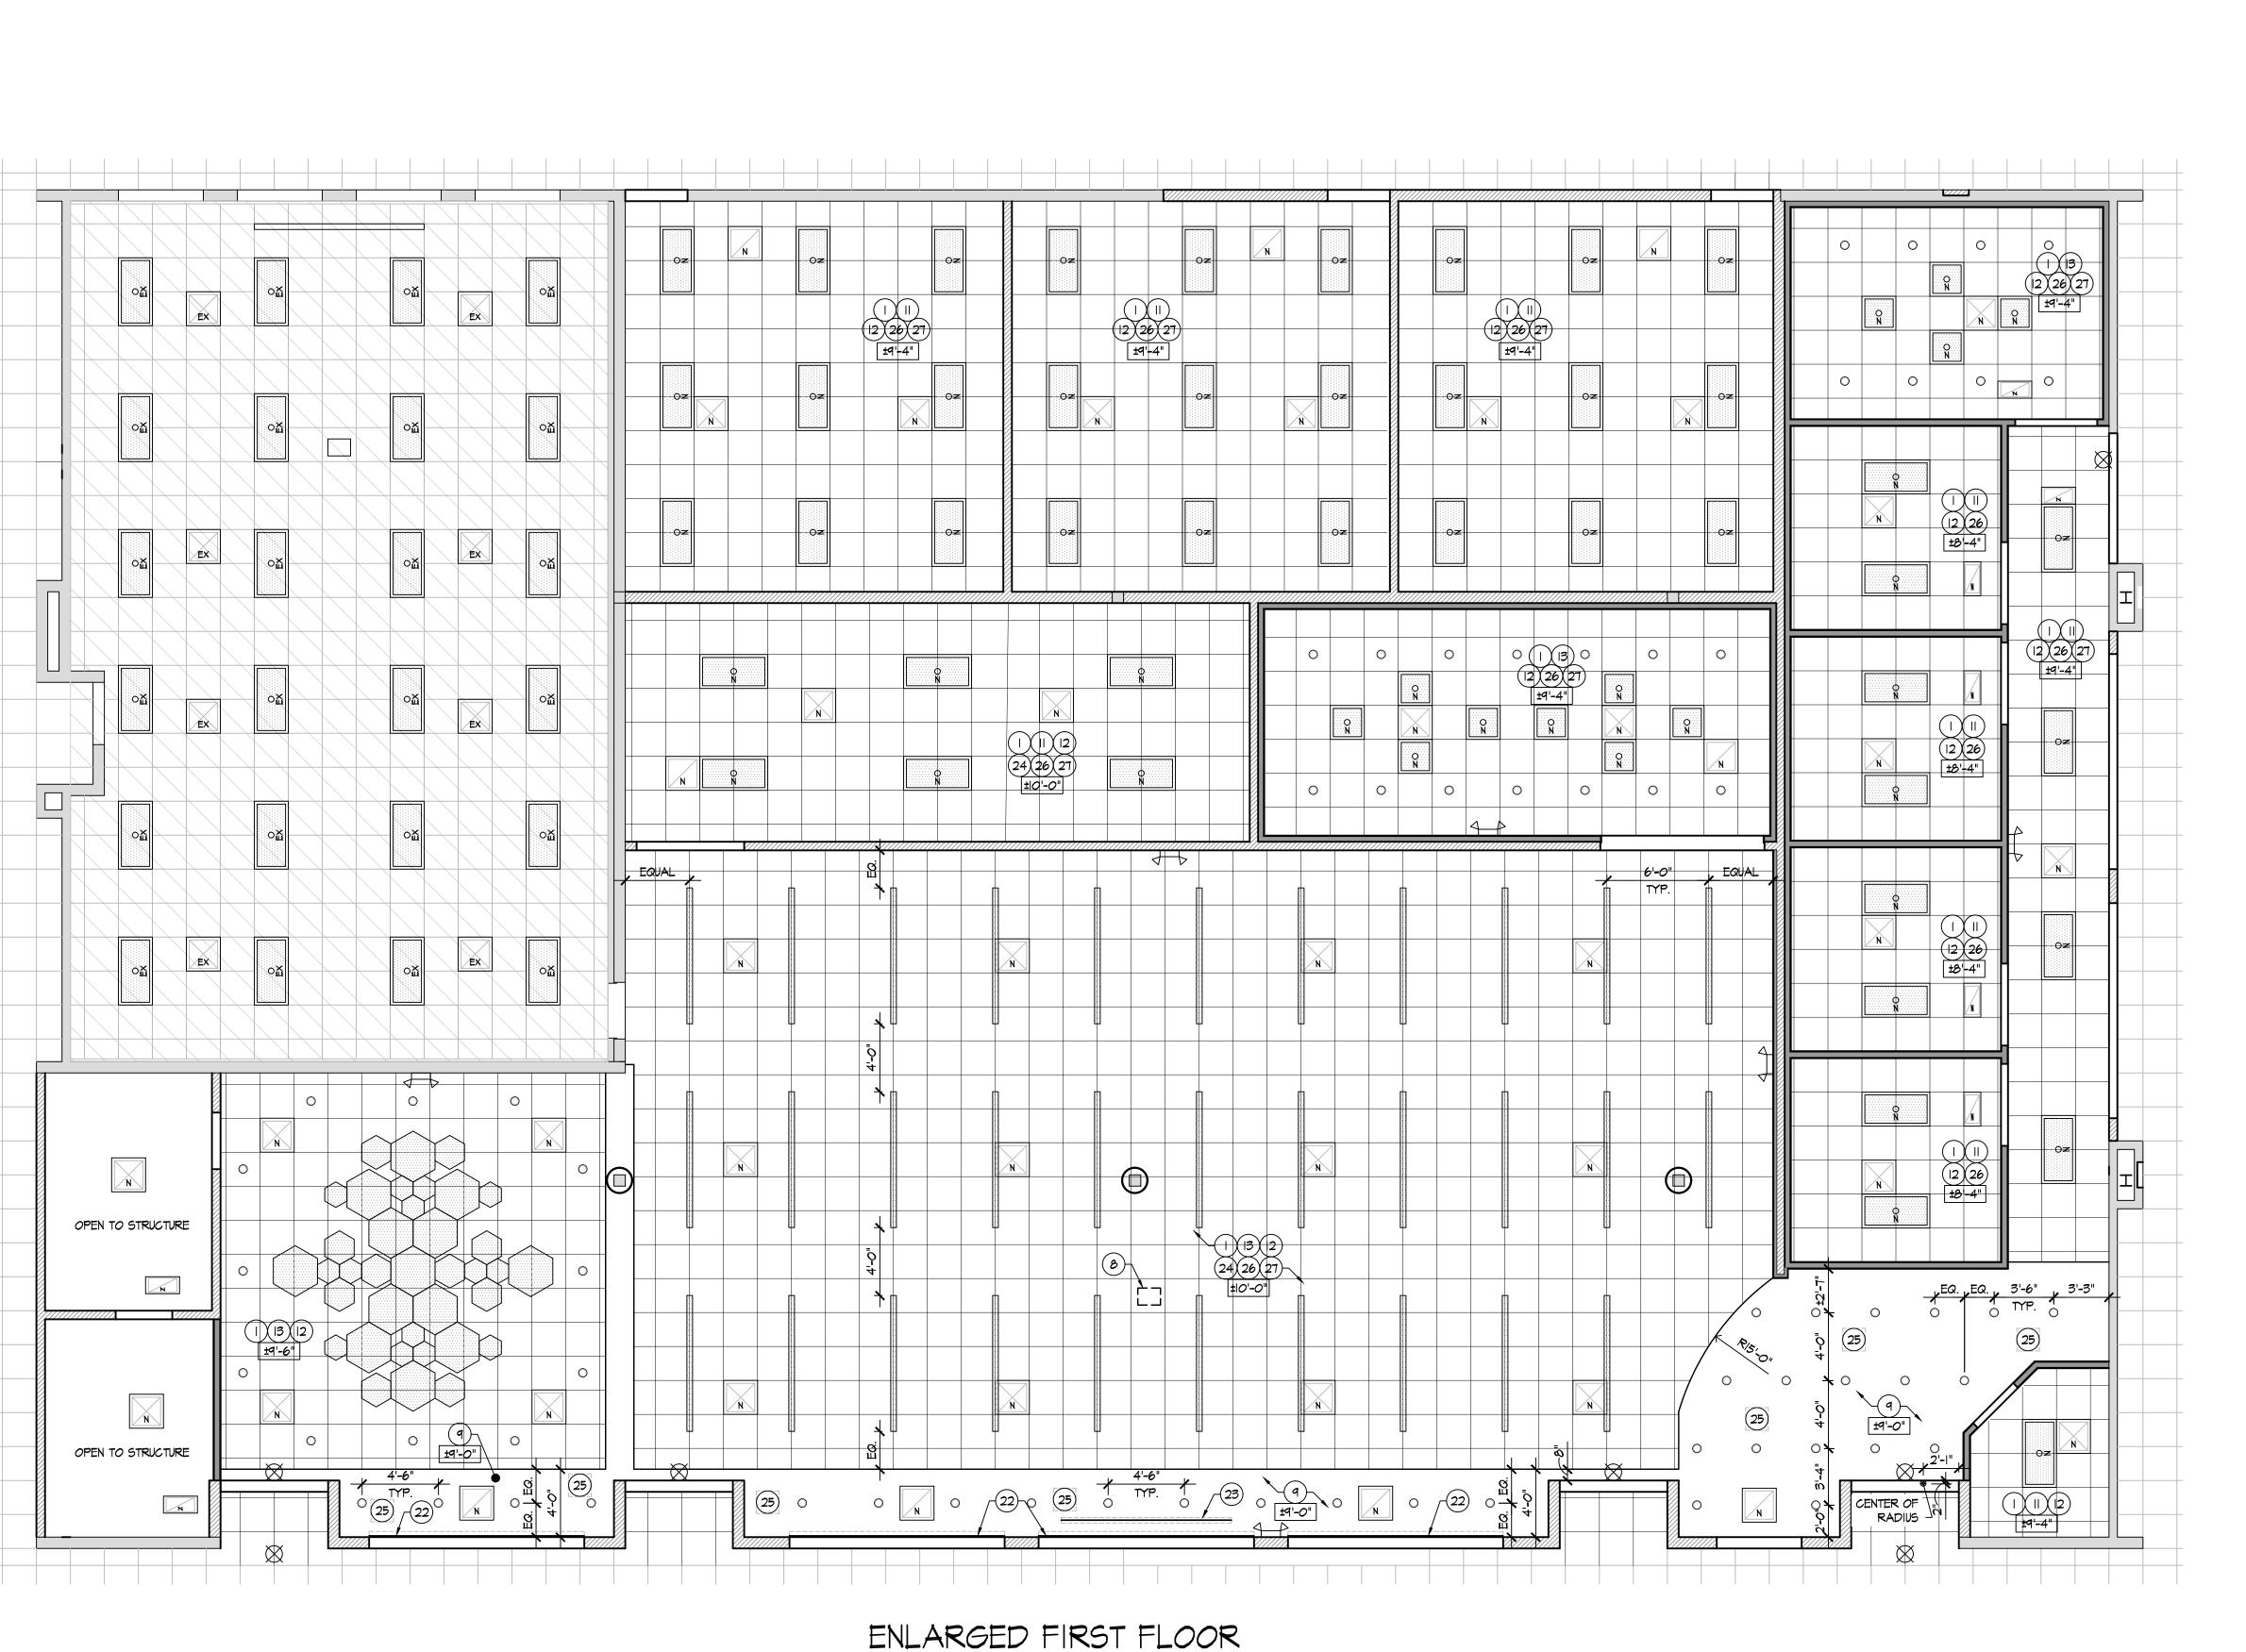

STUDENT FORUM - REFLECTED CEILING PLAN

SCALE: 3/16" = 1'-0"

(*) REFLECTED CEILING KEY NOTES

INSTALL NEW 2x2 CEILING GRID AND ACOUSTIC CEILING TILES. REFER TO PLAN

2. EXISTING 2x4 CEILING GRID. INSTALL NEW GRID TEE. PAINT NEW & EXISTING

CEILING GRID. INSTALL NEW 2x2 ACOUSTIC CEILING TILES. 3. RE-INSTALL EXISTING LIGHT FIXTURES INTO CEILING SYSTEM. REPLACE LENS.

REFER TO PME DRAWINGS.

4. RE-INSTALL EXISTING HVAC DIFFUSERS INTO CEILING SYSTEM. REFER TO PME

5. RE-INSTALL EXISTING FIRE ALARM DEVICES INTO NEW CEILING SYSTEM. COORDINATE WITH PME DRAWINGS. 6. RE-INSTALL EXIST. SPEAKERS INTO NEW CEILING SYSTEM. COORDINATE WITH

7. INSTALL NEW LIGHT FIXTURES INTO NEW CEILING SYSTEM. REFER TO

ELECTRICAL DRAWINGS. 8. CEILING MOUNTED PROJECTOR PROVIDED BY OWNER, INSTALLED BY CONTRACTOR. PROVIDE BLOCKING/BRACING AS REQ'D BY CONDITIONS. F.V. EXACT LOCATION WITH OWNER.

9. INSTALL NEW 5/8" GYPSUM BOARD OVER NEW 3 5/8" METAL STUD FRAMING. 10. INSTALL NEW 2x2 CEILING GRID AND ACOUSTIC CEILING TILES. ALIGN WITH EXISTING ADJACENT CEILING GRID.

II. INSTALL NEW 2X4 LIGHT FIXTURES. REFER TO ELECTRICAL DRAWINGS.

12. INSTALL NEW HVAC DIFFUSERS. REFER TO MECHANICAL DRAWINGS. 13. INSTALL NEW LIGHT FIXTURES. REFER TO ELECTRICAL DRAWINGS.

14. CUTBACK/EXTEND/MODIFY EXISTING ATC THIS AREA, INSTALL NEW WALL MOLD & CEILING PADS AS REQ'D.

15. INSTALL NEW EXHAUST FAN. REFER TO MECHANICAL DRAWINGS. 16. RETURN AIR SLOT. REFER TO MECHANICAL DRAWINGS.

17. EXISTING PLASTER/GYP. BD. CEILING TO REMAIN. PREP & PAINT [P-5]. 18. EXISTING LIGHTING TO REMAIN. CLEAN AND RE-LAMP. REFER TO ELECTRICAL

19. EXISTING HVAC DIFFUSERS TO REMAIN. REFER TO MECHANICAL DRAWINGS. 20. EXISTING CEILING TO REMAIN THIS ROOM. NO WORK.

21. EXISTING 2X2 CEILING GRID AND CEILING TILES TO REMAIN. CLEAN AND REPLACE ANY STAINED/DAMAGED CEILING AS REQ'D. INSTALL NEW LIGHT

FIXTURES WHERE INDICATED. COORDINATE WITH PME DRAWINGS. 22. INSTALL NEW MOTORIZED WINDOW SHADES. REFER TO SPECIFICATION \$

ELECTRICAL DRAWINGS. 23. INSTALL MOTORIZED DROP DOWN PROJECTOR SCREEN. REFER TO SPECIFICATIONS & ELECTRICAL DRAWINGS.

24. DESIGN INTENT IS FOR NEW CEILING TO BE INSTALLED AS HIGH AS POSSIBLE THIS ROOM. COORDINATE WITH OWNER & ARCHITECT AFTER DEMOLITION TO DETERMINE EXACT CEILING HEIGHT.

25. PROVIDE & INSTALL 16"X16" MIN. ACCESS PANELS PAINTED TO MATCH CEILING. FIELD COORDINATE EXACT LOCATION.

26. INSTALL NEW FIRE ALARM DEVICES IN NEW CEILING SYSTEM THIS ROOM. REFER TO ELECTRICAL DRAWINGS.

27. NEW SPEAKERS, CAMERAS, ACCESS POINTS, ETC. IN THIS ROOM WILL BE PROVIDED AND INSTALLED BY OWNER. FIELD COORDINATE LOCATIONS.

REFLECTED CEILING SYMBOL LEGEND

EXISTING 2x2 / 2x4 LAY-IN LIGHTS - REFER TO ELECTRICAL

NEW 2x2 / 2x4 LAY-IN LIGHTS - REFER TO ELECTRICAL DRAWINGS RELOCATED 2x2 / 2x4 LA RELOCATED 2x2 / 2x4 LAY-IN LIGHTS - REFER TO

CAN LIGHT FIXTURE - REFER TO ELECTRICAL DRAWINGS. HEXAGON LIGHT FIXTURE - REFER TO ELECTRICAL

DRAWINGS. SUSPENDED LINEAR LIGHT FIXTURE - REFER TO ELECTRICAL DRAWINGS. EMERGENCY LIGHT / EXIT SIGN FIXTURES - REFER TO

ELECTRICAL DRAWINGS. CEILING SPEAKERS - REFER TO ELECTRICAL DRAWINGS. SMOKE DETECTOR DEVICES - REFER TO ELECTRICAL

CEILING MOUNTED CAMERAS - REFER TO ELECTRICAL

FIRE ALARM DEVICE - REFER TO ELECTRICAL DRAWINGS. OCCUPANCY SENSORS - REFER TO ELECTRICAL DRAWINGS.

ACCESS POINT - REFER TO ELECTRICAL DRAWINGS. N EX

EXISTING & NEW HVAC DIFFUSERS - REFER TO MECHANICAL

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Jonathan Robert Schaaf #14503

Expiration Date 12/31/2023

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01/24/22 BID SET/

CONSTRUCTION

Project Number


2021-203

Date January 24, 2022

Sheet Title

ENLARGED STUDENT FORUM REFLECTED CEILING PLAN

Sheet Number

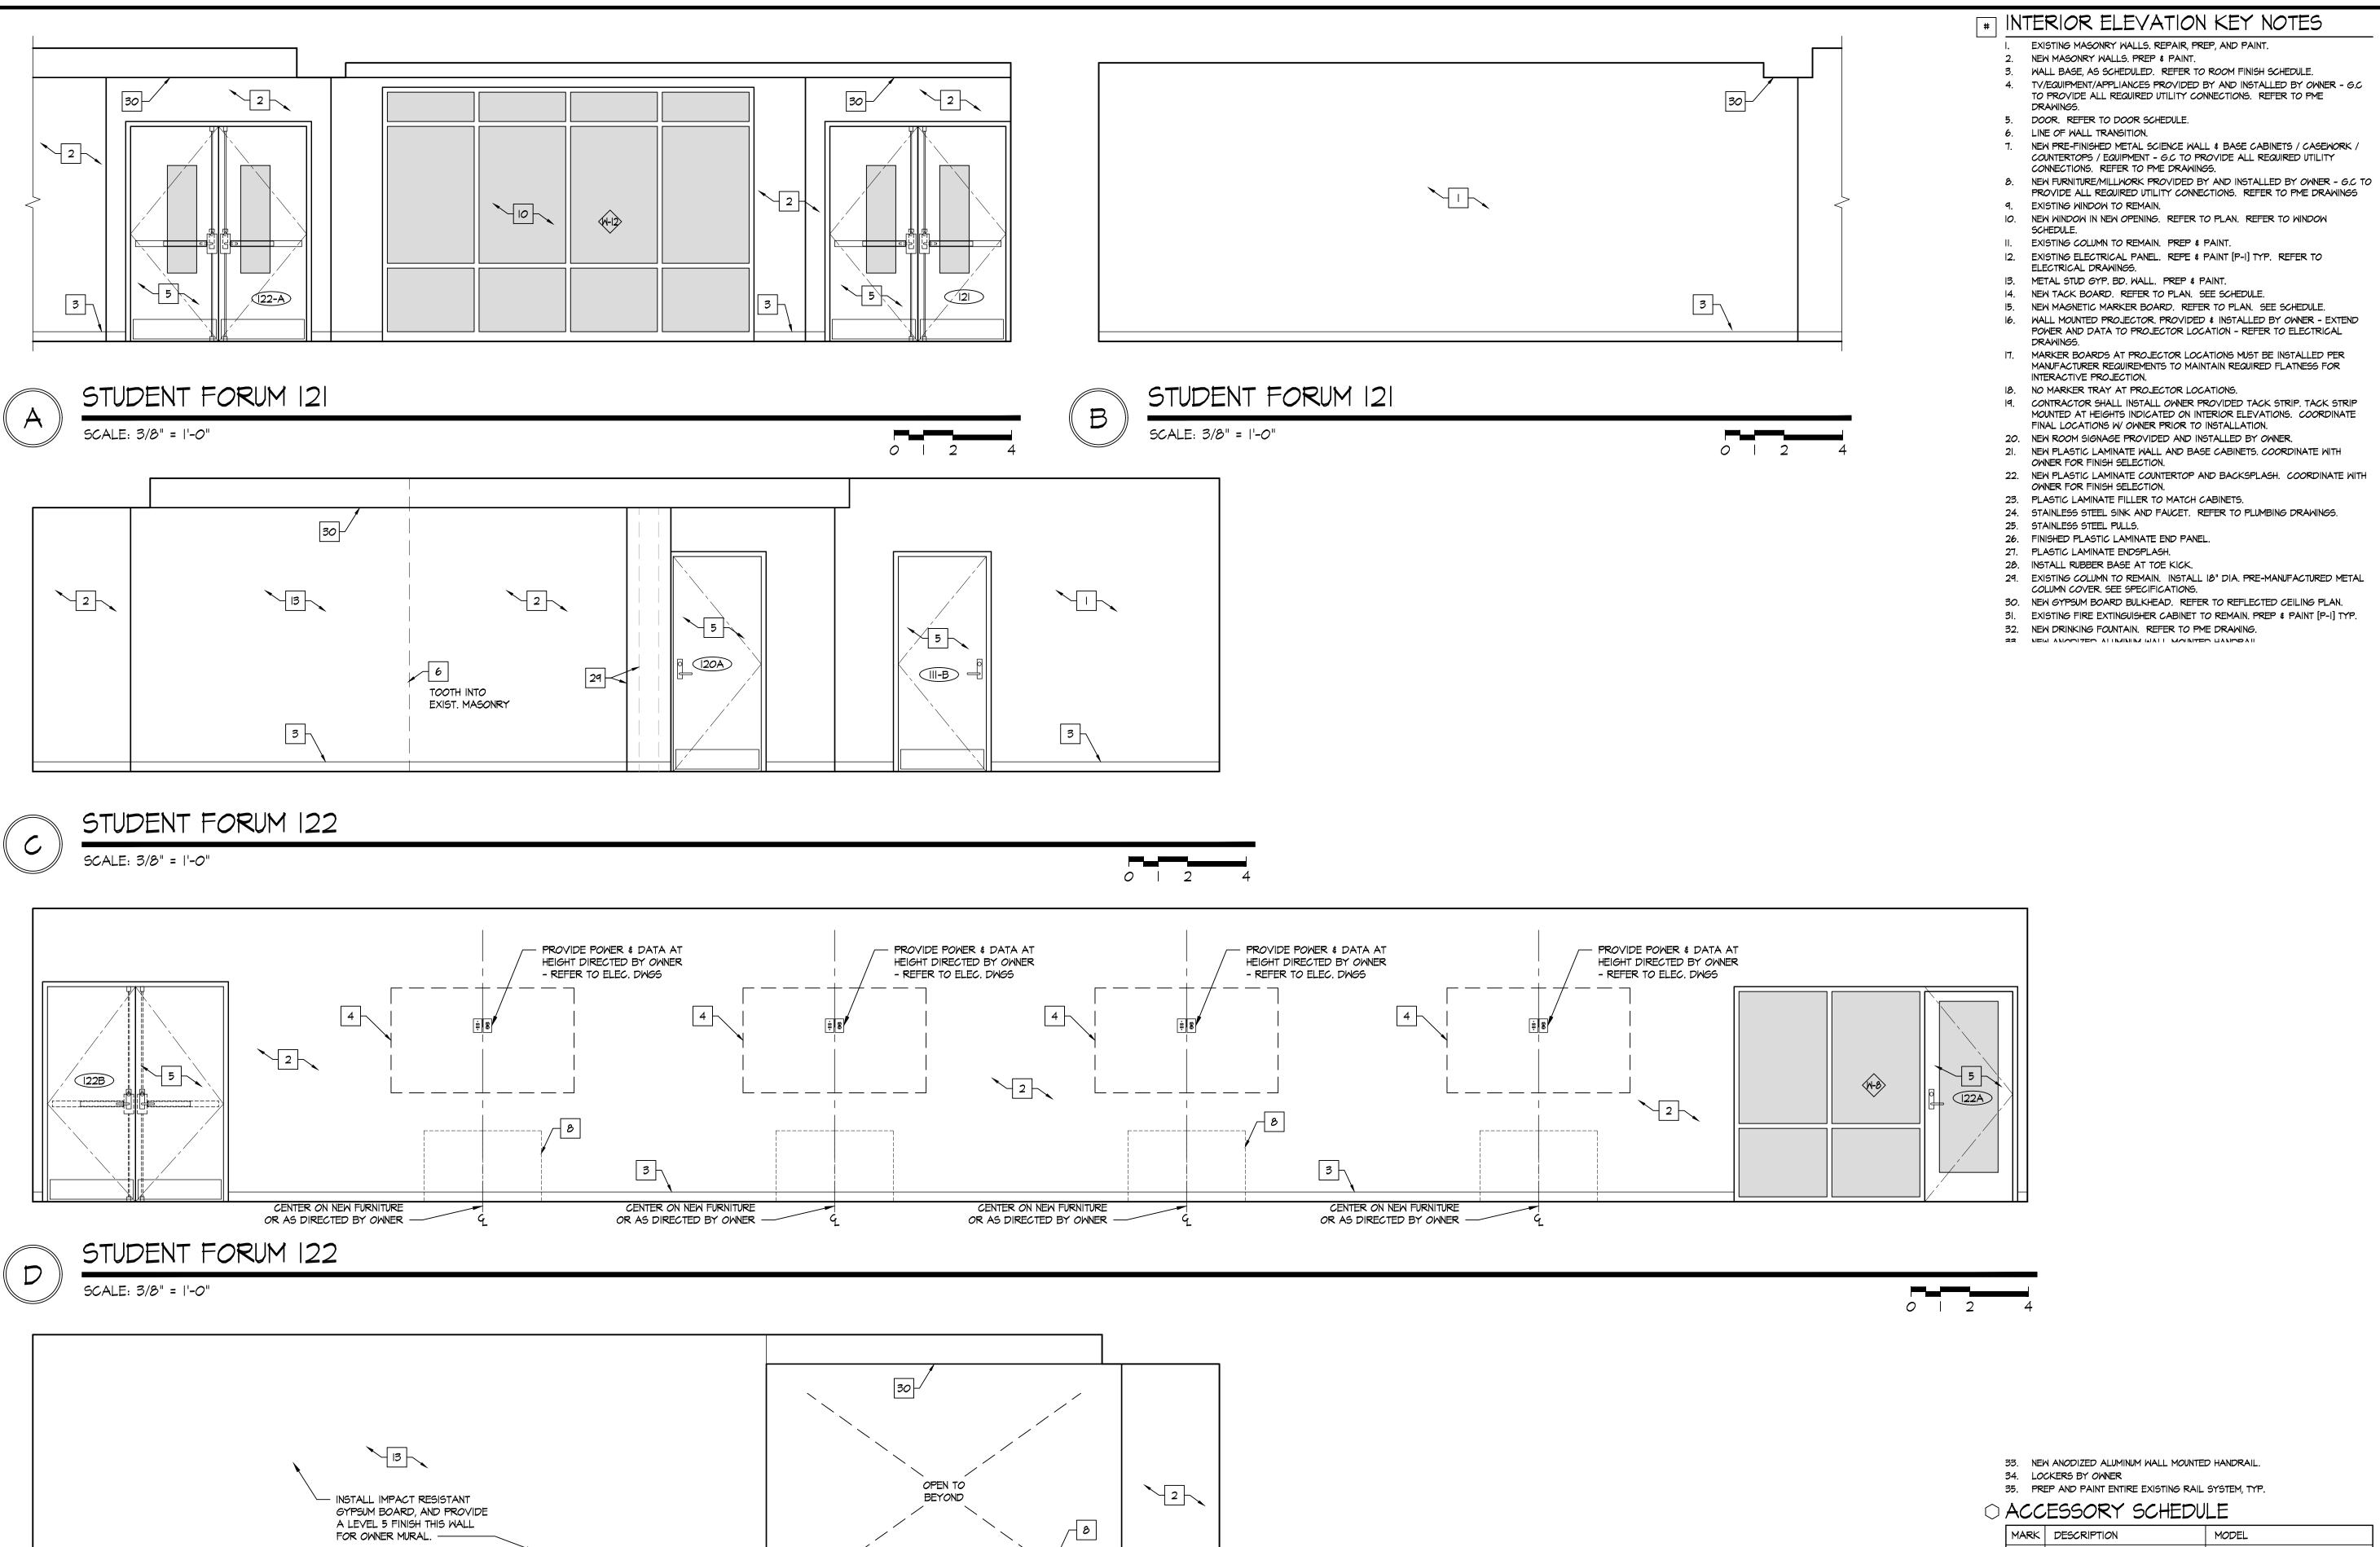

3

STUDENT FORUM 122

SCALE: 3/8" = 1'-0"

33. NEW ANODIZED ALUMINUM WALL MOUNTED HANDRAIL.

35. PREP AND PAINT ENTIRE EXISTING RAIL SYSTEM, TYP.

MARK	DESCRIPTION	MODEL
Α	SOAP DISPENSER	PROVIDE BY OWNER / INST. BY CONT.
æ	PAPER TOWEL DISPENSER	PROVIDE BY OWNER / INST. BY CONT.

ALL SHALL BE STAINLESS STEEL FINISH.

FIELD COORDINATE ALL ACCESSORY LOCATIONS, CONFORM TO ALL ACCESSIBILITY INSTALLATION REQUIREMENTS.

• PROVIDE AND INSTALL FRT BLOCKING AS REQUIRED FOR ALL ACCESSORIES.

GENERAL INTERIOR NOTES

REPAIR EX. CMU AS REQ'D AT EXISTING WALLS. 2. NOMINAL CABINET SIZES INDICATED. VERIFY & PROVIDE ALL REQUIRED FILLERS, ETC. FOR CASEMORK TO ALLOW PROPER OPERATION OF DOORS &

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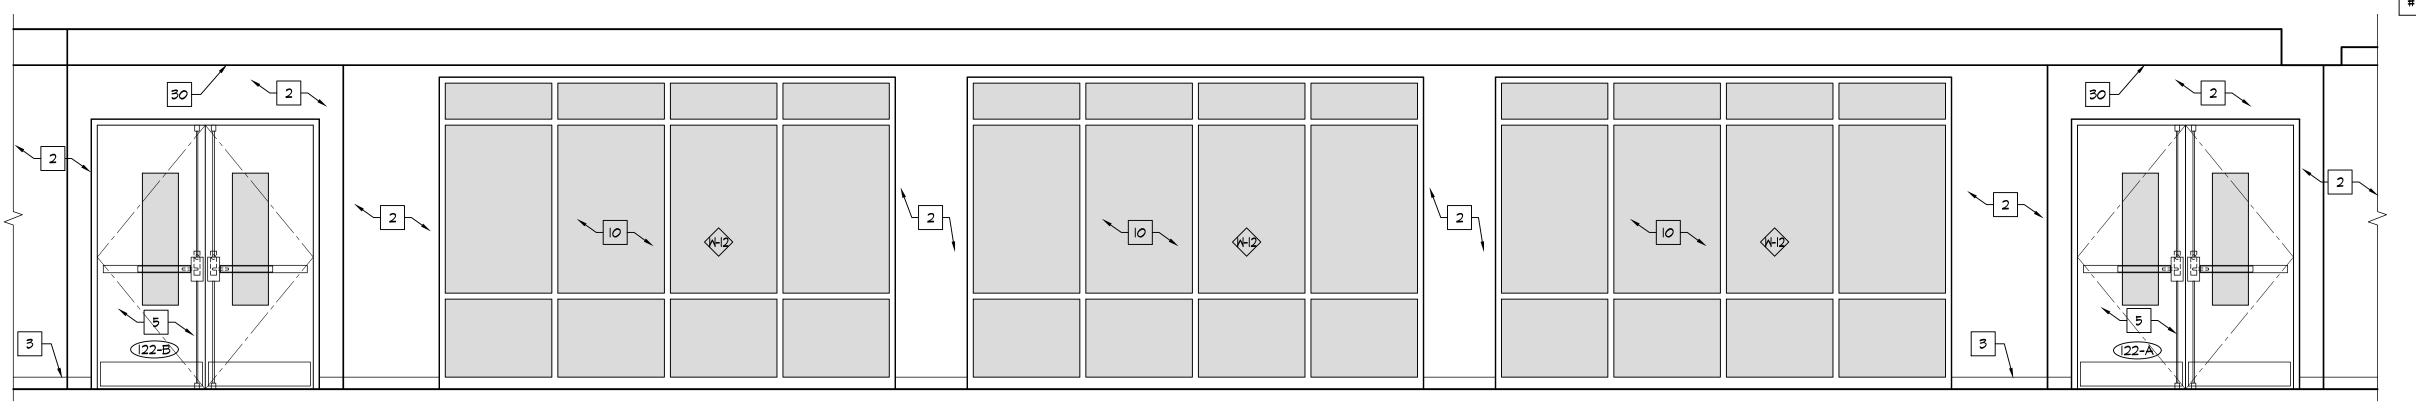
Date

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Sheet Title


STUDENT FORUM 121 INTERIOR ELEVATIONS


Sheet Number



STUDENT FORUM 122

SCALE: 3/8" = 1'-0"

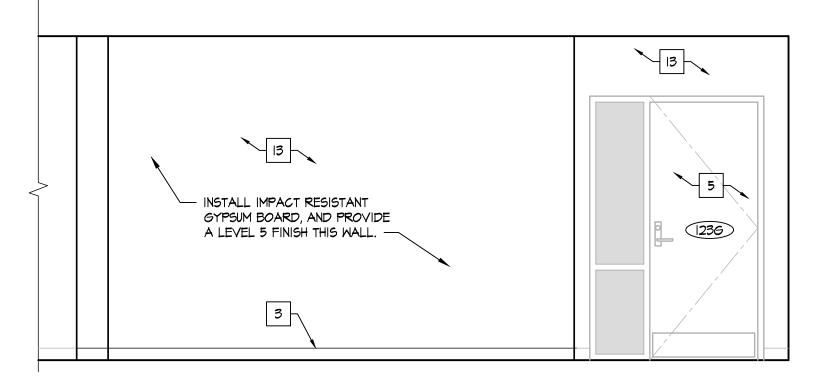


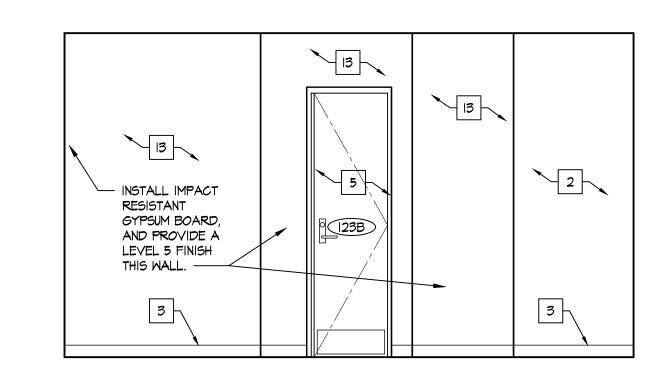




COUNSELING OFFICE 123


SCALE: 3/8" = 1'-0"

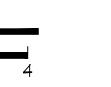

COUNSELING OFFICE 123

SCALE: 3/8" = 1'-0"

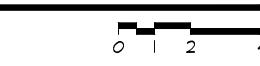


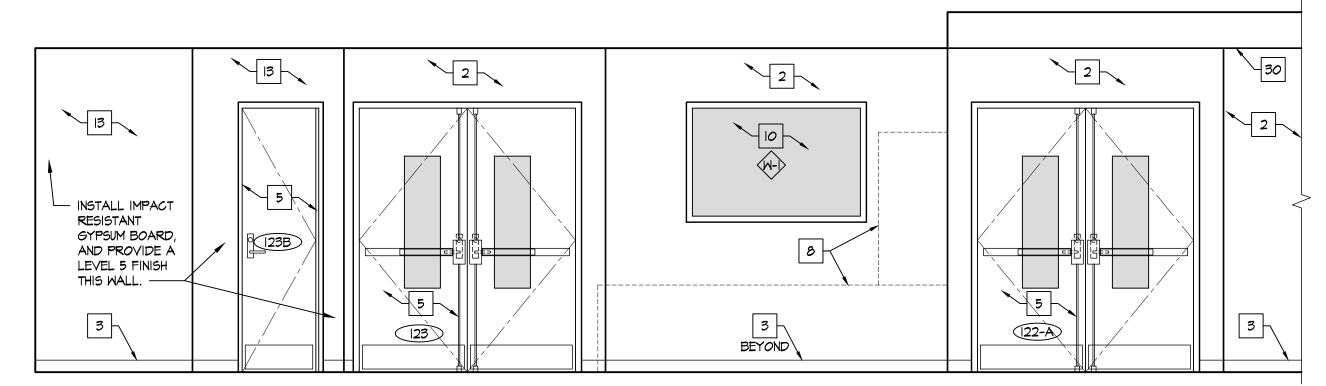





COUNSELING OFFICE 123

SCALE: 3/8" = 1'-0"

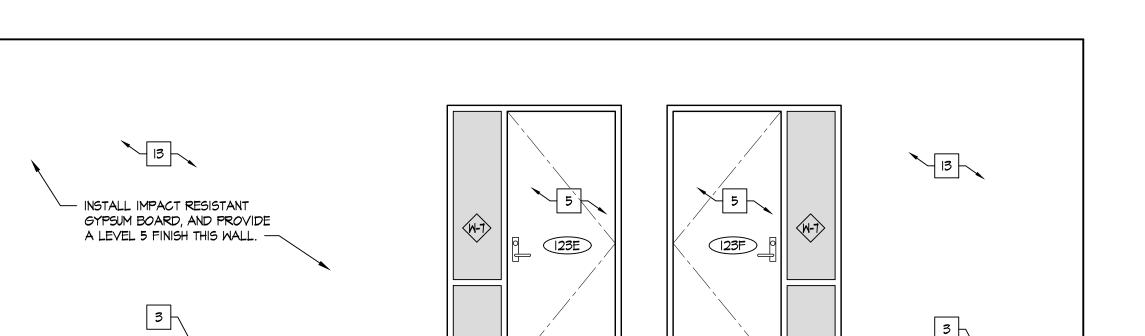

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CORRIDOR 123A

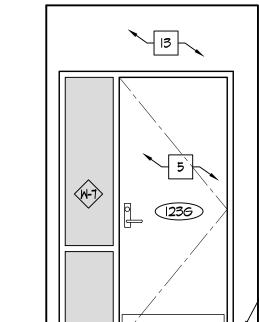13

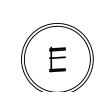SCALE: 3/8" = 1'-0"

CORRIDOR 123A

| INTERIOR ELEVATION KEY NOTES

EXISTING MASONRY WALLS. REPAIR, PREP, AND PAINT.

NEW MASONRY WALLS. PREP & PAINT.

3. WALL BASE, AS SCHEDULED. REFER TO ROOM FINISH SCHEDULE. 4. TY/EQUIPMENT/APPLIANCES PROVIDED BY AND INSTALLED BY OWNER - G.C TO PROVIDE ALL REQUIRED UTILITY CONNECTIONS. REFER TO PME DRAWINGS.

5. DOOR. REFER TO DOOR SCHEDULE.

6. LINE OF WALL TRANSITION.

7. NEW PRE-FINISHED METAL SCIENCE WALL & BASE CABINETS / CASEWORK / COUNTERTOPS / EQUIPMENT - G.C TO PROVIDE ALL REQUIRED UTILITY CONNECTIONS. REFER TO PME DRAWINGS.

8. NEW FURNITURE/MILLWORK PROVIDED BY AND INSTALLED BY OWNER - G.C TO PROVIDE ALL REQUIRED UTILITY CONNECTIONS. REFER TO PME DRAWINGS 9. EXISTING WINDOW TO REMAIN.

IO. NEW WINDOW IN NEW OPENING. REFER TO PLAN. REFER TO WINDOW

SCHEDULE. II. EXISTING COLUMN TO REMAIN. PREP & PAINT.

12. EXISTING ELECTRICAL PANEL. REPE & PAINT [P-I] TYP. REFER TO ELECTRICAL DRAWINGS.

13. METAL STUD GYP. BD. WALL. PREP & PAINT.

14. NEW TACK BOARD. REFER TO PLAN. SEE SCHEDULE. 15. NEW MAGNETIC MARKER BOARD. REFER TO PLAN. SEE SCHEDULE. 16. WALL MOUNTED PROJECTOR. PROVIDED & INSTALLED BY OWNER - EXTEND

POWER AND DATA TO PROJECTOR LOCATION - REFER TO ELECTRICAL 17. MARKER BOARDS AT PROJECTOR LOCATIONS MUST BE INSTALLED PER

MANUFACTURER REQUIREMENTS TO MAINTAIN REQUIRED FLATNESS FOR INTERACTIVE PROJECTION.

18. NO MARKER TRAY AT PROJECTOR LOCATIONS.

19. CONTRACTOR SHALL INSTALL OWNER PROVIDED TACK STRIP. TACK STRIP MOUNTED AT HEIGHTS INDICATED ON INTERIOR ELEVATIONS. COORDINATE FINAL LOCATIONS W/ OWNER PRIOR TO INSTALLATION. 20. NEW ROOM SIGNAGE PROVIDED AND INSTALLED BY OWNER.

21. NEW PLASTIC LAMINATE WALL AND BASE CABINETS. COORDINATE WITH OWNER FOR FINISH SELECTION. 22. NEW PLASTIC LAMINATE COUNTERTOP AND BACKSPLASH. COORDINATE WITH

OWNER FOR FINISH SELECTION. 23. PLASTIC LAMINATE FILLER TO MATCH CABINETS.

24. STAINLESS STEEL SINK AND FAUCET. REFER TO PLUMBING DRAWINGS.

25. STAINLESS STEEL PULLS.

26. FINISHED PLASTIC LAMINATE END PANEL.

27. PLASTIC LAMINATE ENDSPLASH. 28. INSTALL RUBBER BASE AT TOE KICK.

29. EXISTING COLUMN TO REMAIN. INSTALL 18" DIA. PRE-MANUFACTURED METAL COLUMN COVER. SEE SPECIFICATIONS.

30. NEW GYPSUM BOARD BULKHEAD. REFER TO REFLECTED CEILING PLAN.

31. EXISTING FIRE EXTINGUISHER CABINET TO REMAIN. PREP & PAINT [P-I] TYP. 32. NEW DRINKING FOUNTAIN. REFER TO PME DRAWING.

33. NEW ANODIZED ALUMINUM WALL MOUNTED HANDRAIL.

34. LOCKERS BY OWNER 35. PREP AND PAINT ENTIRE EXISTING RAIL SYSTEM, TYP.

○ ACCESSORY SCHEDULE

MARK	DESCRIPTION	MODEL
Α	SOAP DISPENSER	PROVIDE BY OWNER / INST. BY CONT.
В	PAPER TOWEL DISPENSER	PROVIDE BY OWNER / INST. BY CONT.

ALL SHALL BE STAINLESS STEEL FINISH.

FIELD COORDINATE ALL ACCESSORY LOCATIONS, CONFORM TO ALL ACCESSIBILITY INSTALLATION REQUIREMENTS.

• PROVIDE AND INSTALL FRT BLOCKING AS REQUIRED FOR ALL ACCESSORIES.

GENERAL INTERIOR NOTES

I. REPAIR EX. CMU AS REQ'D AT EXISTING WALLS.

2. NOMINAL CABINET SIZES INDICATED. VERIFY & PROVIDE ALL REQUIRED FILLERS, ETC. FOR CASEMORK TO ALLOW PROPER OPERATION OF DOORS & DRAWERS, TYPICAL.

3. GC TO PROVIDE AND INSTALL ALL FRT BLOCKING AS REQUIRED FOR ALL CABINETS, SHELVES, ACCESSORIES, ETC.

GROUP ARCHITECTS 7945 Washingtor Woods Drive Dayton, Ohio 45459 O: 937.610.3440 F: 937.610.3441 OF C JONATHAN ROBERT SCHAAF 14503 Jonathan Robert Schaaf #14503 Expiration Date 12/31/2023

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Sheet Title

STUDENT FORUM 122 INTERIOR ELEVATIONS

Sheet Number



33. NEW ANODIZED ALUMINUM WALL MOUNTED HANDRAIL.

35. PREP AND PAINT ENTIRE EXISTING RAIL SYSTEM, TYP.

34. LOCKERS BY OWNER

ACCESSORY SCHEDULE

\sim			30 n L D 0	
	MARK	DESCRIPTION		MODEL

MARK	DESCRIPTION	MODEL
Α	SOAP DISPENSER	PROVIDE BY OWNER / INST. BY CONT.
В	PAPER TOWEL DISPENSER	PROVIDE BY OWNER / INST. BY CONT.

ALL SHALL BE STAINLESS STEEL FINISH.


FIELD COORDINATE ALL ACCESSORY LOCATIONS, CONFORM TO ALL ACCESSIBILITY INSTALLATION REQUIREMENTS.

• PROVIDE AND INSTALL FRT BLOCKING AS REQUIRED FOR ALL ACCESSORIES.

GENERAL INTERIOR NOTES

REPAIR EX. CMU AS REQ'D AT EXISTING WALLS.

2. NOMINAL CABINET SIZES INDICATED. VERIFY & PROVIDE ALL REQUIRED FILLERS, ETC. FOR CASEWORK TO ALLOW PROPER OPERATION OF DOORS &

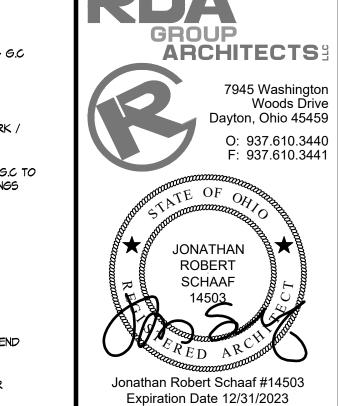

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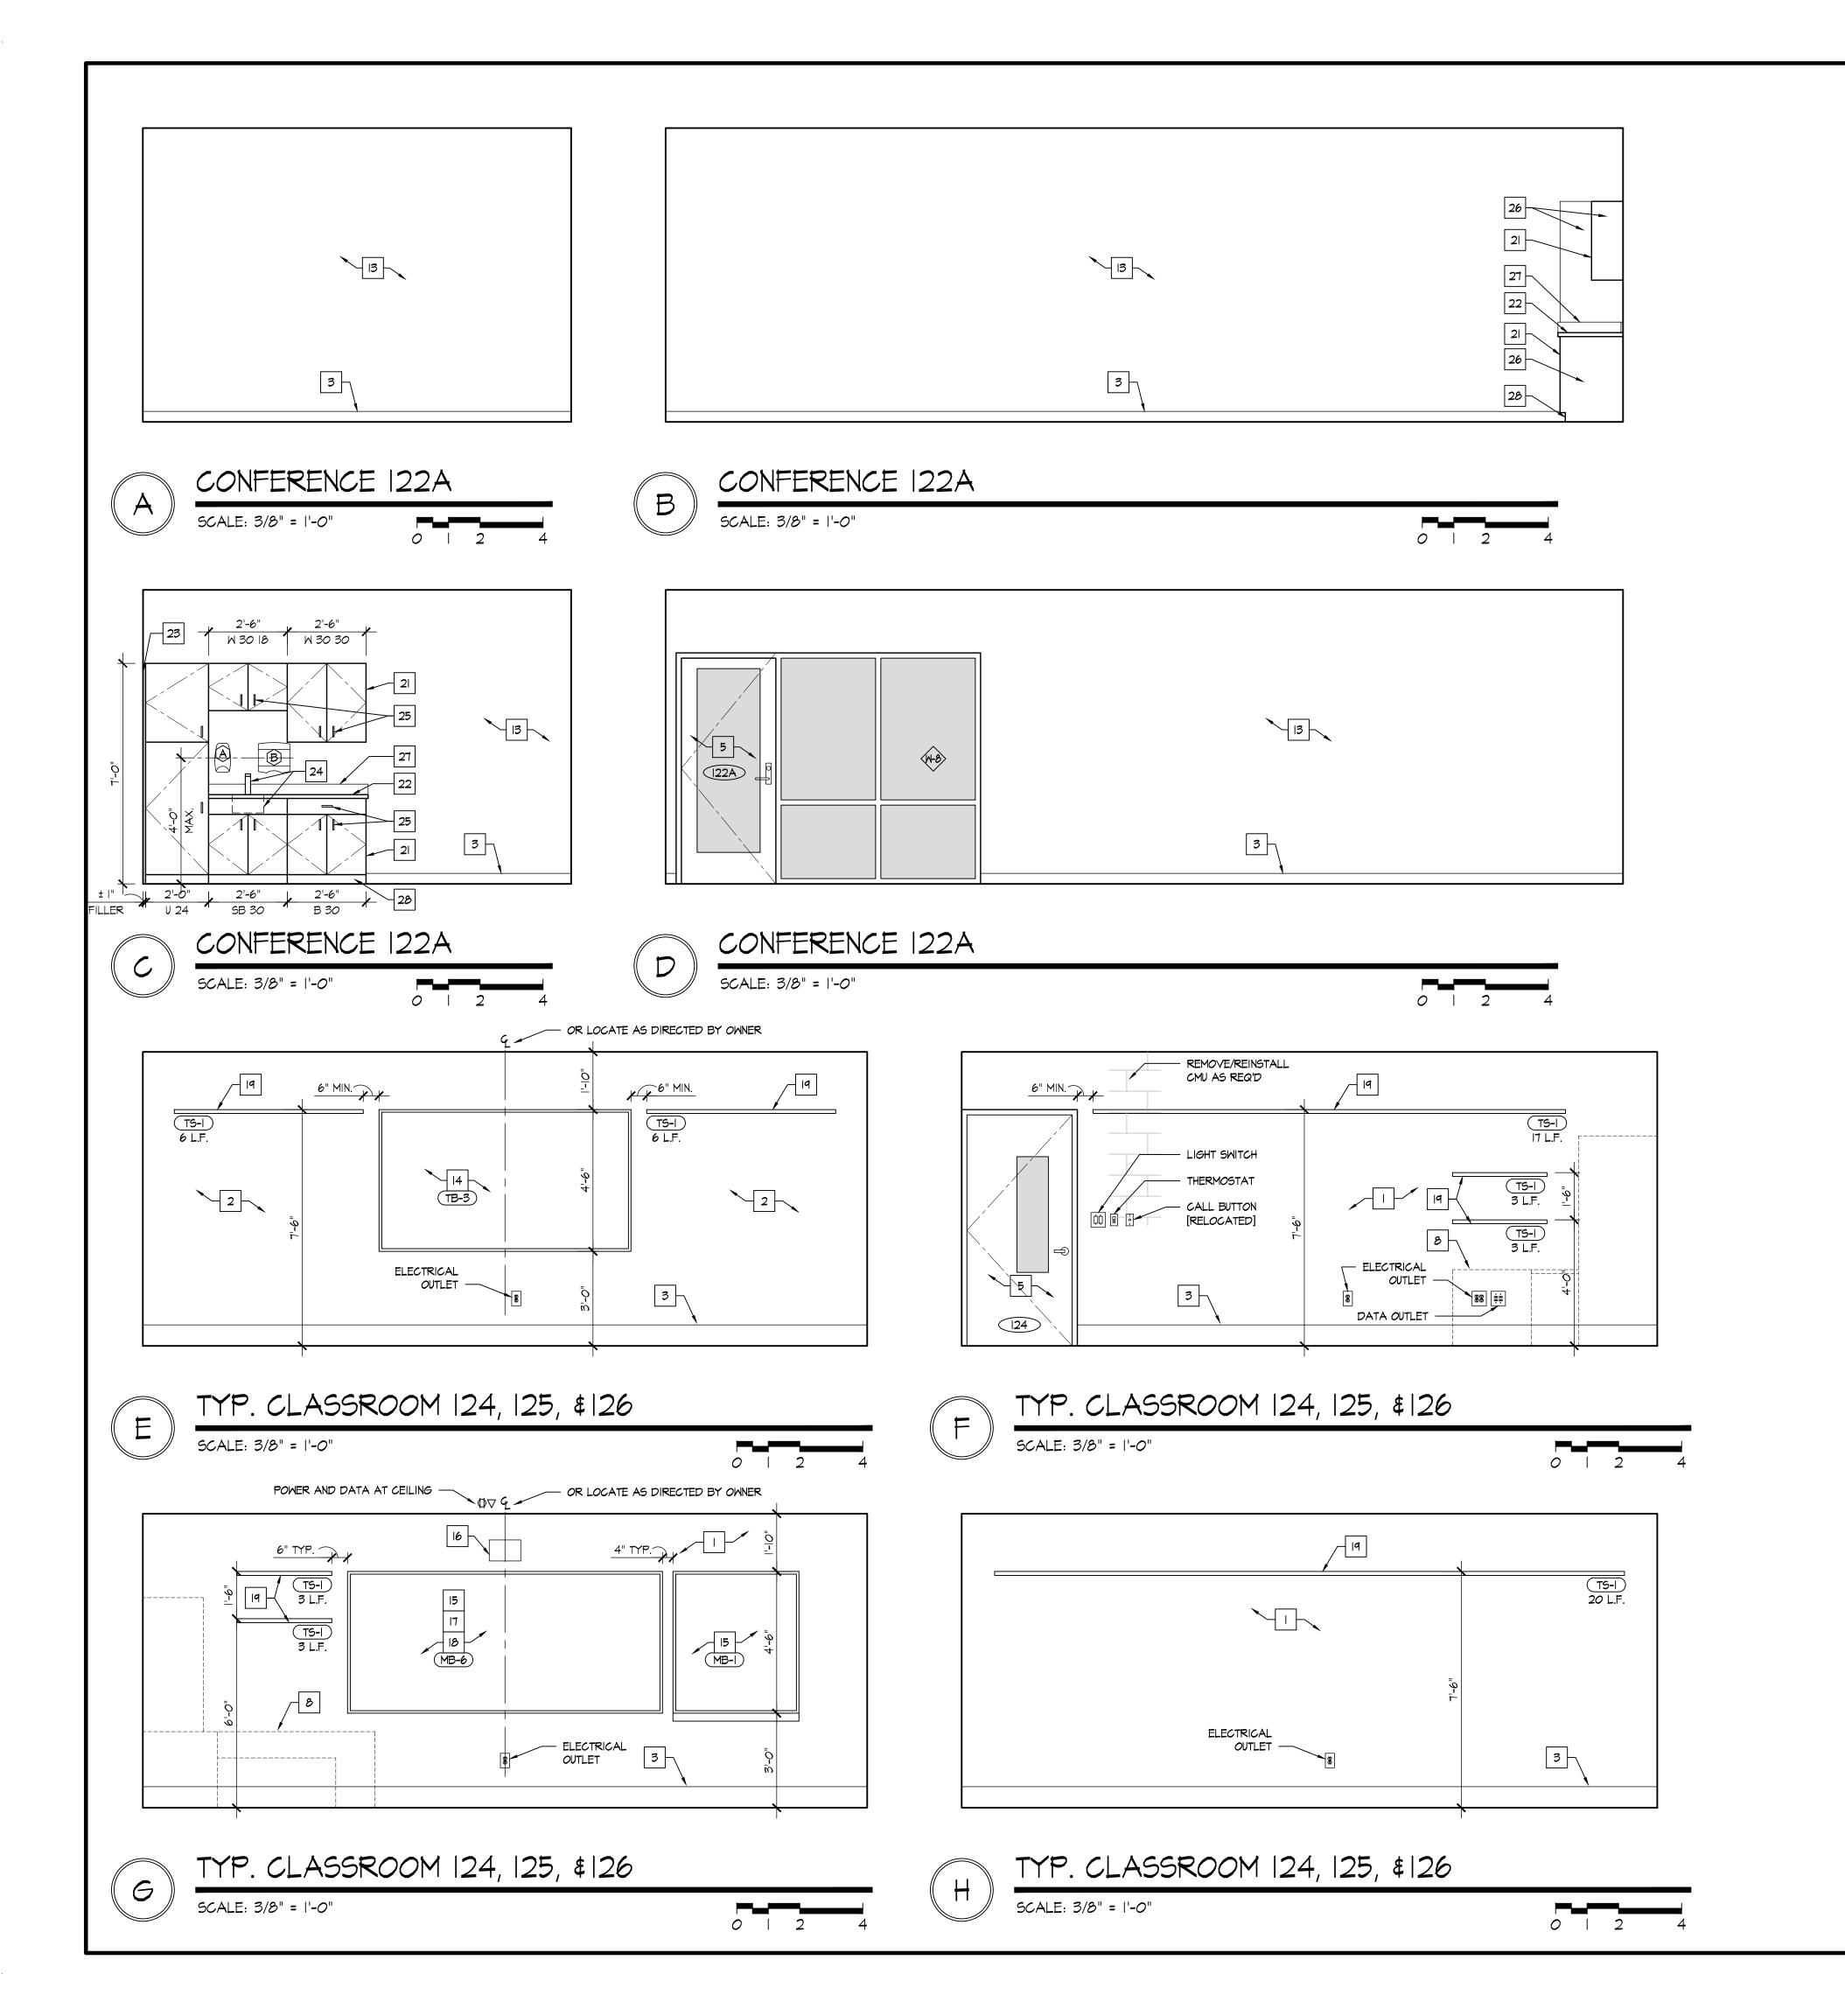
Date

January 24, 2022

Sheet Title

COUNSELING OFFICE | 23 INTERIOR ELEVATIONS

Sheet Number



INTERIOR ELEVATION KEY NOTES

- NEW MASONRY WALLS. PREP & PAINT.
- 3. WALL BASE, AS SCHEDULED. REFER TO ROOM FINISH SCHEDULE. 4. TY/EQUIPMENT/APPLIANCES PROVIDED BY AND INSTALLED BY OWNER - G.C TO PROVIDE ALL REQUIRED UTILITY CONNECTIONS. REFER TO PME
- 5. DOOR. REFER TO DOOR SCHEDULE.
- 6. LINE OF WALL TRANSITION.
- 7. NEW PRE-FINISHED METAL SCIENCE WALL & BASE CABINETS / CASEWORK / COUNTERTOPS / EQUIPMENT - G.C TO PROVIDE ALL REQUIRED UTILITY CONNECTIONS. REFER TO PME DRAWINGS.
- 8. NEW FURNITURE/MILLWORK PROVIDED BY AND INSTALLED BY OWNER G.C TO
- PROVIDE ALL REQUIRED UTILITY CONNECTIONS. REFER TO PME DRAWINGS 9. EXISTING WINDOW TO REMAIN.

IO. NEW WINDOW IN NEW OPENING. REFER TO PLAN. REFER TO WINDOW

- SCHEDULE. II. EXISTING COLUMN TO REMAIN. PREP & PAINT.
- 12. EXISTING ELECTRICAL PANEL. REPE & PAINT [P-I] TYP. REFER TO ELECTRICAL DRAWINGS.
- 13. METAL STUD GYP. BD. WALL. PREP & PAINT.
- 14. NEW TACK BOARD. REFER TO PLAN. SEE SCHEDULE.
- 15. NEW MAGNETIC MARKER BOARD. REFER TO PLAN. SEE SCHEDULE. 16. WALL MOUNTED PROJECTOR. PROVIDED & INSTALLED BY OWNER - EXTEND
- POWER AND DATA TO PROJECTOR LOCATION REFER TO ELECTRICAL 17. MARKER BOARDS AT PROJECTOR LOCATIONS MUST BE INSTALLED PER
- MANUFACTURER REQUIREMENTS TO MAINTAIN REQUIRED FLATNESS FOR INTERACTIVE PROJECTION.
- 18. NO MARKER TRAY AT PROJECTOR LOCATIONS.
- 19. CONTRACTOR SHALL INSTALL OWNER PROVIDED TACK STRIP. TACK STRIP MOUNTED AT HEIGHTS INDICATED ON INTERIOR ELEVATIONS. COORDINATE FINAL LOCATIONS W/ OWNER PRIOR TO INSTALLATION.
- 20. NEW ROOM SIGNAGE PROVIDED AND INSTALLED BY OWNER. 21. NEW PLASTIC LAMINATE WALL AND BASE CABINETS. COORDINATE WITH
- OWNER FOR FINISH SELECTION. 22. NEW PLASTIC LAMINATE COUNTERTOP AND BACKSPLASH. COORDINATE WITH OWNER FOR FINISH SELECTION.
- 23. PLASTIC LAMINATE FILLER TO MATCH CABINETS.
- 24. STAINLESS STEEL SINK AND FAUCET. REFER TO PLUMBING DRAWINGS.
- 25. STAINLESS STEEL PULLS.
- 26. FINISHED PLASTIC LAMINATE END PANEL.
- 27. PLASTIC LAMINATE ENDSPLASH.
- 28. INSTALL RUBBER BASE AT TOE KICK. 29. EXISTING COLUMN TO REMAIN. INSTALL 18" DIA. PRE-MANUFACTURED METAL
- COLUMN COVER. SEE SPECIFICATIONS. 30. NEW GYPSUM BOARD BULKHEAD. REFER TO REFLECTED CEILING PLAN.
- 31. EXISTING FIRE EXTINGUISHER CABINET TO REMAIN. PREP & PAINT [P-I] TYP.
- 32. NEW DRINKING FOUNTAIN. REFER TO PME DRAWING.
- 33. NEW ANODIZED ALUMINUM WALL MOUNTED HANDRAIL. 34. LOCKERS BY OWNER
- 35. PREP AND PAINT ENTIRE EXISTING RAIL SYSTEM, TYP.


○ ACCESSORY SCHEDULE

MARK	DESCRIPTION	MODEL
A	SOAP DISPENSER	PROVIDE BY OWNER / INST. BY CONT.
В	PAPER TOWEL DISPENSER	PROVIDE BY OWNER / INST. BY CONT.

- ALL SHALL BE STAINLESS STEEL FINISH.
- FIELD COORDINATE ALL ACCESSORY LOCATIONS, CONFORM TO ALL ACCESSIBILITY INSTALLATION REQUIREMENTS.
- PROVIDE AND INSTALL FRT BLOCKING AS REQUIRED FOR ALL ACCESSORIES.

GENERAL INTERIOR NOTES

- REPAIR EX. CMU AS REQ'D AT EXISTING WALLS.
- 2. NOMINAL CABINET SIZES INDICATED. VERIFY & PROVIDE ALL REQUIRED FILLERS, ETC. FOR CASEWORK TO ALLOW PROPER OPERATION OF DOORS
- DRAWERS, TYPICAL. 3. GC TO PROVIDE AND INSTALL ALL FRT BLOCKING AS REQUIRED FOR ALL CABINETS, SHELVES, ACCESSORIES, ETC.

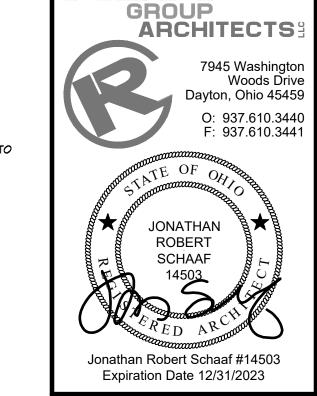

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2021-203


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Project Number

Sheet Title

CONFERENCE | 25A \$ OFFICE | 25B INTERIOR **ELEVATIONS**

Sheet Number

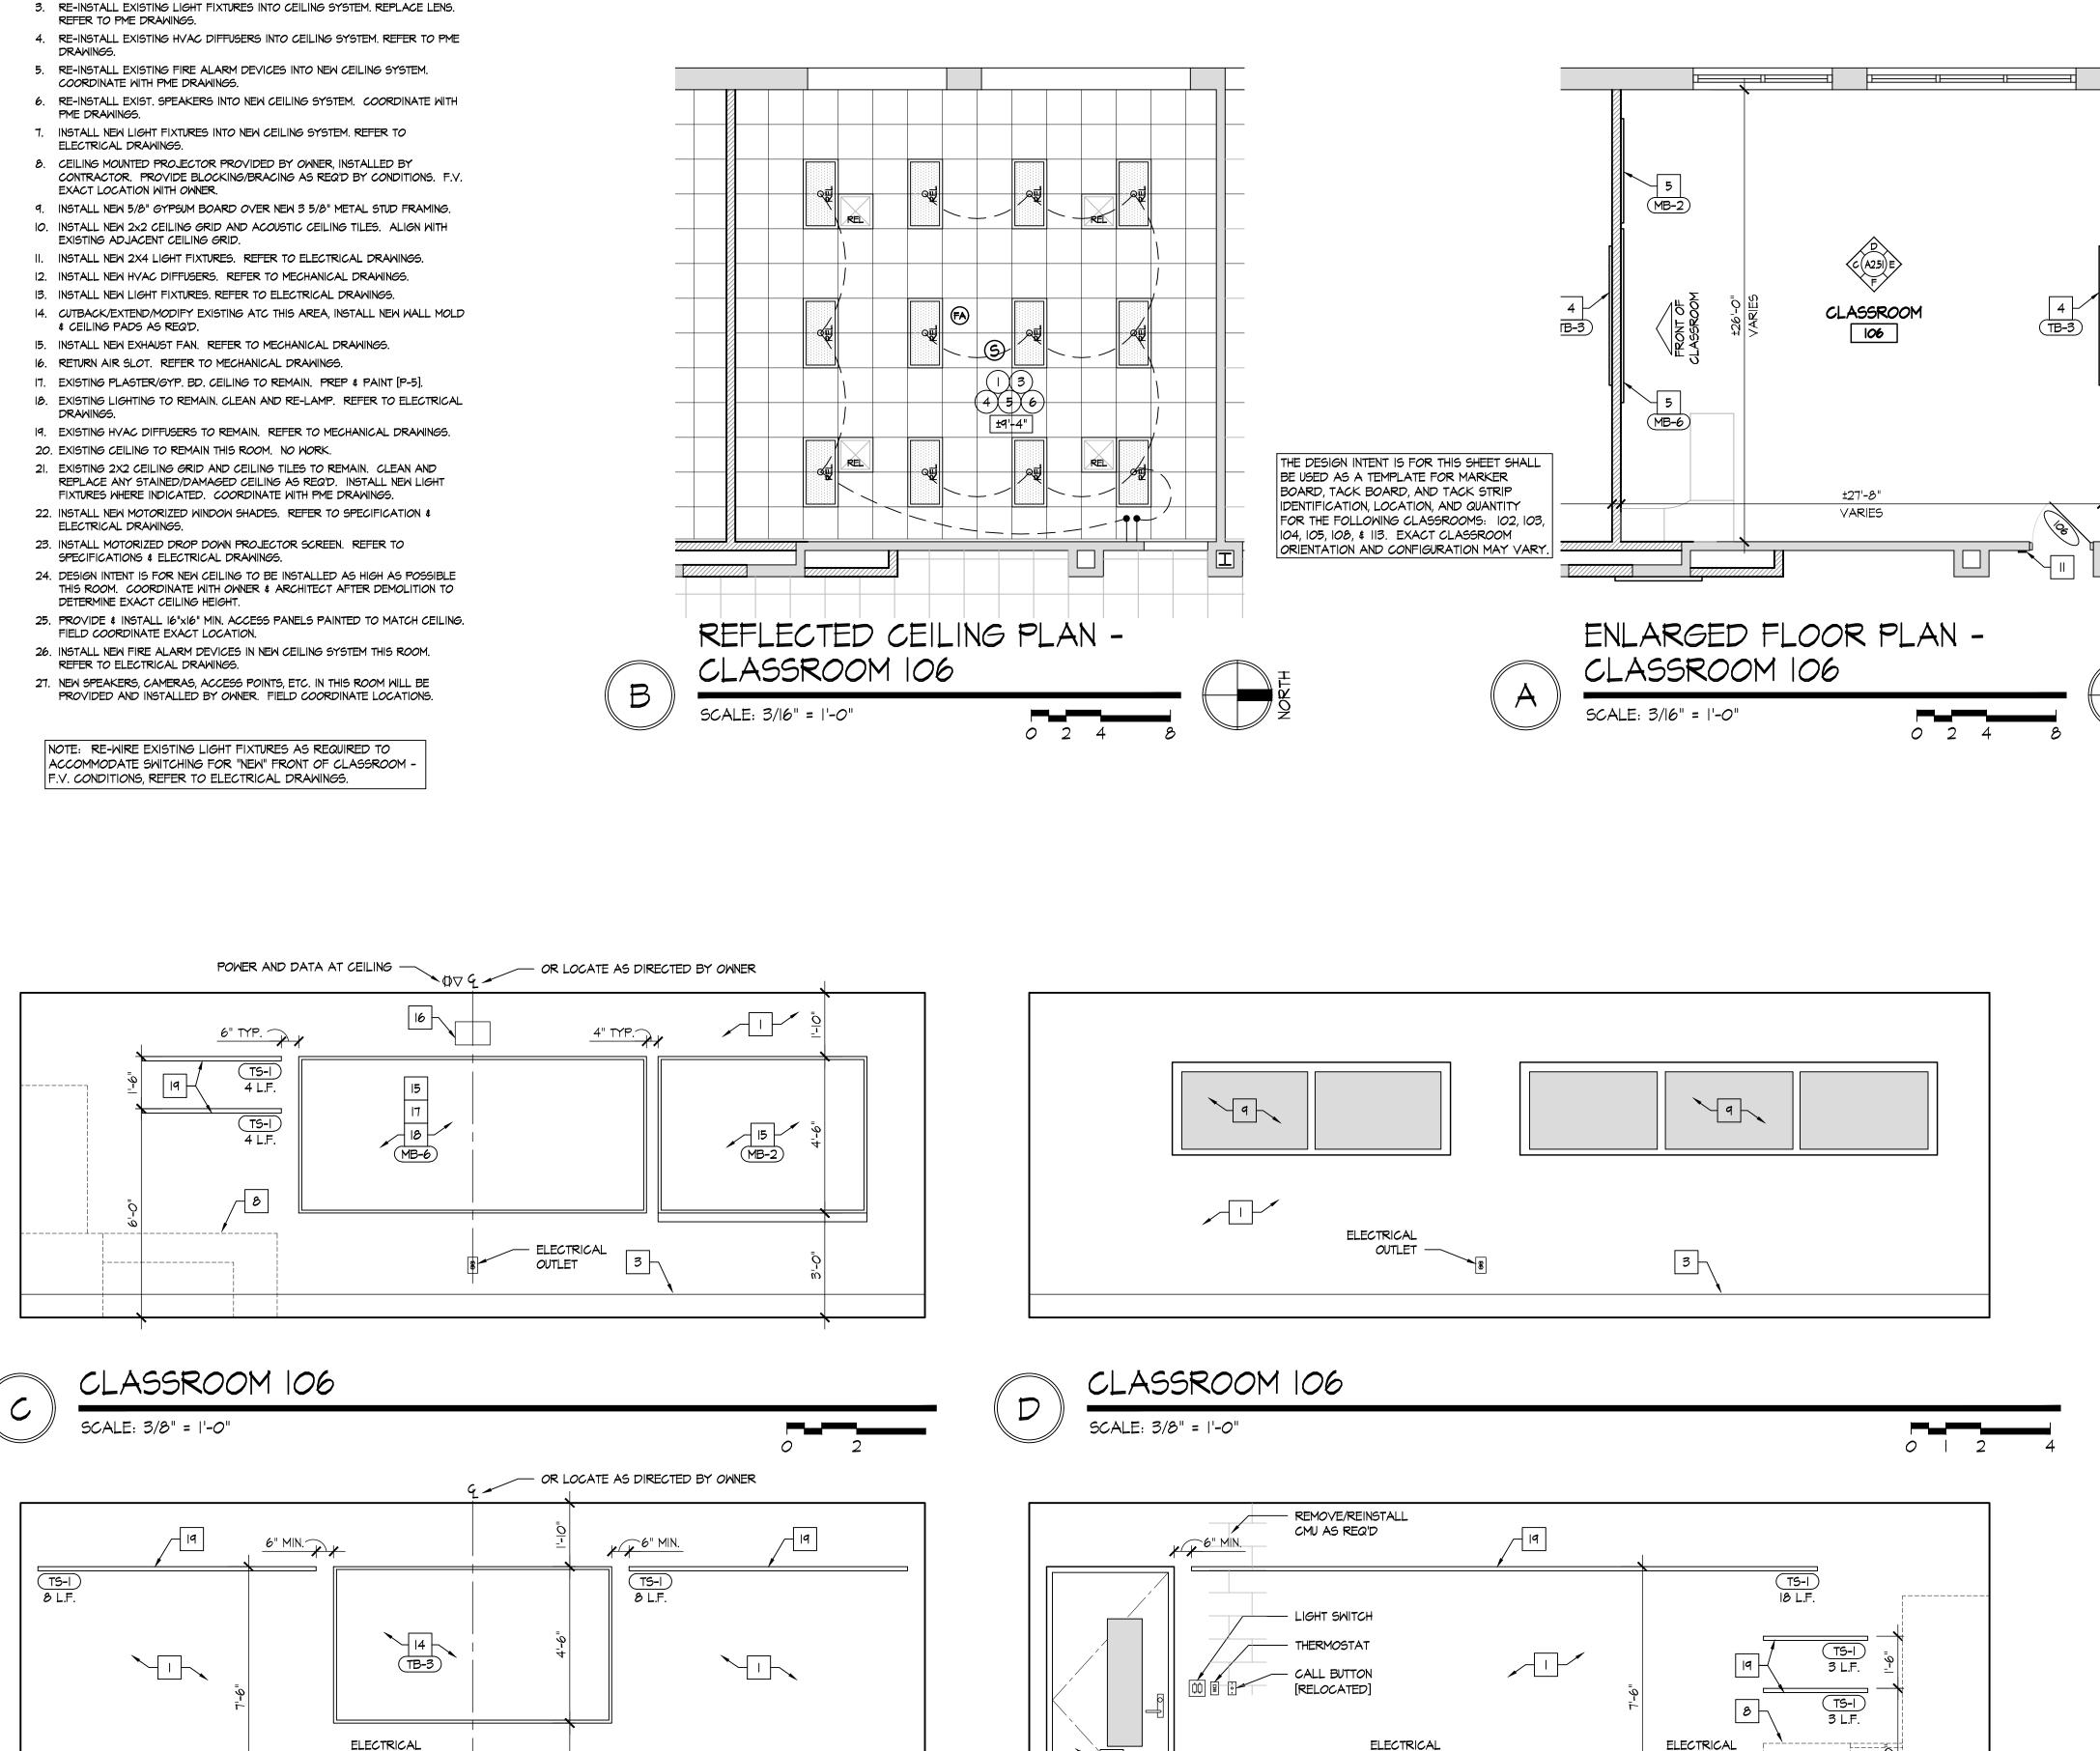

(#) REFLECTED CEILING KEY NOTES


INSTALL NEW 2x2 CEILING GRID AND ACOUSTIC CEILING TILES. REFER TO PLAN

2. EXISTING 2x4 CEILING GRID. INSTALL NEW GRID TEE. PAINT NEW & EXISTING

CEILING GRID. INSTALL NEW 2x2 ACOUSTIC CEILING TILES.

CLASSROOM 106

SCALE: 3/8" = 1'-0"

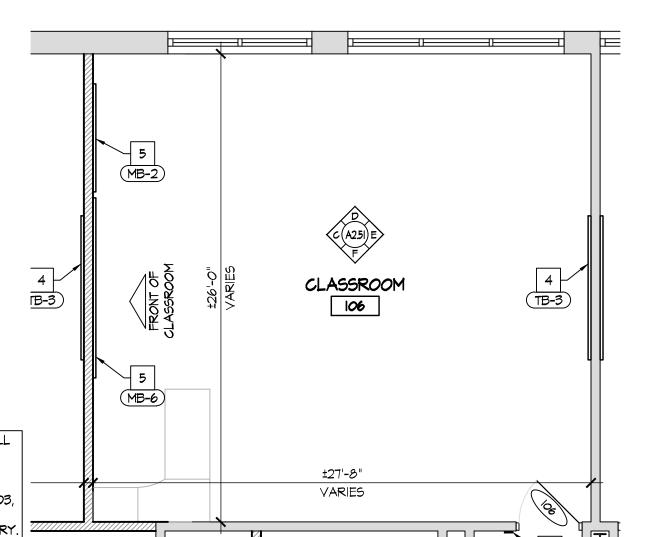

OUTLET

DATA OUTLET

OUTLET

3

CLASSROOM 106

SCALE: 3/8" = 1'-0"

106

NEW CONSTRUCTION KEY NOTES

EXISTING SOLID CORE WOOD DOOR AND HOLLOW METAL FRAME TO REMAIN. REPAIR & RE-FINISH EX. WOOD DOOR SLAB AND INSTALL NEW HARDWARE AS SPECIFIED. REFER TO DOOR SCHEDULE AND SPECIFICATIONS.

2. INSTALL NEW DOOR AND FRAME IN NEW OPENING. REFER TO DOOR SCHEDULE. 3. INSTALL NEW DOOR AND FRAME IN EXISTING OPENING. REFER TO DOOR

4. INSTALL NEW WINDOW IN NEW OPENING. REFER TO WINDOW SCHEDULE.

5. INSTALL NEW TACKBOARD. SEE SCHEDULE. 6. INSTALL NEW MAGNETIC MARKER BOARD. SEE SCHEDULE.

7. INFILL EXISTING OPENING W/ CMU, TOOTH INTO EXISTING, MATCH EX. EACH SIDE. 8. NO WORK THIS AREA.

9. INSTALL NEW HIGH-LOW DRINKING FOUNTAIN WITH BOTTLE FILLER. REFER TO PLUMBING DRAWINGS.

IO. INSTALL NEW LOW DRINKING FOUNTAIN WITH BOTTLE FILLER. REFER TO PLUMBING DRAWINGS.

II. INSTALL NEW ROOM SIGNAGE PROVIDED AND INSTALLED BY OWNER. 12. INSTALL NEW PARTITION WALL, REFER TO WALL TYPES.

13. NEW CASEMORK - SEE INTERIOR ELEVATIONS

14. FURNITURE & EQUIPMENT PROVIDED BY AND INSTALLED BY OWNER - G.C TO PROVIDE ALL REQUIRED UTILITY CONNECTIONS. REFER TO PME DRAWINGS

15. NEW LOCKERS & BLOCKING BY OWNER, SET ON NEW/EXISTING LOCKER BASES. REFER TO INTERIOR ELEVATIONS.

16. INSTALL NEW STOREFRONT SYSTEM AND DOOR. REFER TO WINDOW & DOOR

17. WALL MOUNTED TV/DISPLAY BY OWNER - INSTALLED BY CONTRACTOR,

PROVIDE POWER/DATA - REFER TO ELECTRICAL DRAWINGS. 18. EXISTING DOOR AND HOLLOW METAL FRAME TO REMAIN. METAL DOORS: REPAIR, PREP, PAINT DOOR & FRAME AND INSTALL NEW HARDWARE AS SPECIFIED; WOOD DOORS: REPAIR, PREP, PAINT FRAME & INSTALL NEW

19. PREP AND PAINT EXISTING WALLS IN CONTROL ROOM [P-6]. REMOVE EXISTING FLOORING AND INSTALL NEW CARPET [F-6].

HARDWARE AS SPECIFIED. REFER TO DOOR SCHEDULE AND SPECIFICATIONS.

20. INSTALL WALL COVERING [WC-I] ON EX. GYP. BD. WALL TO 36" A.F.F. 21. INSTALL WALL COVERING [WC-I] FULL HEIGHT TO UNDERSIDE OF CEILING AT

EMERGENCY SHOWER. INSTALL STAINLESS STEEL WALL CAP FULL HEIGHT. 22. NEW LOCKERS & BLOCKING BY OWNER, EXISTING LOCKER BASES TO REMAIN.

23. EXISTING ELECTRICAL PANEL. REFER TO ELECTRICAL DRAWINGS.

24. EXISTING FIRE EXTINGUISHER CABINET TO REMAIN. PROTECT DURING CONSTRUCTION.

25. REPAIR EXISTING WALL AS REQ'D.

26. EXISTING CASEWORK & EQUIPMENT TO REMAIN. PROTECT DURING CONSTRUCTION.

27. INSTALL 18" DIA. PRE-MANUFACTURED METAL COLUMN COVER. SEE SPECIFICATIONS. REFER TO B/A2.41.

REFER TO DIMENSIONED FLOOR PLAN SHEET AI.12. REFER TO SHEET GI.4 FOR WALL TYPES.

INTERIOR ELEVATION KEY NOTES

EXISTING MASONRY WALLS. REPAIR, PREP, AND PAINT.

NEW MASONRY WALLS. PREP \$ PAINT.

WALL BASE, AS SCHEDULED. REFER TO ROOM FINISH SCHEDULE. 4. TV/EQUIPMENT/APPLIANCES PROVIDED BY AND INSTALLED BY OWNER - G.C

TO PROVIDE ALL REQUIRED UTILITY CONNECTIONS. REFER TO PME DRAWINGS.

DOOR. REFER TO DOOR SCHEDULE.

6. LINE OF WALL TRANSITION.

7. NEW PRE-FINISHED METAL SCIENCE WALL & BASE CABINETS / CASEWORK / COUNTERTOPS / EQUIPMENT - G.C TO PROVIDE ALL REQUIRED UTILITY CONNECTIONS. REFER TO PME DRAWINGS.

8. NEW FURNITURE/MILLWORK PROVIDED BY AND INSTALLED BY OWNER - G.C TO PROVIDE ALL REQUIRED UTILITY CONNECTIONS. REFER TO PME DRAWINGS 9. EXISTING WINDOW TO REMAIN.

10. NEW WINDOW IN NEW OPENING. REFER TO PLAN. REFER TO WINDOW

SCHEDULE. II. EXISTING COLUMN TO REMAIN. PREP & PAINT.

12. EXISTING ELECTRICAL PANEL. REPE & PAINT [P-I] TYP. REFER TO

ELECTRICAL DRAWINGS.

I3. METAL STUD GYP. BD. WALL. PREP & PAINT.

14. NEW TACK BOARD. REFER TO PLAN. SEE SCHEDULE. 15. NEW MAGNETIC MARKER BOARD. REFER TO PLAN. SEE SCHEDULE.

16. WALL MOUNTED PROJECTOR, PROVIDED & INSTALLED BY OWNER - EXTEND POWER AND DATA TO PROJECTOR LOCATION - REFER TO ELECTRICAL

17. MARKER BOARDS AT PROJECTOR LOCATIONS MUST BE INSTALLED PER MANUFACTURER REQUIREMENTS TO MAINTAIN REQUIRED FLATNESS FOR INTERACTIVE PROJECTION.

18. NO MARKER TRAY AT PROJECTOR LOCATIONS

19. CONTRACTOR SHALL INSTALL OWNER PROVIDED TACK STRIP. TACK STRIP MOUNTED AT HEIGHTS INDICATED ON INTERIOR ELEVATIONS. COORDINATE FINAL LOCATIONS W/ OWNER PRIOR TO INSTALLATION.

20. NEW ROOM SIGNAGE PROVIDED AND INSTALLED BY OWNER. 21. NEW PLASTIC LAMINATE WALL AND BASE CABINETS. COORDINATE WITH

OWNER FOR FINISH SELECTION. 22. NEW PLASTIC LAMINATE COUNTERTOP AND BACKSPLASH. COORDINATE WITH

OWNER FOR FINISH SELECTION.

23. PLASTIC LAMINATE FILLER TO MATCH CABINETS.

24. STAINLESS STEEL SINK AND FAUCET. REFER TO PLUMBING DRAWINGS. 25. STAINLESS STEEL PULLS.

26. FINISHED PLASTIC LAMINATE END PANEL.

27. PLASTIC LAMINATE ENDSPLASH.

28. INSTALL RUBBER BASE AT TOE KICK. 29. EXISTING COLUMN TO REMAIN. INSTALL 18" DIA. PRE-MANUFACTURED METAL

COLUMN COVER. SEE SPECIFICATIONS. 30. NEW GYPSUM BOARD BULKHEAD. REFER TO REFLECTED CEILING PLAN.

31. EXISTING FIRE EXTINGUISHER CABINET TO REMAIN. PREP & PAINT [P-I] TYP.

32. NEW DRINKING FOUNTAIN. REFER TO PME DRAWING.

33. NEW ANODIZED ALUMINUM WALL MOUNTED HANDRAIL. 34. LOCKERS BY OWNER

35. PREP AND PAINT ENTIRE EXISTING RAIL SYSTEM, TYP.

O ACCESSORY SCHEDULE

MARK	DESCRIPTION	MODEL
Α	SOAP DISPENSER	PROVIDE BY OWNER / INST. BY CONT
B	PAPER TOWEL DISPENSER	PROVIDE BY OWNER / INST. BY CONT

• ALL SHALL BE STAINLESS STEEL FINISH.

FIELD COORDINATE ALL ACCESSORY LOCATIONS, CONFORM TO ALL ACCESSIBILITY INSTALLATION REQUIREMENTS.

• PROVIDE AND INSTALL FRT BLOCKING AS REQUIRED FOR ALL ACCESSORIES.

GENERAL INTERIOR NOTES

NOMINAL CABINET SIZES INDICATED. VERIFY & PROVIDE ALL REQUIRED

REPAIR EX. CMU AS REQ'D AT EXISTING WALLS. FILLERS, ETC. FOR CASEWORK TO ALLOW PROPER OPERATION OF DOORS \$

3 OF TO PROVIDE AND INSTALL ALL FREE BLOCKING AS RECHIRED FOR ALL

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Expiration Date 12/31/2023

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01/24/22 BID SET/ CONSTRUCTION

Project Number

2021-203


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January 24, 2022


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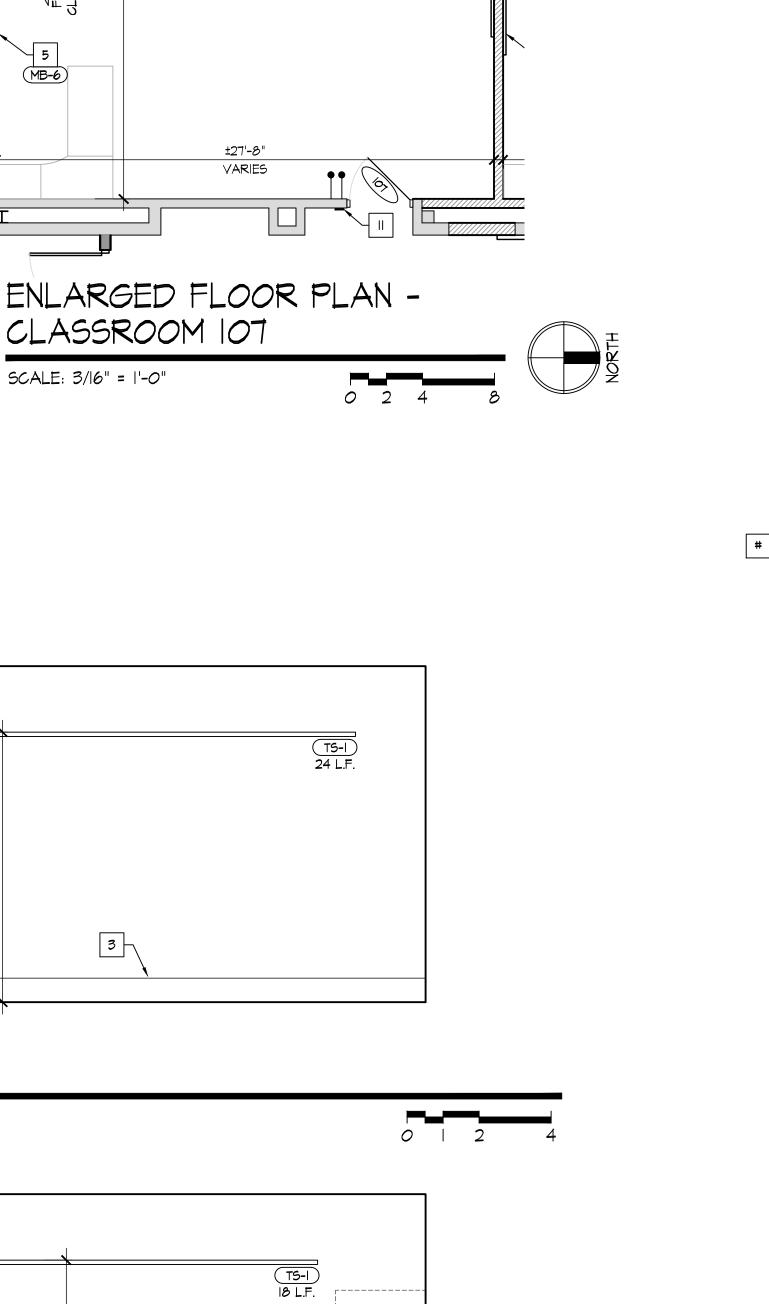
ENLARGED CLASSROOM 106 PLANS


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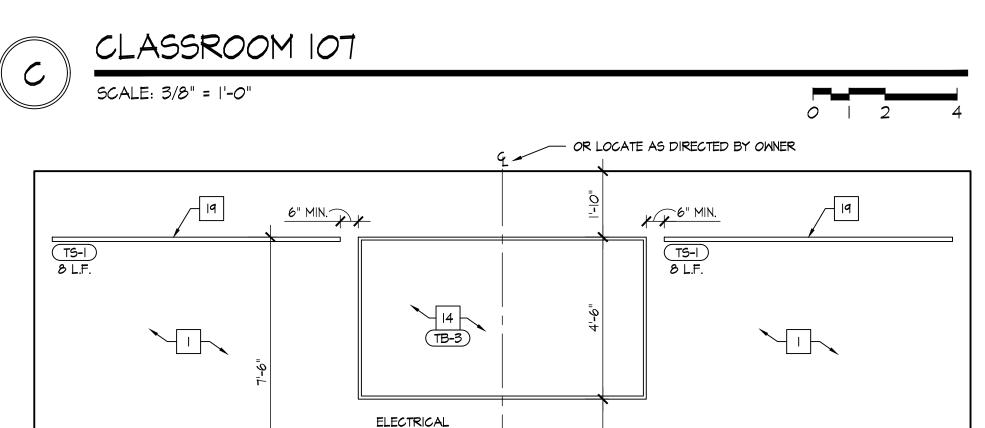


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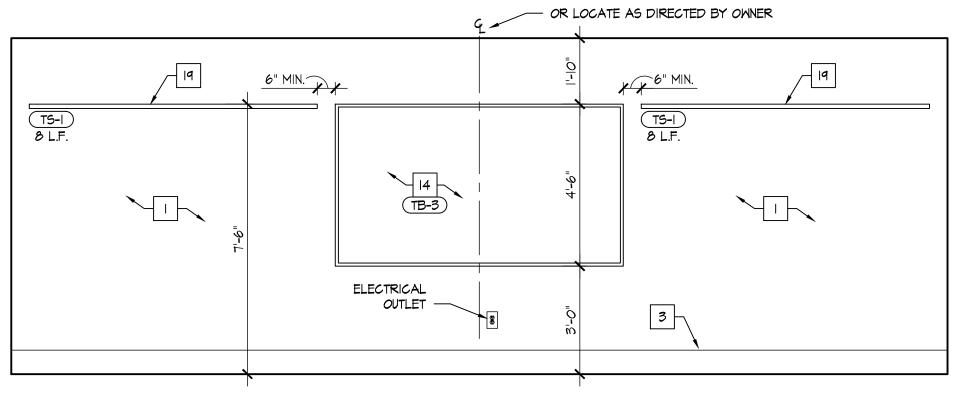
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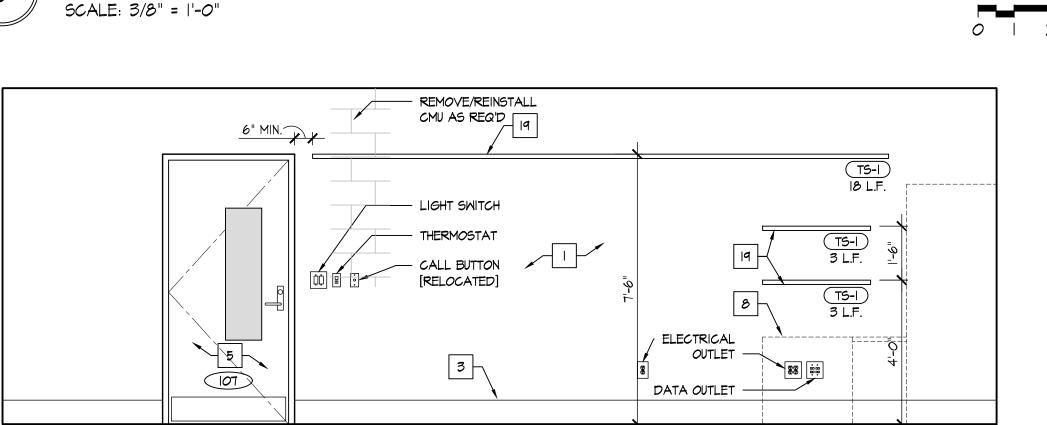
OUTLET

/ B

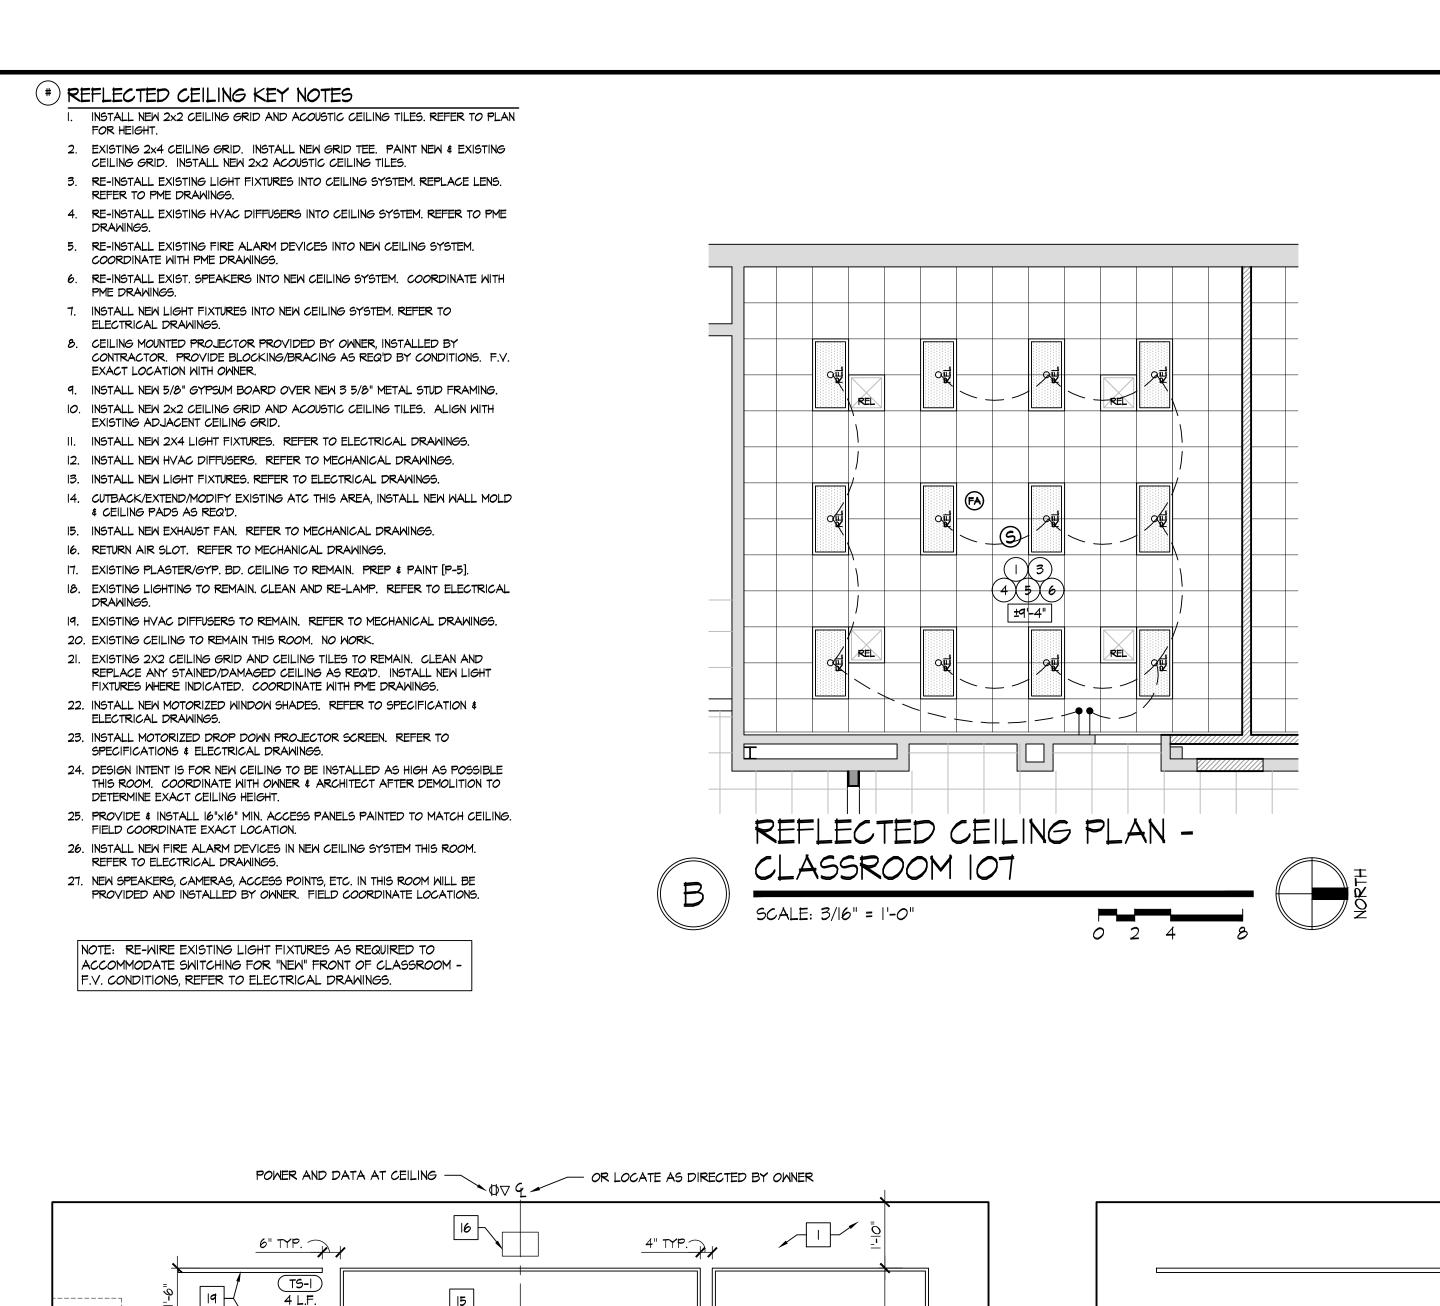CLASSROOM 107

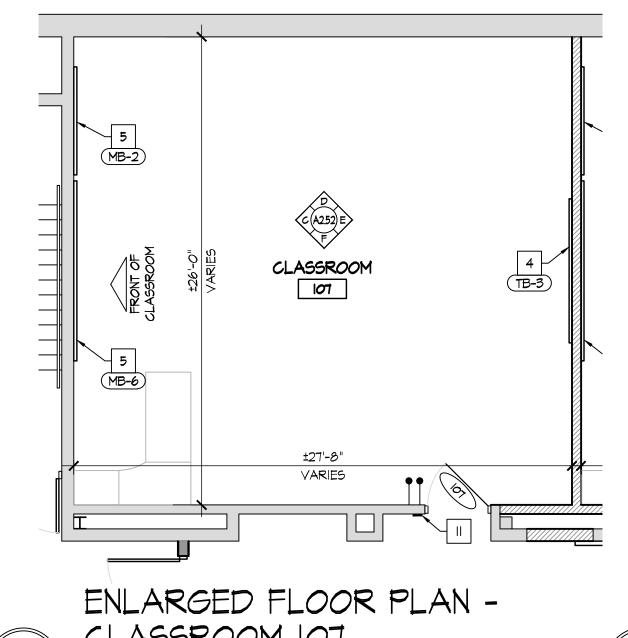SCALE: 3/8" = 1'-0"

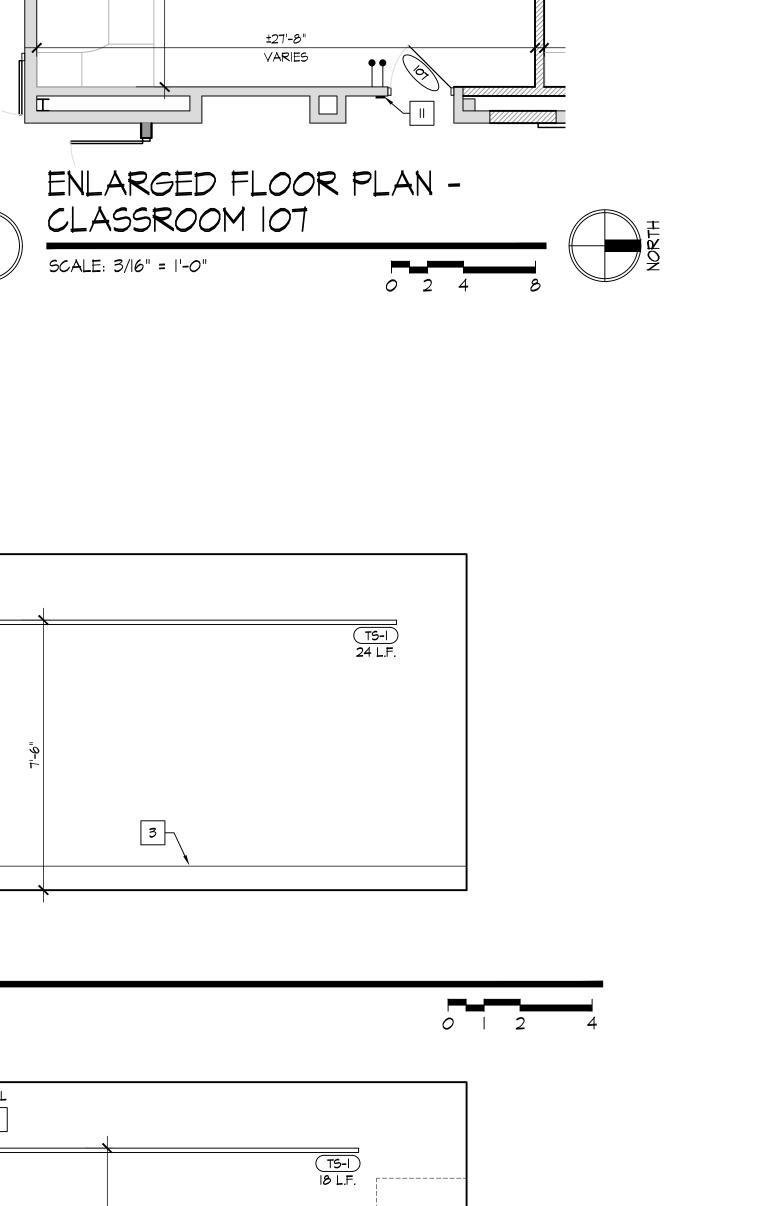





CLASSROOM 107

CLASSROOM 107

ELECTRICAL

OUTLET -

SCALE: 3/8" = 1'-0"

NEW CONSTRUCTION KEY NOTES

EXISTING SOLID CORE WOOD DOOR AND HOLLOW METAL FRAME TO REMAIN. REPAIR & RE-FINISH EX. WOOD DOOR SLAB AND INSTALL NEW HARDWARE AS SPECIFIED. REFER TO DOOR SCHEDULE AND SPECIFICATIONS.

2. INSTALL NEW DOOR AND FRAME IN NEW OPENING. REFER TO DOOR SCHEDULE. 3. INSTALL NEW DOOR AND FRAME IN EXISTING OPENING. REFER TO DOOR

4. INSTALL NEW WINDOW IN NEW OPENING. REFER TO WINDOW SCHEDULE. 5. INSTALL NEW TACKBOARD. SEE SCHEDULE.

6. INSTALL NEW MAGNETIC MARKER BOARD. SEE SCHEDULE.

7. INFILL EXISTING OPENING W/ CMU, TOOTH INTO EXISTING, MATCH EX. EACH SIDE. 8. NO WORK THIS AREA.

9. INSTALL NEW HIGH-LOW DRINKING FOUNTAIN WITH BOTTLE FILLER. REFER TO PLUMBING DRAWINGS.

10. INSTALL NEW LOW DRINKING FOUNTAIN WITH BOTTLE FILLER. REFER TO PLUMBING DRAWINGS.

II. INSTALL NEW ROOM SIGNAGE PROVIDED AND INSTALLED BY OWNER.

12. INSTALL NEW PARTITION WALL, REFER TO WALL TYPES. 13. NEW CASEMORK - SEE INTERIOR ELEVATIONS

14. FURNITURE & EQUIPMENT PROVIDED BY AND INSTALLED BY OWNER - G.C TO

PROVIDE ALL REQUIRED UTILITY CONNECTIONS. REFER TO PME DRAWINGS 15. NEW LOCKERS & BLOCKING BY OWNER, SET ON NEW/EXISTING LOCKER BASES. REFER TO INTERIOR ELEVATIONS.

16. INSTALL NEW STOREFRONT SYSTEM AND DOOR. REFER TO WINDOW & DOOR

17. WALL MOUNTED TV/DISPLAY BY OWNER - INSTALLED BY CONTRACTOR, PROVIDE POWER/DATA - REFER TO ELECTRICAL DRAWINGS.

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19. PREP AND PAINT EXISTING WALLS IN CONTROL ROOM [P-6]. REMOVE EXISTING FLOORING AND INSTALL NEW CARPET [F-6].

20. INSTALL WALL COVERING [WC-I] ON EX. GYP. BD. WALL TO 36" A.F.F. 21. INSTALL WALL COVERING [WC-I] FULL HEIGHT TO UNDERSIDE OF CEILING AT

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23. EXISTING ELECTRICAL PANEL. REFER TO ELECTRICAL DRAWINGS. 24. EXISTING FIRE EXTINGUISHER CABINET TO REMAIN. PROTECT DURING

CONSTRUCTION.

25. REPAIR EXISTING WALL AS REQ'D.

26. EXISTING CASEWORK & EQUIPMENT TO REMAIN. PROTECT DURING CONSTRUCTION.

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REFER TO DIMENSIONED FLOOR PLAN SHEET AI.12. REFER TO SHEET GI.4 FOR WALL TYPES.

INTERIOR ELEVATION KEY NOTES

EXISTING MASONRY WALLS. REPAIR, PREP, AND PAINT.

NEW MASONRY WALLS. PREP \$ PAINT.

WALL BASE, AS SCHEDULED. REFER TO ROOM FINISH SCHEDULE. 4. TV/EQUIPMENT/APPLIANCES PROVIDED BY AND INSTALLED BY OWNER - G.C TO PROVIDE ALL REQUIRED UTILITY CONNECTIONS. REFER TO PME

DRAWINGS. DOOR. REFER TO DOOR SCHEDULE.

6. LINE OF WALL TRANSITION.

7. NEW PRE-FINISHED METAL SCIENCE WALL & BASE CABINETS / CASEWORK / COUNTERTOPS / EQUIPMENT - G.C TO PROVIDE ALL REQUIRED UTILITY CONNECTIONS. REFER TO PME DRAWINGS.

8. NEW FURNITURE/MILLWORK PROVIDED BY AND INSTALLED BY OWNER - G.C TO PROVIDE ALL REQUIRED UTILITY CONNECTIONS. REFER TO PME DRAWINGS 9. EXISTING WINDOW TO REMAIN.

10. NEW WINDOW IN NEW OPENING. REFER TO PLAN. REFER TO WINDOW

SCHEDULE. II. EXISTING COLUMN TO REMAIN. PREP & PAINT.

12. EXISTING ELECTRICAL PANEL. REPE & PAINT [P-I] TYP. REFER TO ELECTRICAL DRAWINGS.

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14. NEW TACK BOARD. REFER TO PLAN. SEE SCHEDULE.

15. NEW MAGNETIC MARKER BOARD. REFER TO PLAN. SEE SCHEDULE.

16. WALL MOUNTED PROJECTOR. PROVIDED & INSTALLED BY OWNER - EXTEND POWER AND DATA TO PROJECTOR LOCATION - REFER TO ELECTRICAL

17. MARKER BOARDS AT PROJECTOR LOCATIONS MUST BE INSTALLED PER MANUFACTURER REQUIREMENTS TO MAINTAIN REQUIRED FLATNESS FOR INTERACTIVE PROJECTION.

18. NO MARKER TRAY AT PROJECTOR LOCATIONS

19. CONTRACTOR SHALL INSTALL OWNER PROVIDED TACK STRIP. TACK STRIP MOUNTED AT HEIGHTS INDICATED ON INTERIOR ELEVATIONS. COORDINATE FINAL LOCATIONS W/ OWNER PRIOR TO INSTALLATION. 20. NEW ROOM SIGNAGE PROVIDED AND INSTALLED BY OWNER.

21. NEW PLASTIC LAMINATE WALL AND BASE CABINETS. COORDINATE WITH OWNER FOR FINISH SELECTION.

22. NEW PLASTIC LAMINATE COUNTERTOP AND BACKSPLASH. COORDINATE WITH

OWNER FOR FINISH SELECTION.

23. PLASTIC LAMINATE FILLER TO MATCH CABINETS. 24. STAINLESS STEEL SINK AND FAUCET. REFER TO PLUMBING DRAWINGS.

25. STAINLESS STEEL PULLS.

26. FINISHED PLASTIC LAMINATE END PANEL.

27. PLASTIC LAMINATE ENDSPLASH. 28. INSTALL RUBBER BASE AT TOE KICK. 29. EXISTING COLUMN TO REMAIN. INSTALL 18" DIA. PRE-MANUFACTURED METAL

COLUMN COVER. SEE SPECIFICATIONS. 30. NEW GYPSUM BOARD BULKHEAD. REFER TO REFLECTED CEILING PLAN.

31. EXISTING FIRE EXTINGUISHER CABINET TO REMAIN. PREP & PAINT [P-I] TYP.

32. NEW DRINKING FOUNTAIN. REFER TO PME DRAWING.

33. NEW ANODIZED ALUMINUM WALL MOUNTED HANDRAIL. 34. LOCKERS BY OWNER

35. PREP AND PAINT ENTIRE EXISTING RAIL SYSTEM, TYP.

O ACCESSORY SCHEDULE

MARK	DESCRIPTION	MODEL
Α	SOAP DISPENSER	PROVIDE BY OWNER / INST. BY CONT.
В	PAPER TOWEL DISPENSER	PROVIDE BY OWNER / INST. BY CONT.

• ALL SHALL BE STAINLESS STEEL FINISH.

FIELD COORDINATE ALL ACCESSORY LOCATIONS, CONFORM TO ALL ACCESSIBILITY INSTALLATION REQUIREMENTS.

• PROVIDE AND INSTALL FRT BLOCKING AS REQUIRED FOR ALL ACCESSORIES.

GENERAL INTERIOR NOTES

REPAIR EX. CMU AS REQ'D AT EXISTING WALLS.

NOMINAL CABINET SIZES INDICATED. VERIFY & PROVIDE ALL REQUIRED FILLERS, ETC. FOR CASEWORK TO ALLOW PROPER OPERATION OF DOORS &

3 OF TO PROVIDE AND INSTALL ALL FREE BLOCKING AS RECHIRED FOR ALL

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Expiration Date 12/31/2023

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CONSTRUCTION

Project Number

2021-203

Date

January 24, 2022

Sheet Title

ENLARGED CLASSROOM 107 PLANS

Sheet Number

(#)	# LABORATORY CASEMORK/EQUIPMENT SCHEDULE [coord. w/ casemork/equipment supplier]							
	Σ	Υ.						
	ITEM	B	DESCRIPTION	MANUF.	MODEL NUMBER			
	1.3		42" SINK BASE CABINET - STANDING HEIGHT	KEWAUNEE	6000352242-1104			
	2.2		30" DRAWER BASE CABINET - STANDING HEIGHT	KEWAUNEE	D3IC352230-IIO4			
	2.5		24" DRAWER BASE CABINET - ADA HEIGHT	KEWAUNEE	D30C322224-IIO4			
	3.6	-	30" BASE CABINET - STANDING HEIGHT	KEWAUNEE	E4IC352230-IIO4			
	4.3		BASE CABINET - FILLER PANEL	KEWAUNEE	VARIES			
	4.4	-	BASE CABINET - FINISHED BACK PANEL	KEWAUNEE	VARIES			
	4.5	-	BASE CABINET - KNEE SPACE PANEL	KEWAUNEE	A06C040336-II04			
	4.6	-	BASE CABINET - 4" H. APRON RAIL - W/ OPEN KNEESPACE	KEWAUNEE	A06C040236-II04			
	5.1	-	36"W. x 30" H. WALL CABINET - OPEN STORAGE	KEWAUNEE	WOOC301636-1104			
	6.3	-	24"W. x 30" H. WALL CABINET - SWING PANEL DOOR	KEWAUNEE	W25C3OI624-IIO4			
	6.4	-	30"W. x 30" H. WALL CABINET - SWING PANEL DOOR	KEWAUNEE	W25C3O163O-11O4			
	8.2	-	30"W. KEMRESIN COUNTERTOPS - STYLE C	KEWAUNEE	LENGTH VARIES			
	8.3	-	31"W. KEMRESIN COUNTERTOPS - STYLE H	KEWAUNEE	LENGTH VARIES			
	10.1	-	30"H. x 32"L. KEMRESIN PEGBOARD W/ DRIP TROUGH	KEWAUNEE	X-020017-BE			

DECK MOUNTED HOT / COLD WATER FAUCET

DECK MOUNTED DUAL SERVICE DOUBLE VALVE - 90° - DUAL INLET WATERSAVER VR4100-64-2AWSA

KEWAUNEE

KEWAUNEE

- A2.62 C

PIPE CHASE

W-0340-0V

SM-22-00-BK

18			45'-8"	
		32'-6"	LASSROOM	
R36, A)			18	43 63 25 51 46 1
	STORAGE 235 23'-2"			23' \\\(\(\frac{45}{\sqrt{0.3}} \)
IS IS		18		43 63 25 51 46
			CLASSROOM	
			45'-8"	
DE IS			45-5"	



(*) REFLECTED CEILING KEY NOTES

2. EXISTING 2x4 CEILING GRID. INSTALL NEW GRID TEE. PAINT NEW & EXISTING CEILING GRID. INSTALL NEW 2x2 ACOUSTIC CEILING TILES.

3. RE-INSTALL EXISTING LIGHT FIXTURES INTO CEILING SYSTEM. REPLACE LENG.

REFER TO PME DRAWINGS. 4. RE-INSTALL EXISTING HVAC DIFFUSERS INTO CEILING SYSTEM. REFER TO PME

5. RE-INSTALL EXISTING FIRE ALARM DEVICES INTO NEW CEILING SYSTEM.

COORDINATE WITH PME DRAWINGS. 6. RE-INSTALL EXIST. SPEAKERS INTO NEW CEILING SYSTEM. COORDINATE WITH

7. INSTALL NEW LIGHT FIXTURES INTO NEW CEILING SYSTEM. REFER TO

ELECTRICAL DRAWINGS. 8. CEILING MOUNTED PROJECTOR PROVIDED BY OWNER, INSTALLED BY CONTRACTOR. PROVIDE BLOCKING/BRACING AS REQ'D BY CONDITIONS. F.V. EXACT LOCATION WITH OWNER.

9. INSTALL NEW 5/8" GYPSUM BOARD OVER NEW 3 5/8" METAL STUD FRAMING. 10. INSTALL NEW 2x2 CEILING GRID AND ACOUSTIC CEILING TILES. ALIGN WITH EXISTING ADJACENT CEILING GRID.

II. INSTALL NEW 2X4 LIGHT FIXTURES. REFER TO ELECTRICAL DRAWINGS. 12. INSTALL NEW HVAC DIFFUSERS. REFER TO MECHANICAL DRAWINGS.

13. INSTALL NEW LIGHT FIXTURES. REFER TO ELECTRICAL DRAWINGS. 14. CUTBACK/EXTEND/MODIFY EXISTING ATC THIS AREA, INSTALL NEW WALL MOLD

\$ CEILING PADS AS REQ'D. 15. INSTALL NEW EXHAUST FAN. REFER TO MECHANICAL DRAWINGS.

DRAWINGS.

16. RETURN AIR SLOT. REFER TO MECHANICAL DRAWINGS. 17. EXISTING PLASTER/GYP. BD. CEILING TO REMAIN. PREP & PAINT [P-5]. 18. EXISTING LIGHTING TO REMAIN. CLEAN AND RE-LAMP. REFER TO ELECTRICAL

19. EXISTING HVAC DIFFUSERS TO REMAIN. REFER TO MECHANICAL DRAWINGS. 20. EXISTING CEILING TO REMAIN THIS ROOM. NO WORK.

21. EXISTING 2X2 CEILING GRID AND CEILING TILES TO REMAIN. CLEAN AND REPLACE ANY STAINED/DAMAGED CEILING AS REQ'D. INSTALL NEW LIGHT FIXTURES WHERE INDICATED. COORDINATE WITH PME DRAWINGS.

22. INSTALL NEW MOTORIZED WINDOW SHADES. REFER TO SPECIFICATION \$ ELECTRICAL DRAWINGS.

23. INSTALL MOTORIZED DROP DOWN PROJECTOR SCREEN. REFER TO SPECIFICATIONS & ELECTRICAL DRAWINGS.

24. DESIGN INTENT IS FOR NEW CEILING TO BE INSTALLED AS HIGH AS POSSIBLE THIS ROOM. COORDINATE WITH OWNER & ARCHITECT AFTER DEMOLITION TO DETERMINE EXACT CEILING HEIGHT.

25. PROVIDE & INSTALL 16"X16" MIN. ACCESS PANELS PAINTED TO MATCH CEILING. FIELD COORDINATE EXACT LOCATION.

26. INSTALL NEW FIRE ALARM DEVICES IN NEW CEILING SYSTEM THIS ROOM. REFER TO ELECTRICAL DRAWINGS.


27. NEW SPEAKERS, CAMERAS, ACCESS POINTS, ETC. IN THIS ROOM WILL BE PROVIDED AND INSTALLED BY OWNER. FIELD COORDINATE LOCATIONS.

INSTALL NEW 2x2 CEILING GRID AND ACOUSTIC CEILING TILES. REFER TO PLAN

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NEW CONSTRUCTION KEY NOTES

EXISTING SOLID CORE WOOD DOOR AND HOLLOW METAL FRAME TO REMAIN. REPAIR & RE-FINISH EX. WOOD DOOR SLAB AND INSTALL NEW HARDWARE AS SPECIFIED. REFER TO DOOR SCHEDULE AND SPECIFICATIONS.

2. INSTALL NEW DOOR AND FRAME IN NEW OPENING. REFER TO DOOR SCHEDULE. 3. INSTALL NEW DOOR AND FRAME IN EXISTING OPENING. REFER TO DOOR

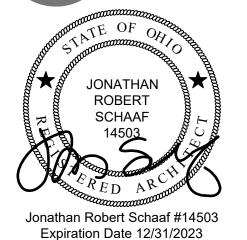4. INSTALL NEW WINDOW IN NEW OPENING. REFER TO WINDOW SCHEDULE.

5. INSTALL NEW TACKBOARD. SEE SCHEDULE. 6. INSTALL NEW MAGNETIC MARKER BOARD. SEE SCHEDULE.

7. INFILL EXISTING OPENING W/ CMU, TOOTH INTO EXISTING, MATCH EX. EACH SIDE.

8. NO WORK THIS AREA. 9. INSTALL NEW HIGH-LOW DRINKING FOUNTAIN WITH BOTTLE FILLER. REFER TO PLUMBING DRAWINGS.

10. INSTALL NEW LOW DRINKING FOUNTAIN WITH BOTTLE FILLER. REFER TO PLUMBING DRAWINGS.

II. INSTALL NEW ROOM SIGNAGE PROVIDED AND INSTALLED BY OWNER.

12. INSTALL NEW PARTITION WALL, REFER TO WALL TYPES.

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CONSTRUCTION. 27. INSTALL 18" DIA. PRE-MANUFACTURED METAL COLUMN COVER. SEE

SPECIFICATIONS. REFER TO B/A2.41.

REFER TO DIMENSIONED FLOOR PLAN SHEET AI.12. REFER TO SHEET GI.4 FOR WALL TYPES.

12/07/21 DESIGN REVIEW 01/11/22 REVIEW 01/24/22 BID SET/ CONSTRUCTION

11/16/21 REVIEW

10/11/21 PRELIMINARY

Print Record

Project Number 2021-203


January 24, 2022

Sheet Title

ENLARGED CLASSROOMS 234 \$ 236 PLANS

Sheet Number

A2.6

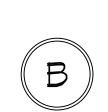

ENLARGED REFLECTED CEILING PLAN - CLASSROOMS 234 \$ 236

20) ±9'-4"


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SCALE: 3/16" = 1'-0"





SCALE: 3/16" = 1'-0"

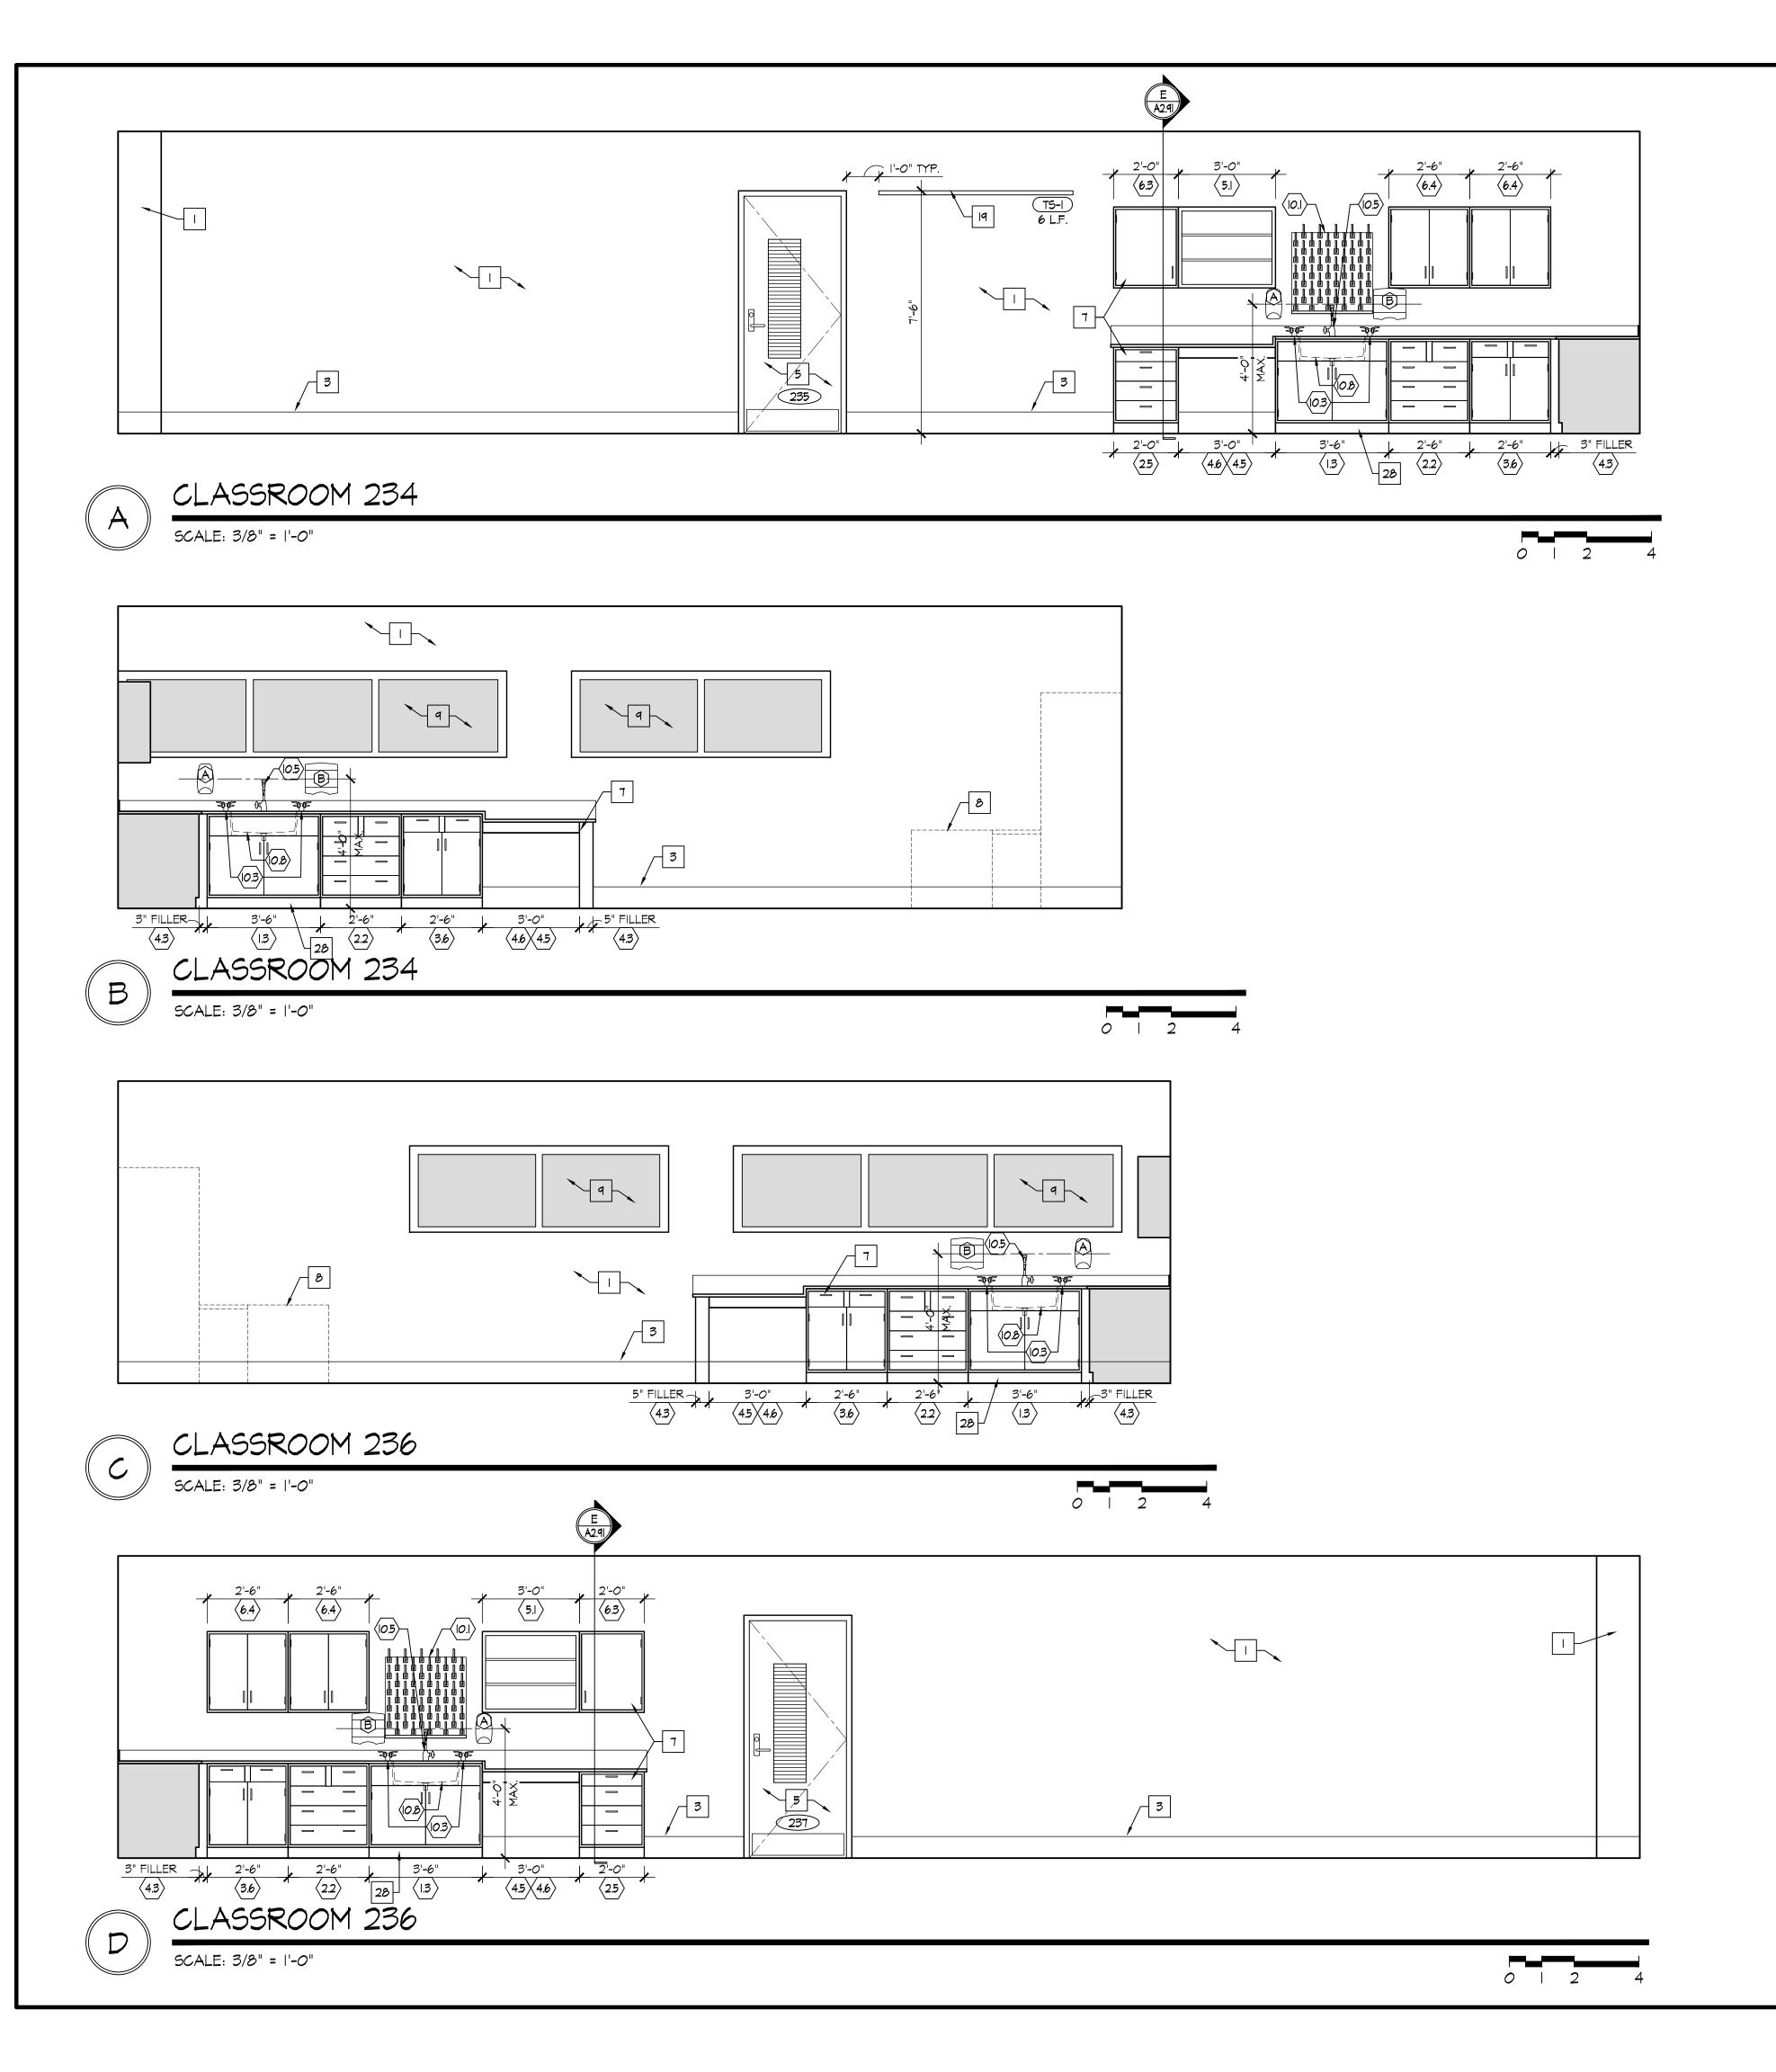

INTERIOR ELEVATION KEY NOTES

- EXISTING MASONRY WALLS. REPAIR, PREP, AND PAINT.
- NEW MASONRY WALLS. PREP & PAINT.
- 3. WALL BASE, AS SCHEDULED. REFER TO ROOM FINISH SCHEDULE. 4. TV/EQUIPMENT/APPLIANCES PROVIDED BY AND INSTALLED BY OWNER - G.C TO PROVIDE ALL REQUIRED UTILITY CONNECTIONS. REFER TO PME
- DRAWINGS. 5. DOOR. REFER TO DOOR SCHEDULE.
- 6. LINE OF WALL TRANSITION.
- 7. NEW PRE-FINISHED METAL SCIENCE WALL & BASE CABINETS / CASEWORK / COUNTERTOPS / EQUIPMENT - G.C TO PROVIDE ALL REQUIRED UTILITY CONNECTIONS. REFER TO PME DRAWINGS.
- 8. NEW FURNITURE/MILLWORK PROVIDED BY AND INSTALLED BY OWNER G.C TO PROVIDE ALL REQUIRED UTILITY CONNECTIONS. REFER TO PME DRAWINGS
- 9. EXISTING WINDOW TO REMAIN. IO. NEW WINDOW IN NEW OPENING. REFER TO PLAN. REFER TO WINDOW
- SCHEDULE. II. EXISTING COLUMN TO REMAIN. PREP & PAINT.
- 12. EXISTING ELECTRICAL PANEL. REPE & PAINT [P-I] TYP. REFER TO
- ELECTRICAL DRAWINGS. 13. METAL STUD GYP. BD. WALL. PREP & PAINT.
- 14. NEW TACK BOARD. REFER TO PLAN. SEE SCHEDULE.
- 16. WALL MOUNTED PROJECTOR, PROVIDED & INSTALLED BY OWNER EXTEND POWER AND DATA TO PROJECTOR LOCATION - REFER TO ELECTRICAL

15. NEW MAGNETIC MARKER BOARD. REFER TO PLAN. SEE SCHEDULE.

- 17. MARKER BOARDS AT PROJECTOR LOCATIONS MUST BE INSTALLED PER MANUFACTURER REQUIREMENTS TO MAINTAIN REQUIRED FLATNESS FOR
- INTERACTIVE PROJECTION. 18. NO MARKER TRAY AT PROJECTOR LOCATIONS.
- 19. CONTRACTOR SHALL INSTALL OWNER PROVIDED TACK STRIP. TACK STRIP MOUNTED AT HEIGHTS INDICATED ON INTERIOR ELEVATIONS. COORDINATE FINAL LOCATIONS W OWNER PRIOR TO INSTALLATION.
- 20. NEW ROOM SIGNAGE PROVIDED AND INSTALLED BY OWNER. 21. NEW PLASTIC LAMINATE WALL AND BASE CABINETS. COORDINATE WITH OWNER FOR FINISH SELECTION.
- 22. NEW PLASTIC LAMINATE COUNTERTOP AND BACKSPLASH. COORDINATE WITH OWNER FOR FINISH SELECTION.
- 23. PLASTIC LAMINATE FILLER TO MATCH CABINETS.
- 24. STAINLESS STEEL SINK AND FAUCET. REFER TO PLUMBING DRAWINGS.
- 25. STAINLESS STEEL PULLS.
- 26. FINISHED PLASTIC LAMINATE END PANEL.
- 27. PLASTIC LAMINATE ENDSPLASH.
- 28. INSTALL RUBBER BASE AT TOE KICK.
- 29. EXISTING COLUMN TO REMAIN. INSTALL 18" DIA. PRE-MANUFACTURED METAL COLUMN COVER. SEE SPECIFICATIONS.
- 30. NEW GYPSUM BOARD BULKHEAD. REFER TO REFLECTED CEILING PLAN.
- 31. EXISTING FIRE EXTINGUISHER CABINET TO REMAIN. PREP & PAINT [P-I] TYP. 32. NEW DRINKING FOUNTAIN. REFER TO PME DRAWING.
- 33. NEW ANODIZED ALUMINUM WALL MOUNTED HANDRAIL.
- 34. LOCKERS BY OWNER
- 35. PREP AND PAINT ENTIRE EXISTING RAIL SYSTEM, TYP.

○ ACCESSORY SCHEDULE


MARK	DESCRIPTION	MODEL
A	SOAP DISPENSER	PROVIDE BY OWNER / INST. BY CONT.
В	PAPER TOWEL DISPENSER	PROVIDE BY OWNER / INST. BY CONT.

ALL SHALL BE STAINLESS STEEL FINISH.

- FIELD COORDINATE ALL ACCESSORY LOCATIONS, CONFORM TO ALL ACCESSIBILITY INSTALLATION REQUIREMENTS.
- PROVIDE AND INSTALL FRT BLOCKING AS REQUIRED FOR ALL ACCESSORIES.

GENERAL INTERIOR NOTES

- I. REPAIR EX. CMU AS REQ'D AT EXISTING WALLS.
- 2. NOMINAL CABINET SIZES INDICATED. VERIFY & PROVIDE ALL REQUIRED FILLERS, ETC. FOR CASEMORK TO ALLOW PROPER OPERATION OF DOORS & DRAWERS, TYPICAL.
- 3. GC TO PROVIDE AND INSTALL ALL FRT BLOCKING AS REQUIRED FOR ALL CABINETS, SHELVES, ACCESSORIES, ETC.

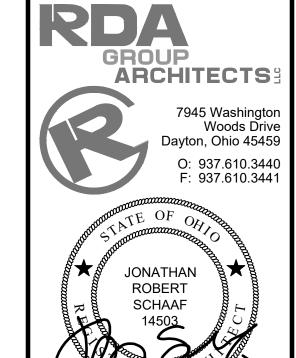

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Jonathan Robert Schaaf #14503

Expiration Date 12/31/2023

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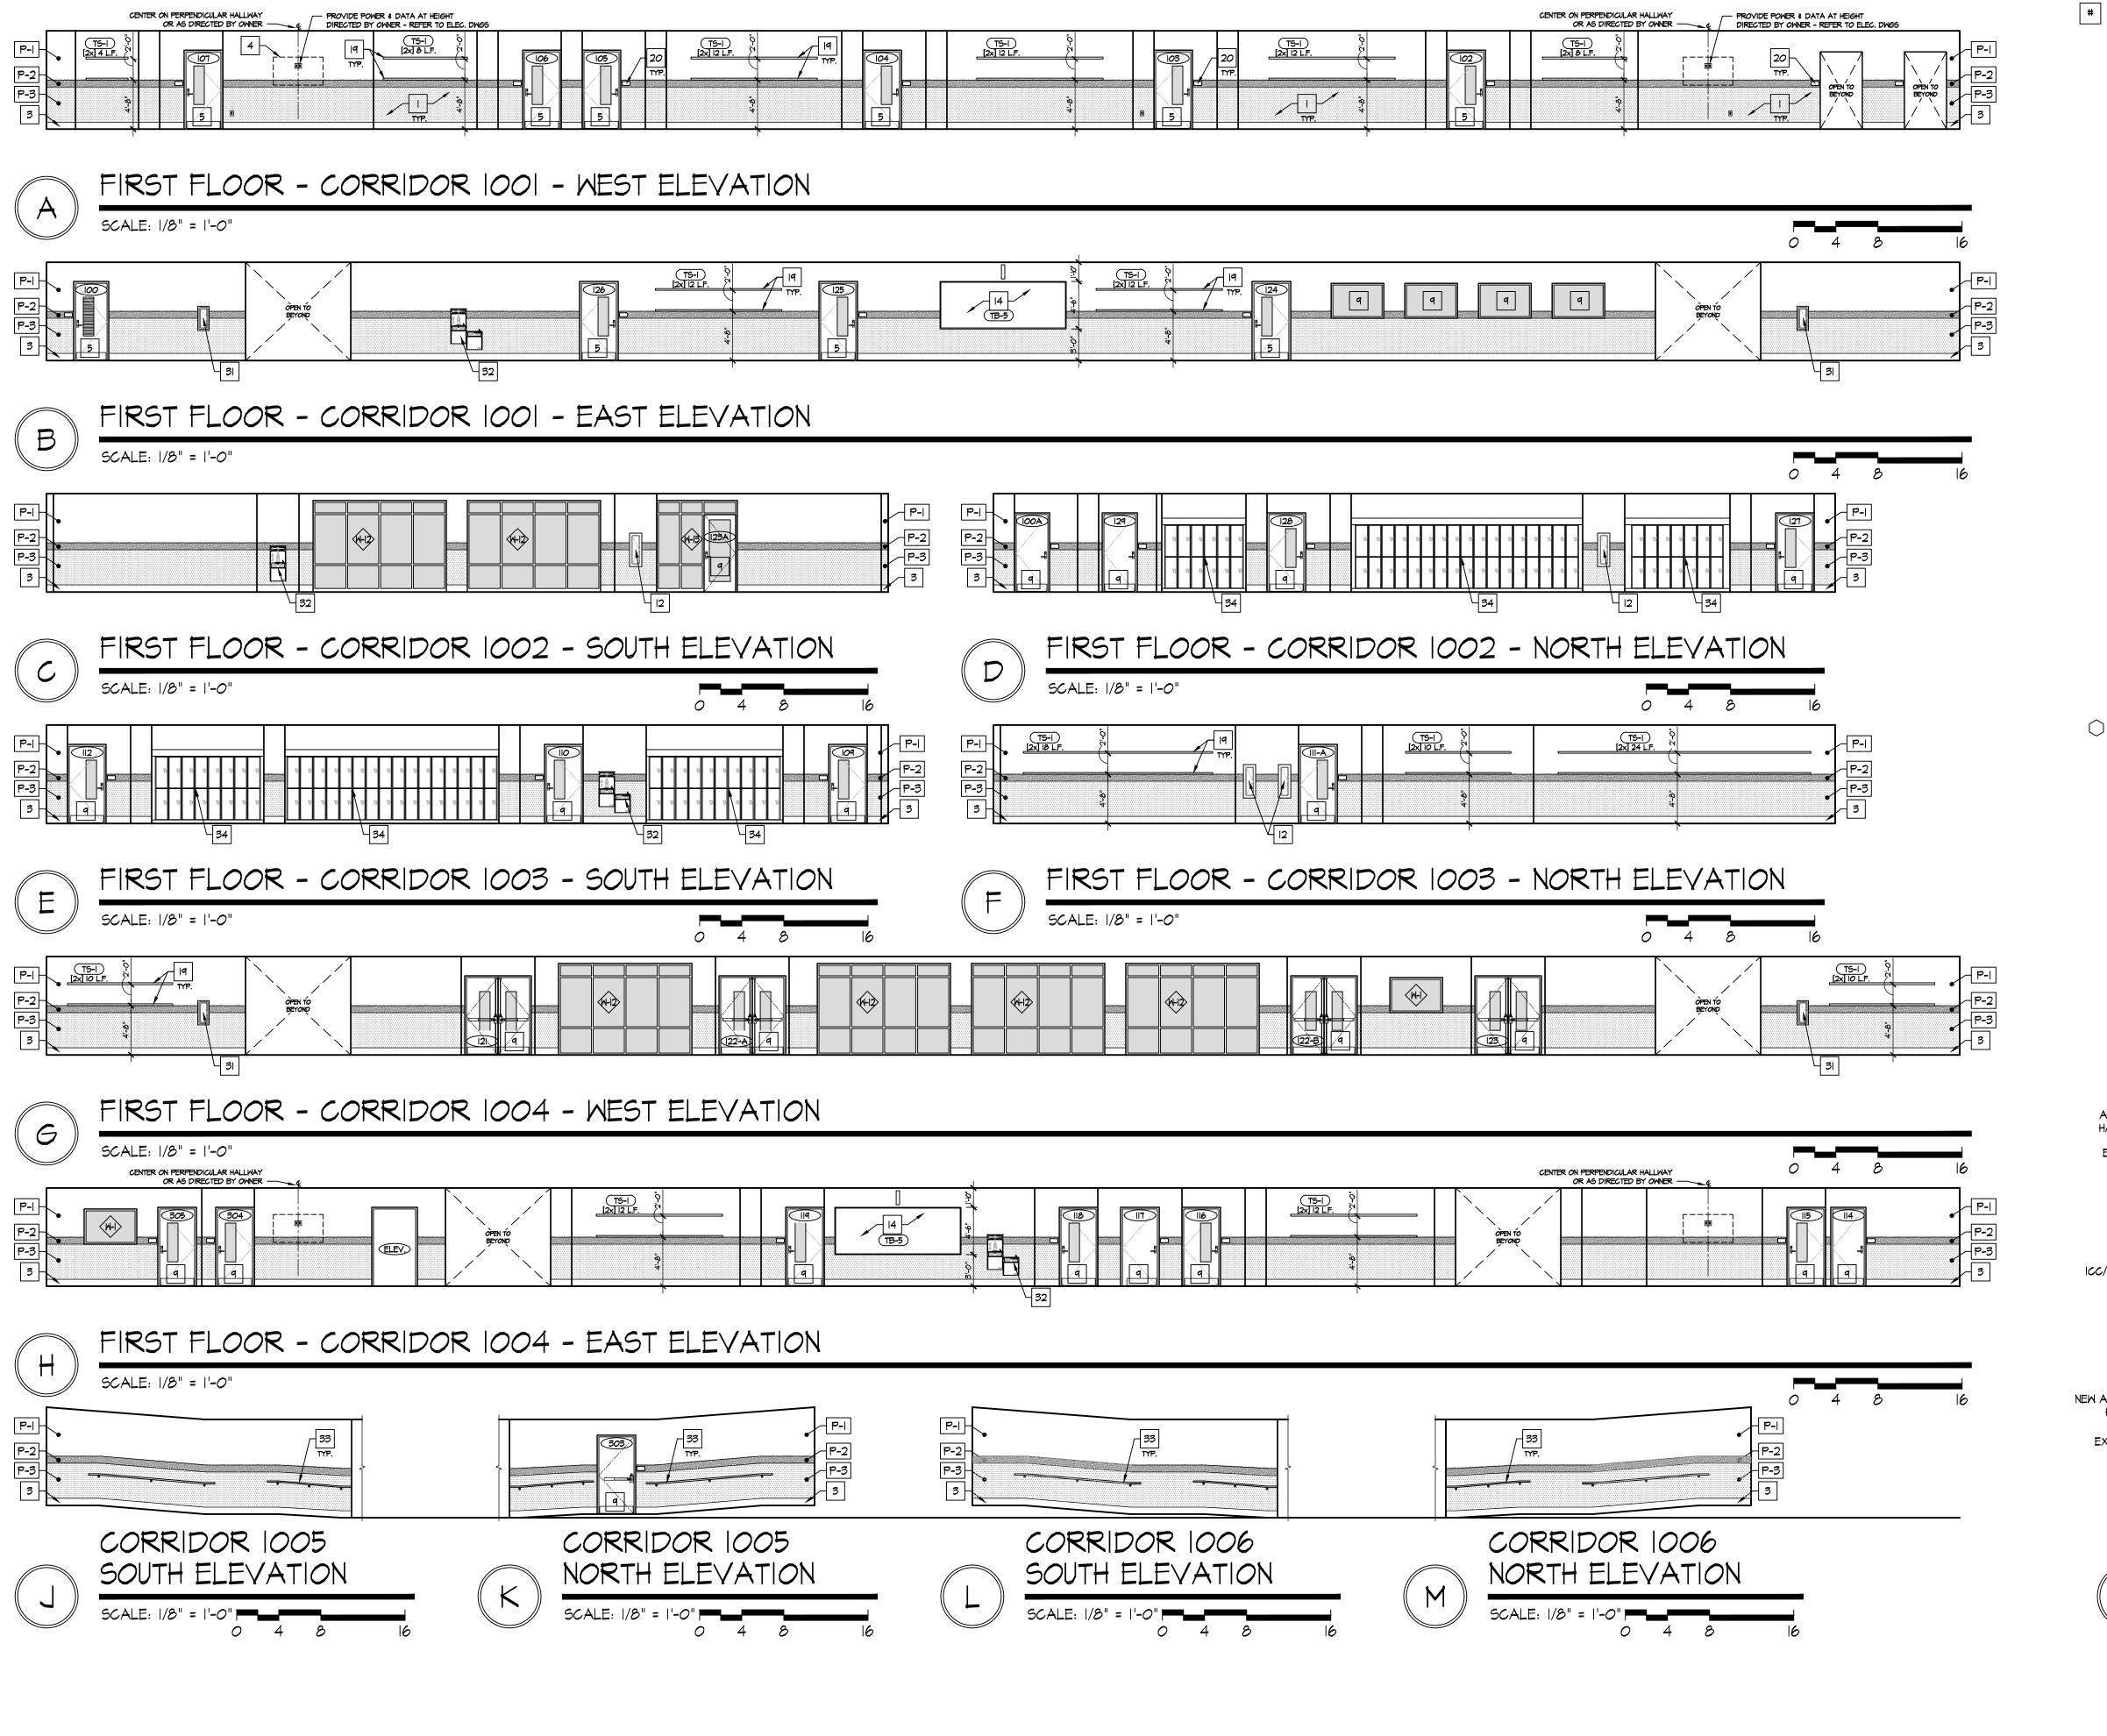
Sheet Title

January 24, 2022

Date

CLASSROOMS 234 \$236 INTERIOR ELEVATIONS

Sheet Number



| INTERIOR ELEVATION KEY NOTES

- EXISTING MASONRY WALLS. REPAIR, PREP, AND PAINT.
- NEW MASONRY WALLS. PREP & PAINT.
- 3. WALL BASE, AS SCHEDULED. REFER TO ROOM FINISH SCHEDULE. 4. TV/EQUIPMENT/APPLIANCES PROVIDED BY AND INSTALLED BY OWNER - G.C TO PROVIDE ALL REQUIRED UTILITY CONNECTIONS. REFER TO PME
- 5. DOOR. REFER TO DOOR SCHEDULE. 6. LINE OF WALL TRANSITION.
- 7. NEW PRE-FINISHED METAL SCIENCE WALL & BASE CABINETS / CASEWORK / COUNTERTOPS / EQUIPMENT - G.C TO PROVIDE ALL REQUIRED UTILITY CONNECTIONS. REFER TO PME DRAWINGS.
- 8. NEW FURNITURE/MILLWORK PROVIDED BY AND INSTALLED BY OWNER G.C TO PROVIDE ALL REQUIRED UTILITY CONNECTIONS. REFER TO PME DRAWINGS
- 9. EXISTING WINDOW TO REMAIN. IO. NEW WINDOW IN NEW OPENING. REFER TO PLAN. REFER TO WINDOW
- SCHEDULE.
- II. EXISTING COLUMN TO REMAIN. PREP & PAINT.
- 12. EXISTING ELECTRICAL PANEL. REPE & PAINT [P-I] TYP. REFER TO ELECTRICAL DRAWINGS.
- 13. METAL STUD GYP. BD. WALL. PREP & PAINT. 14. NEW TACK BOARD. REFER TO PLAN. SEE SCHEDULE.
- 15. NEW MAGNETIC MARKER BOARD. REFER TO PLAN. SEE SCHEDULE 16. WALL MOUNTED PROJECTOR, PROVIDED \$ INSTALLED BY OWNER - EXTEND

POWER AND DATA TO PROJECTOR LOCATION - REFER TO ELECTRICAL

- 17. MARKER BOARDS AT PROJECTOR LOCATIONS MUST BE INSTALLED PER MANUFACTURER REQUIREMENTS TO MAINTAIN REQUIRED FLATNESS FOR
- INTERACTIVE PROJECTION. 18. NO MARKER TRAY AT PROJECTOR LOCATIONS.
- 19. CONTRACTOR SHALL INSTALL OWNER PROVIDED TACK STRIP. TACK STRIP MOUNTED AT HEIGHTS INDICATED ON INTERIOR ELEVATIONS. COORDINATE FINAL LOCATIONS W OWNER PRIOR TO INSTALLATION.
- 20. NEW ROOM SIGNAGE PROVIDED AND INSTALLED BY OWNER. 21. NEW PLASTIC LAMINATE WALL AND BASE CABINETS. COORDINATE WITH
- OWNER FOR FINISH SELECTION. 22. NEW PLASTIC LAMINATE COUNTERTOP AND BACKSPLASH. COORDINATE WITH
- OWNER FOR FINISH SELECTION. 23. PLASTIC LAMINATE FILLER TO MATCH CABINETS.
- 24. STAINLESS STEEL SINK AND FAUCET. REFER TO PLUMBING DRAWINGS.
- 25. STAINLESS STEEL PULLS.
- 26. FINISHED PLASTIC LAMINATE END PANEL. 27. PLASTIC LAMINATE ENDSPLASH.
- 28. INSTALL RUBBER BASE AT TOE KICK.
- 29. EXISTING COLUMN TO REMAIN. INSTALL 18" DIA. PRE-MANUFACTURED METAL COLUMN COVER. SEE SPECIFICATIONS.
- 30. NEW GYPSUM BOARD BULKHEAD. REFER TO REFLECTED CEILING PLAN.
- 31. EXISTING FIRE EXTINGUISHER CABINET TO REMAIN. PREP & PAINT [P-1] TYP. 32. NEW DRINKING FOUNTAIN. REFER TO PME DRAWING.
- 33. NEW ANODIZED ALUMINUM WALL MOUNTED HANDRAIL 34. LOCKERS BY OWNER
- 35. PREP AND PAINT ENTIRE EXISTING RAIL SYSTEM, TYP.

○ ACCESSORY SCHEDULE


MARK	DESCRIPTION	MODEL
A	SOAP DISPENSER	PROVIDE BY OWNER / INST. BY CONT
В	PAPER TOWEL DISPENSER	PROVIDE BY OWNER / INST. BY CONT

ALL SHALL BE STAINLESS STEEL FINISH.


- FIELD COORDINATE ALL ACCESSORY LOCATIONS, CONFORM TO ALL ACCESSIBILITY INSTALLATION REQUIREMENTS.
- PROVIDE AND INSTALL FRT BLOCKING AS REQUIRED FOR ALL ACCESSORIES.

GENERAL INTERIOR NOTES

- REPAIR EX. CMU AS REQ'D AT EXISTING WALLS.
- 2. NOMINAL CABINET SIZES INDICATED. VERIFY & PROVIDE ALL REQUIRED FILLERS, ETC. FOR CASEWORK TO ALLOW PROPER OPERATION OF DOORS DRAWERS, TYPICAL.
- 3. GC TO PROVIDE AND INSTALL ALL FRT BLOCKING AS REQUIRED FOR ALL CABINETS, SHELVES, ACCESSORIES, ETC.

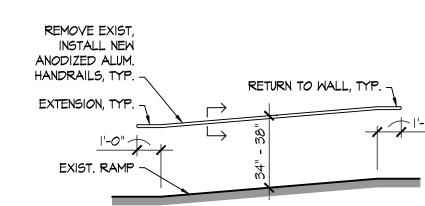


ICC/ANSI AII7.I - 2009 CHAPTER 5 FIG. 505.4 / 505.10.2 / 505.10.1 / 505.10.3 HANDRAIL HEIGHT / EXTENSIONS

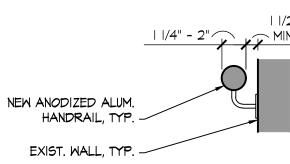

ICC/ANSI AII7.1 - 2009 CHAPTER 5 FIG. 505.7 HANDRAIL CROSS SECTION





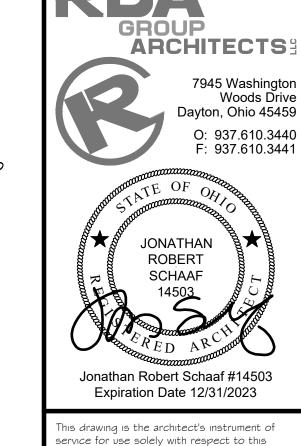

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project. RDA Group Architects is the author

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Print Record 10/11/21 PRELIMINARY 11/16/21 REVIEW 12/07/21 DESIGN REVIEW

CONSTRUCTION

01/11/22 REVIEW 01/24/22 BID SET/

Project Number 2021-203


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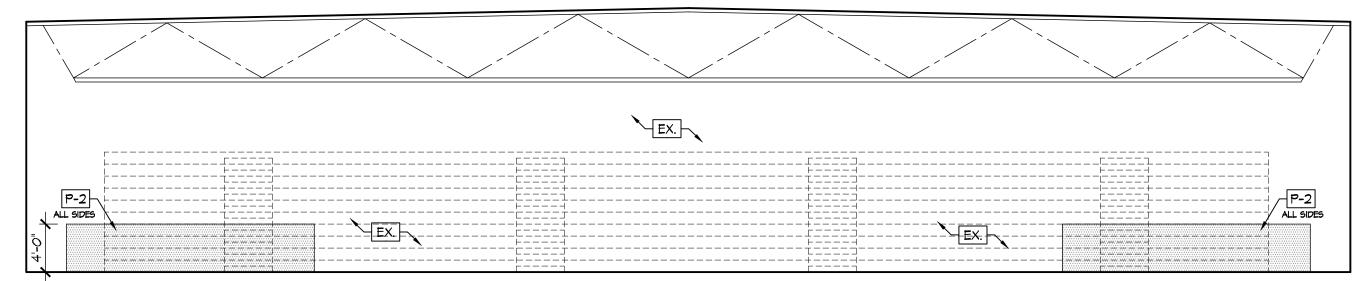
January 24, 2022


Sheet Title

CORRIDOR INTERIOR **ELEVATIONS**

Sheet Number



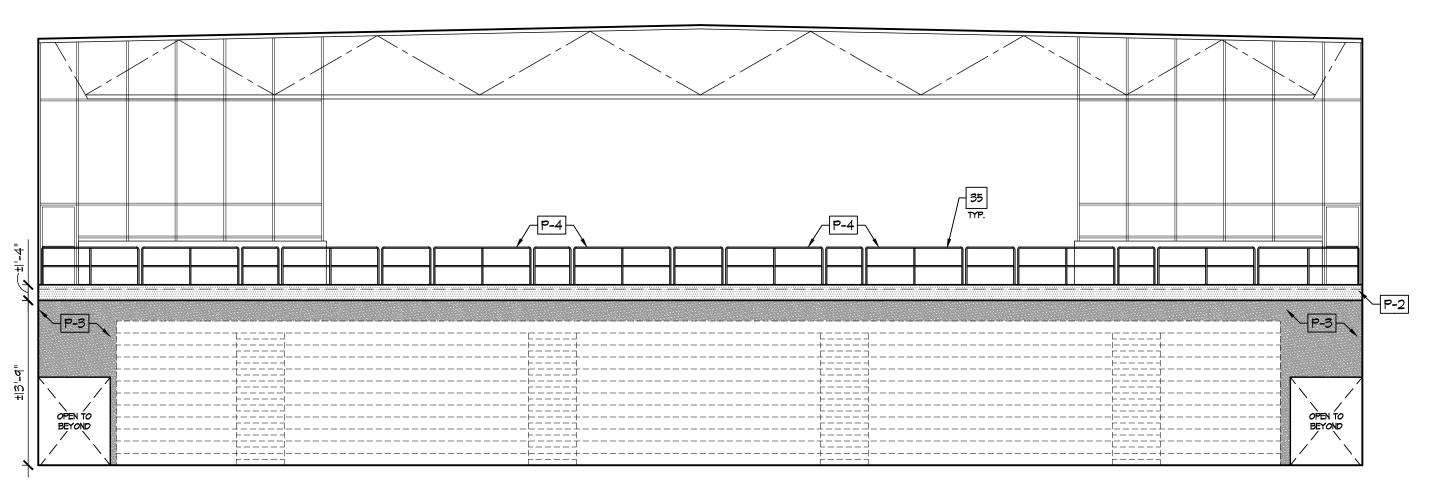


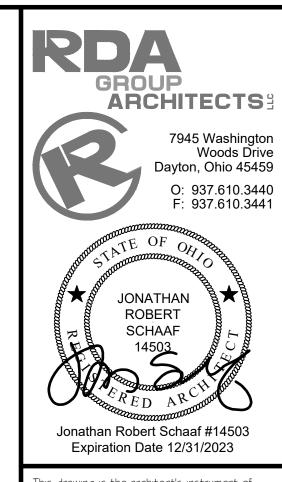


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GYMNASIUM 400 - SOUTH ELEVATION

SCALE: 1/8" = 1'-0"

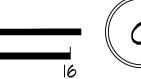

MEZZANINE 702 - SOUTH ELEVATION

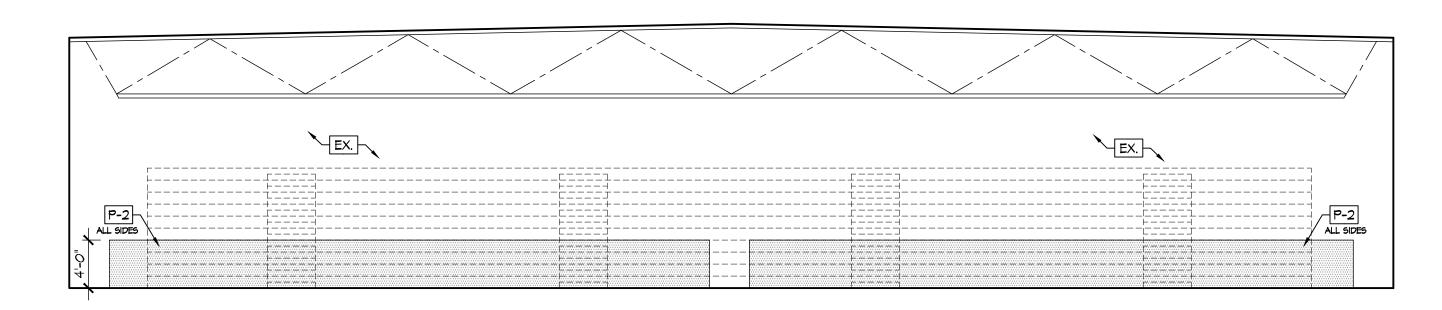

GYMNASIUM 400 - NORTH ELEVATION

SCALE: 1/8" = 1'-0"



MEZZANINE 700 - NORTH ELEVATION

| INTERIOR ELEVATION KEY NOTES

EXISTING MASONRY WALLS. REPAIR, PREP, AND PAINT. NEW MASONRY WALLS. PREP & PAINT.

WALL BASE, AS SCHEDULED. REFER TO ROOM FINISH SCHEDULE.

4. TV/EQUIPMENT/APPLIANCES PROVIDED BY AND INSTALLED BY OWNER - G.C TO PROVIDE ALL REQUIRED UTILITY CONNECTIONS. REFER TO PME DRAWINGS.

DOOR. REFER TO DOOR SCHEDULE. LINE OF WALL TRANSITION.

NEW PRE-FINISHED METAL SCIENCE WALL & BASE CABINETS / CASEWORK / COUNTERTOPS / EQUIPMENT - G.C TO PROVIDE ALL REQUIRED UTILITY CONNECTIONS. REFER TO PME DRAWINGS.

NEW FURNITURE/MILLWORK PROVIDED BY AND INSTALLED BY OWNER - G.C TO

PROVIDE ALL REQUIRED UTILITY CONNECTIONS. REFER TO PME DRAWINGS EXISTING WINDOW TO REMAIN.

IO. NEW WINDOW IN NEW OPENING. REFER TO PLAN. REFER TO WINDOW SCHEDULE.

II. EXISTING COLUMN TO REMAIN. PREP & PAINT. 12. EXISTING ELECTRICAL PANEL. REPE & PAINT [P-I] TYP. REFER TO

ELECTRICAL DRAWINGS. 13. METAL STUD GYP. BD. WALL. PREP & PAINT.

14. NEW TACK BOARD. REFER TO PLAN. SEE SCHEDULE.

15. NEW MAGNETIC MARKER BOARD. REFER TO PLAN. SEE SCHEDULE. 16. WALL MOUNTED PROJECTOR. PROVIDED & INSTALLED BY OWNER - EXTEND POWER AND DATA TO PROJECTOR LOCATION - REFER TO ELECTRICAL

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27. PLASTIC LAMINATE ENDSPLASH.

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30. NEW GYPSUM BOARD BULKHEAD. REFER TO REFLECTED CEILING PLAN. 31. EXISTING FIRE EXTINGUISHER CABINET TO REMAIN. PREP & PAINT [P-I] TYP.

32. NEW DRINKING FOUNTAIN. REFER TO PME DRAWING. 33. NEW ANODIZED ALUMINUM WALL MOUNTED HANDRAIL.

34. LOCKERS BY OWNER 35. PREP AND PAINT ENTIRE EXISTING RAIL SYSTEM, TYP. ○ ACCESSORY SCHEDULE

MARK DESCRIPTION A SOAP DISPENSER PROVIDE BY OWNER / INST. BY CONT. B PAPER TOWEL DISPENSER PROVIDE BY OWNER / INST. BY CONT.

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Project Number 2021-203

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12/07/21 DESIGN REVIEW

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01/24/22 BID SET/

Date

January 24, 2022

Sheet Title


GYMNASIUM INTERIOR ELEVATIONS

Sheet Number

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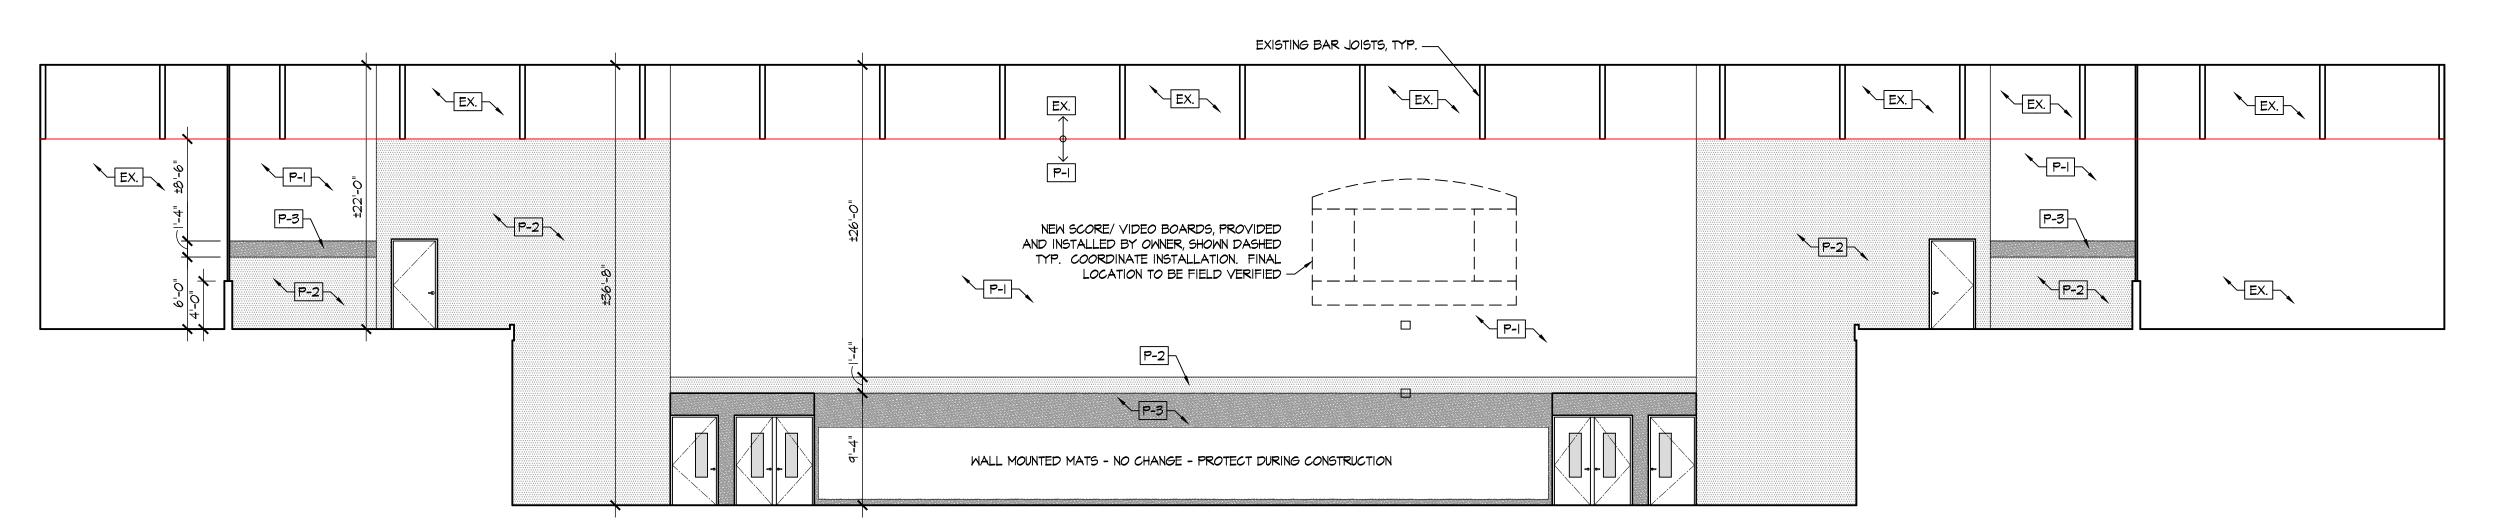
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GYMNASIUM 400 - WEST ELEVATION

SCALE: 1/8" = 1'-0"

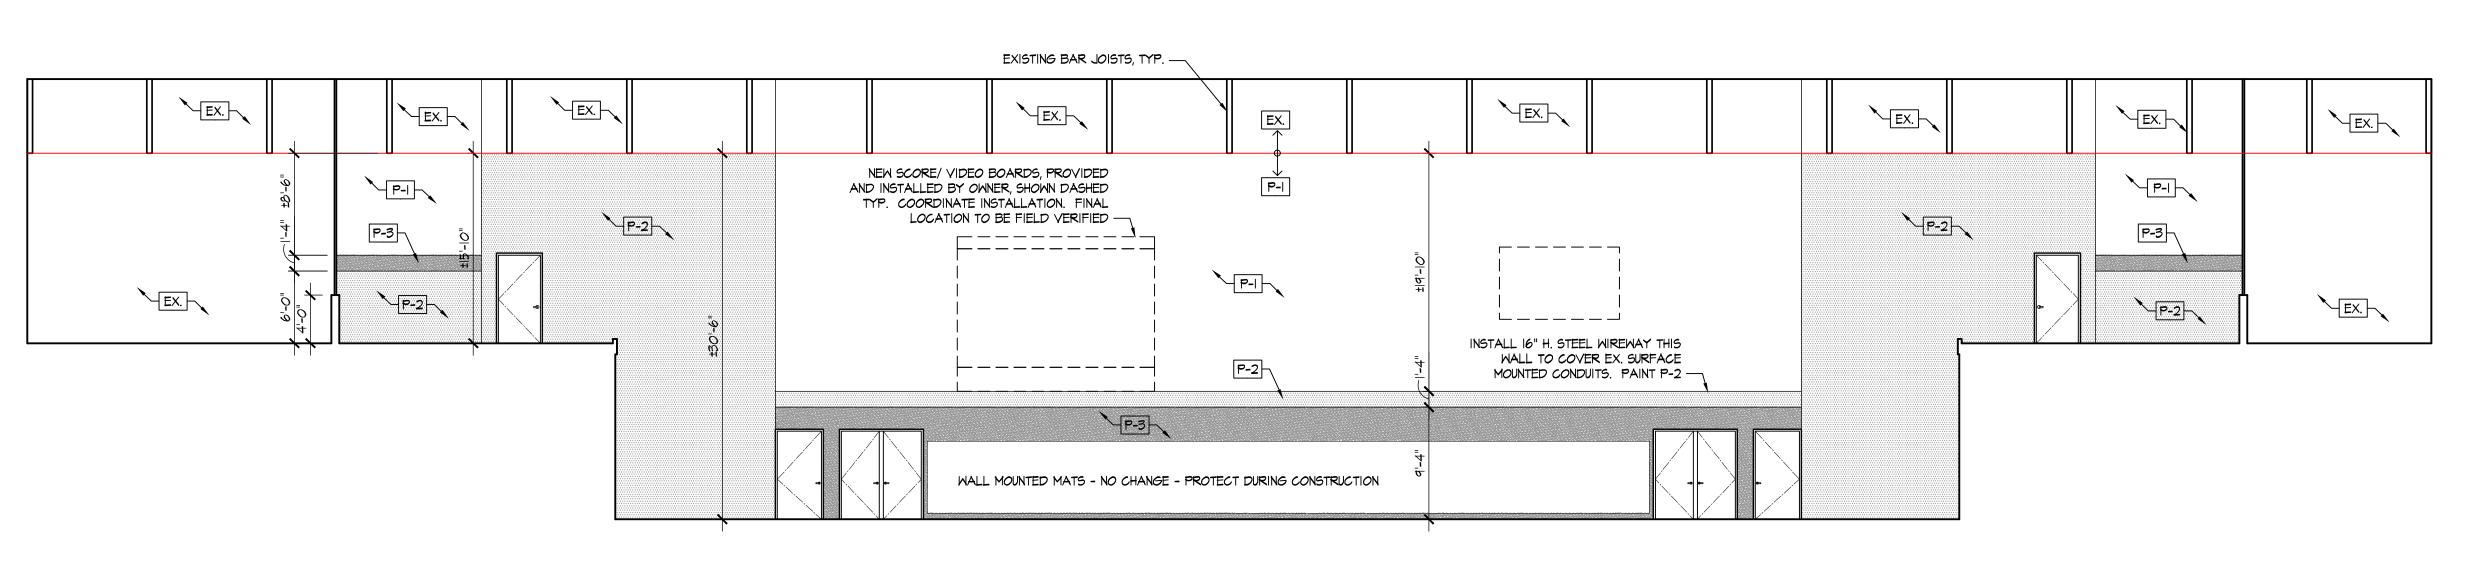

GYMNASIUM 400 - EAST ELEVATION

SCALE: 1/8" = 1'-0"

INTERIOR ELEVATION KEY NOTES

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DOOR. REFER TO DOOR SCHEDULE.

DRAWINGS.

LINE OF WALL TRANSITION.

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NEW FURNITURE/MILLWORK PROVIDED BY AND INSTALLED BY OWNER - G.C TO PROVIDE ALL REQUIRED UTILITY CONNECTIONS. REFER TO PME DRAWINGS

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34. LOCKERS BY OWNER 35. PREP AND PAINT ENTIRE EXISTING RAIL SYSTEM, TYP. ○ ACCESSORY SCHEDULE

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3. GC TO PROVIDE AND INSTALL ALL FRT BLOCKING AS REQUIRED FOR ALL

01/11/22 REVIEW 01/24/22 BID SET/ CABINETS, SHELVES, ACCESSORIES, ETC.

Project Number

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11/16/21 REVIEW

2021-203

Date

January 24, 2022

Sheet Title

GYMNASIUM INTERIOR ELEVATIONS

Sheet Number

A2.82

GROUP ARCHITECTS 7945 Washingtor Woods Drive Dayton, Ohio 45459 O: 937.610.3440 F: 937.610.3441 JONATHAN ROBERT SCHAAF Jonathan Robert Schaaf #14503 Expiration Date 12/31/2023 his drawing is the architect's instrument of service for use solely with respect to this project. RDA Group Architects is the author of this document and shall retain all copyrights and other reserved rights, unless otherwise agreed upon in writing.


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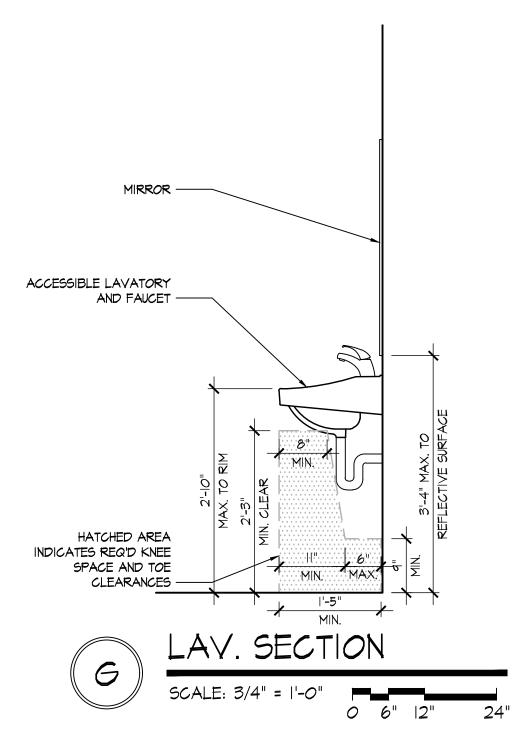
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JONATHAN

ROBERT

SCHAAF

14503

Jonathan Robert Schaaf #14503

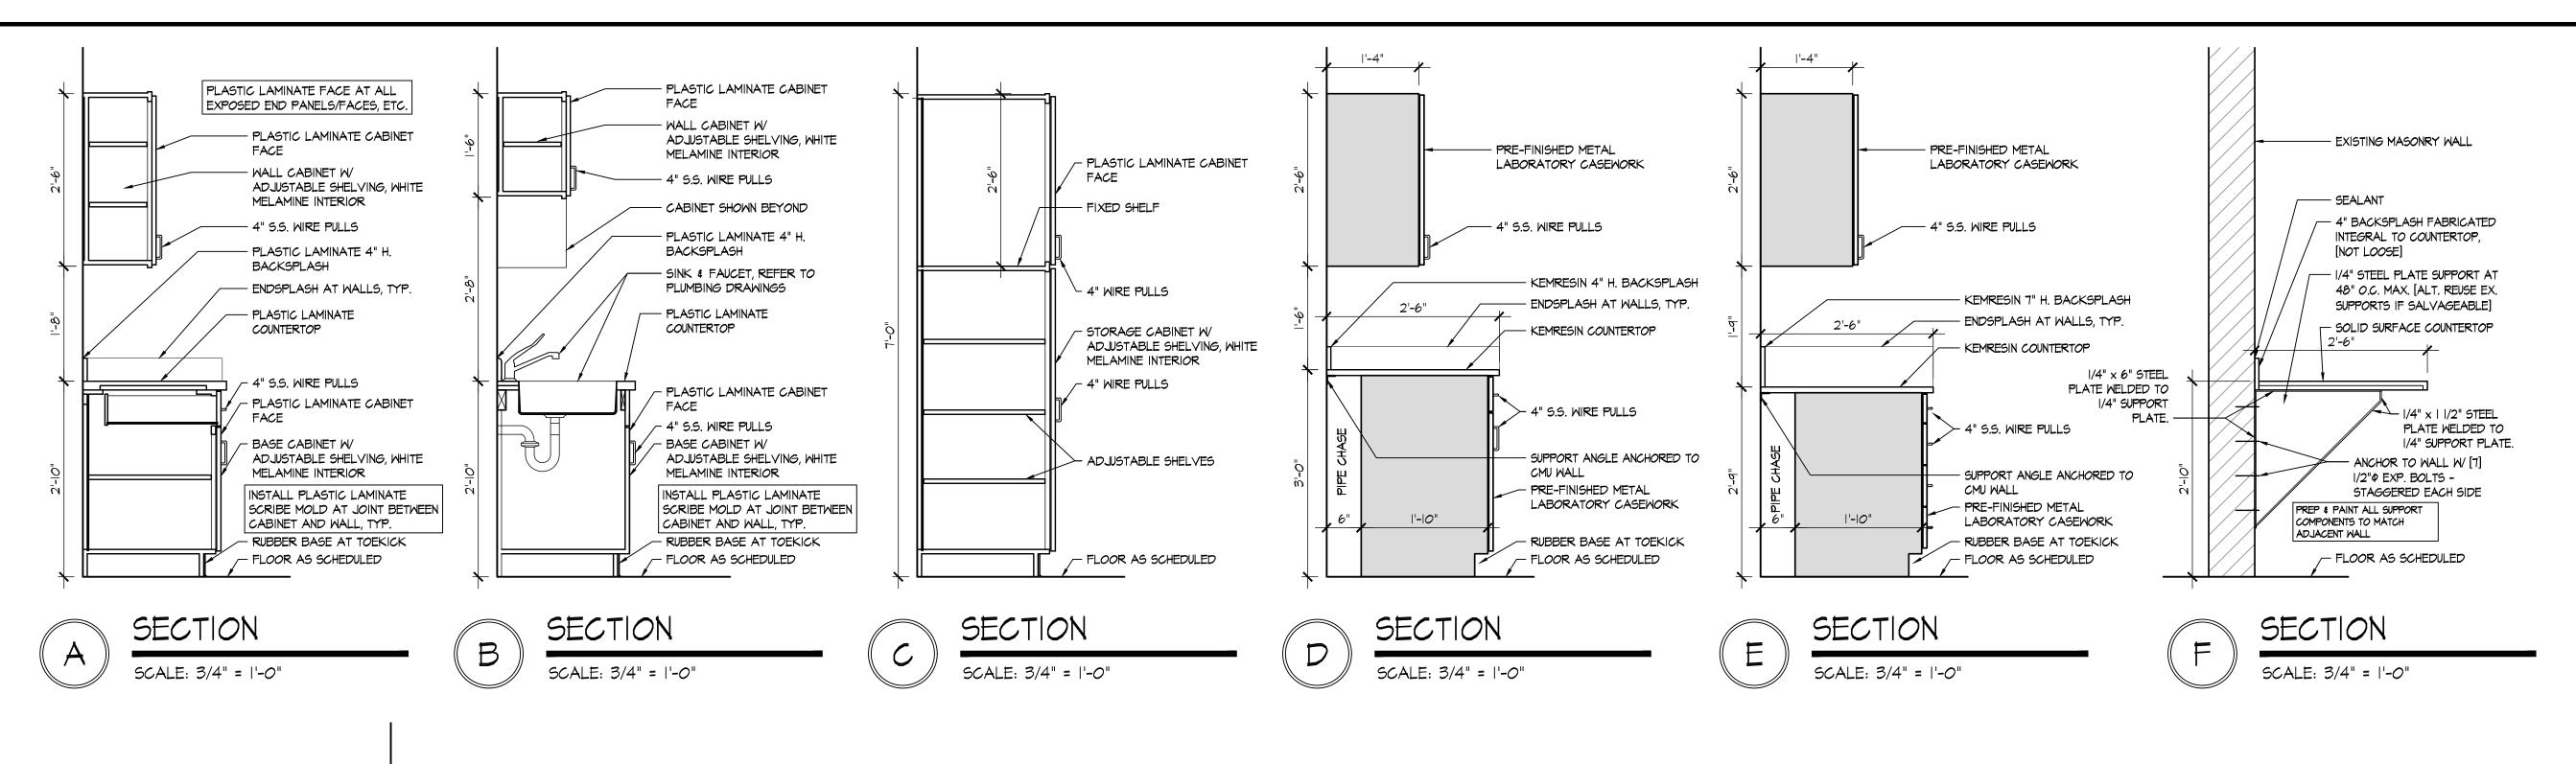Expiration Date 12/31/2023

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Print Record 10/11/21 PRELIMINARY 11/16/21 REVIEW 12/07/21 DESIGN REVIEW 01/11/22 REVIEW 01/24/22 BID SET/ CONSTRUCTION

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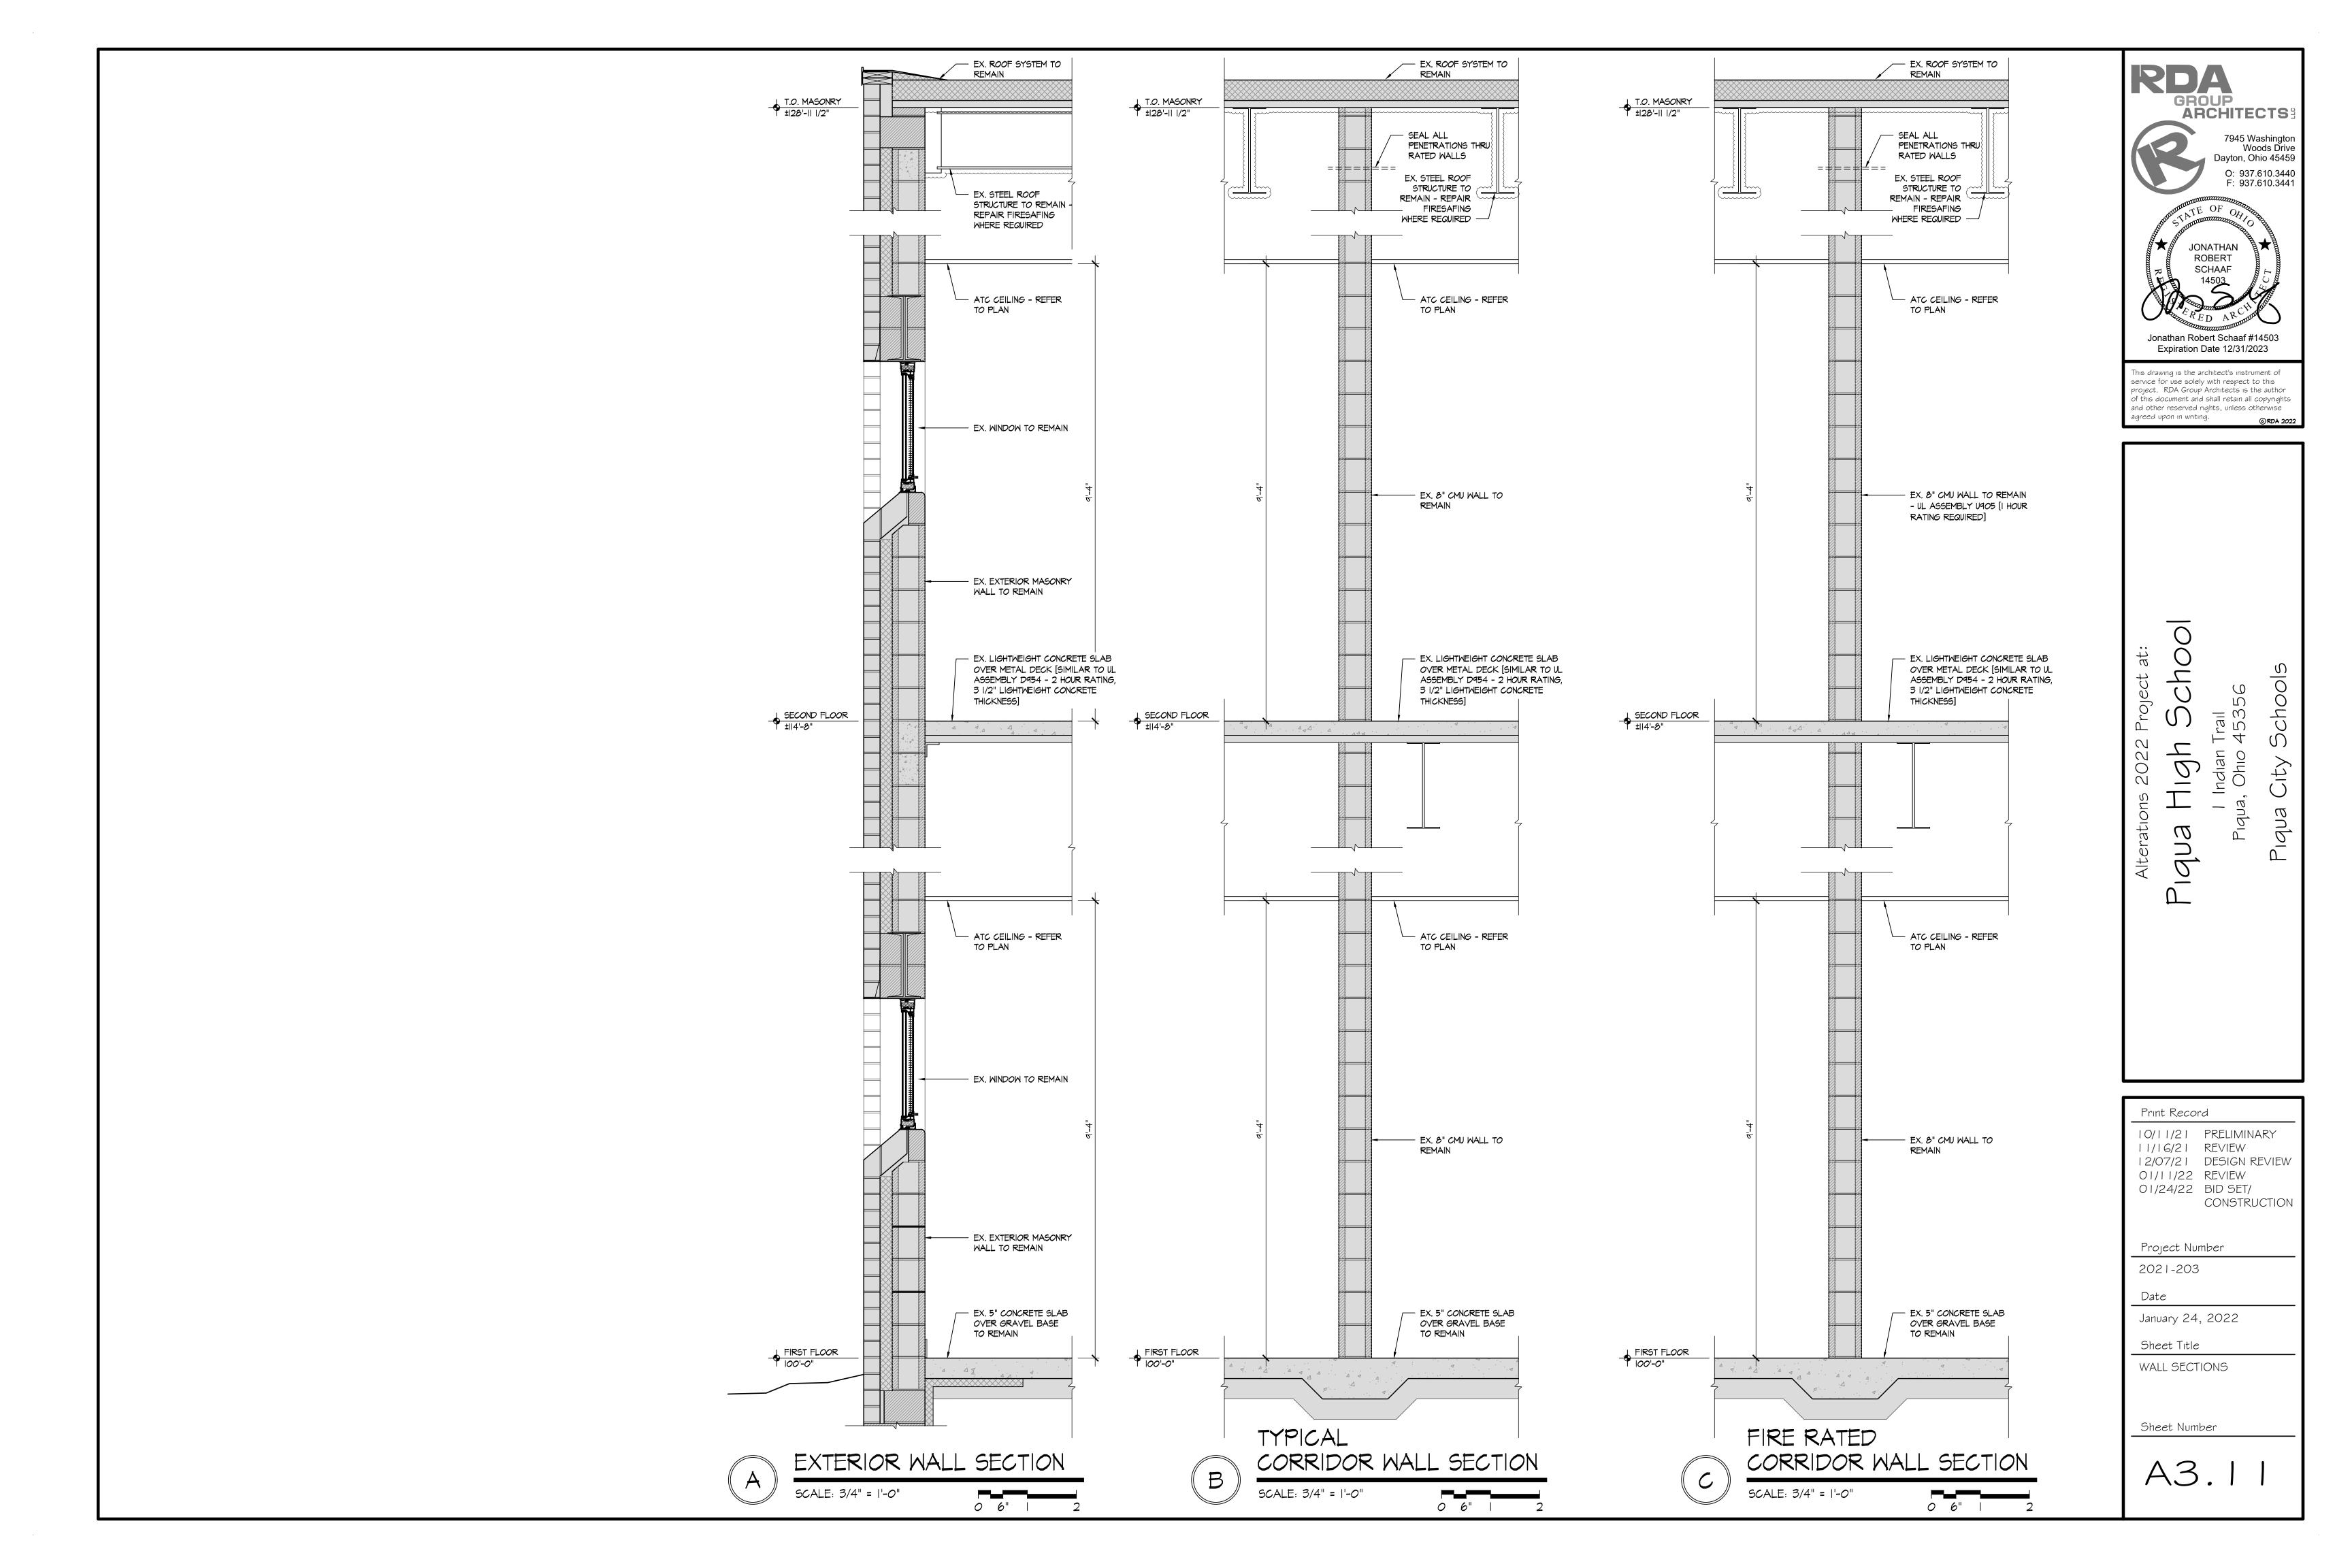
Date


January 24, 2022

Sheet Title

MILLWORK SECTIONS

Sheet Number



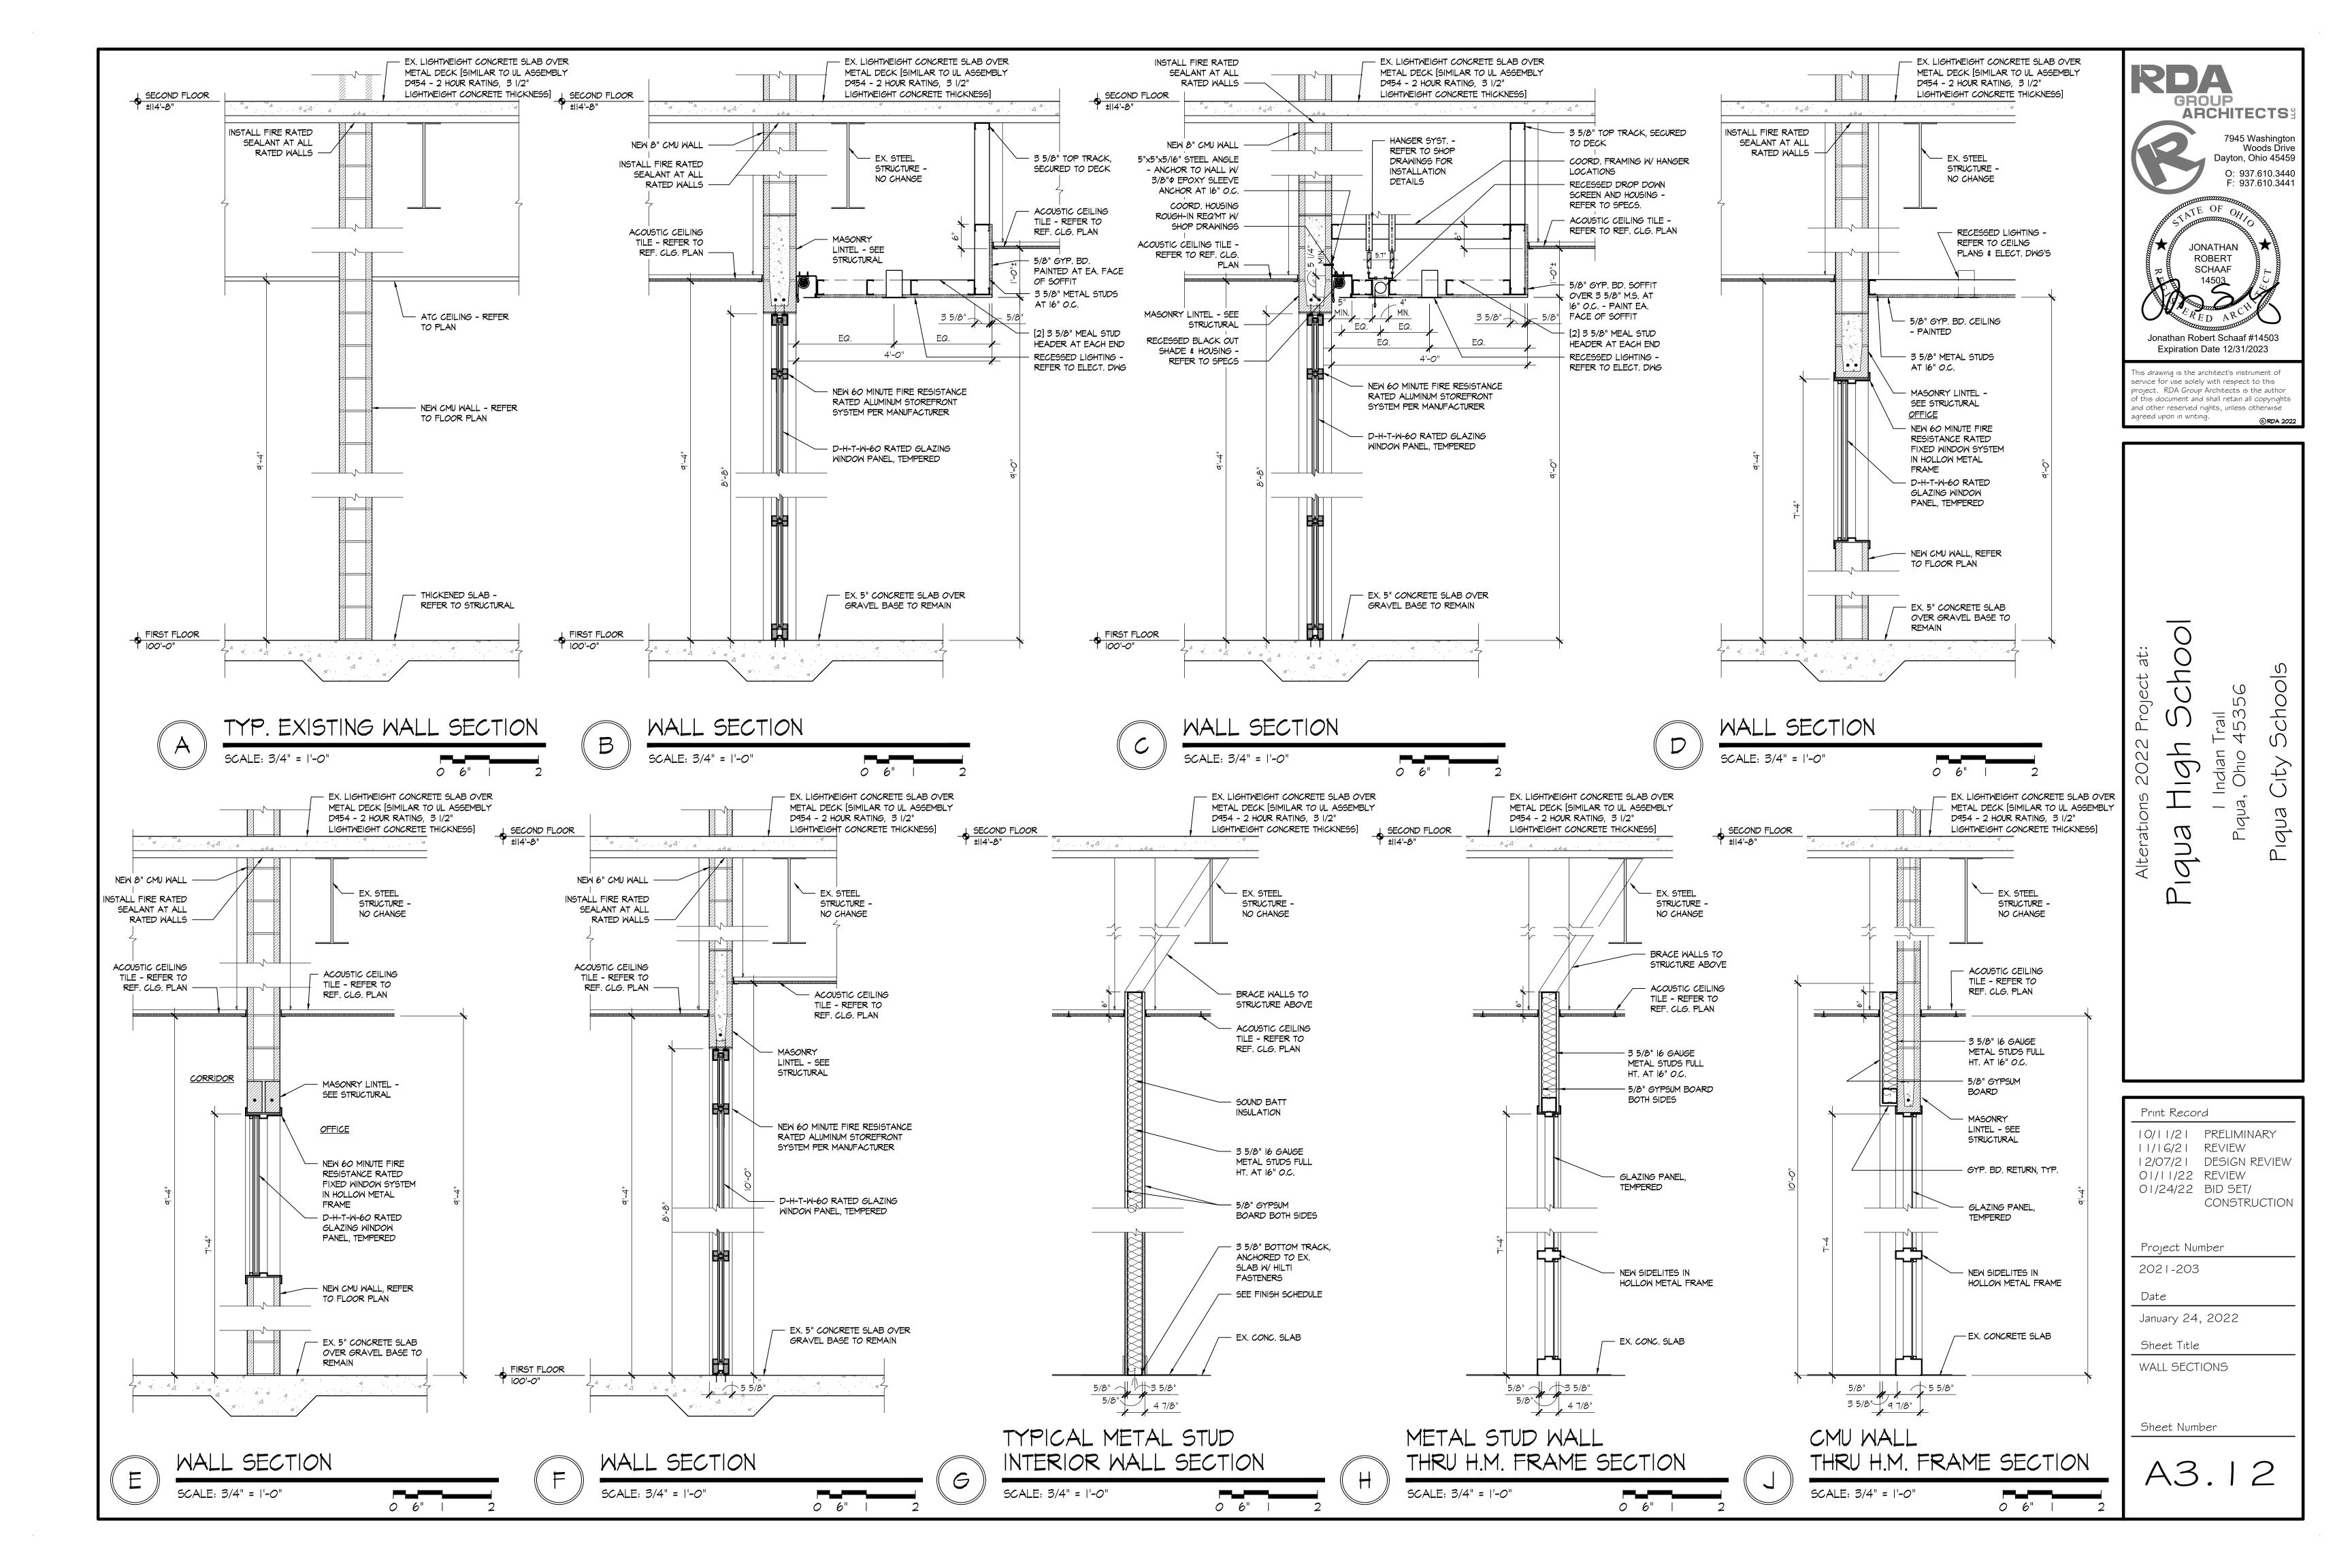

* TACK BOARD/MARKER BOARD SCHEDULE

#	DESCRIPTION
TB-I	4'-6" x 4'-0" - TACK BOARD
TB-2	4'-6" x 6'-0" - TACK BOARD
TB-3	4'-6" x 8'-0" - TACK BOARD
TB-4	4'-6" x 10'-0" - TACK BOARD
TB-5	4'-6" x 2'-0" - TACK BOARD
MB-I	4'-6" x 4'-0" - MAGNETIC MARKER BOARD - NO MAP RAIL
MB-2	4'-6" x 6'-0" - MAGNETIC MARKER BOARD - NO MAP RAIL
MB-3	4'-6" x 8'-0" - MAGNETIC MARKER BOARD - NO MAP RAIL
MB-4	4'-6" x 10'-0" - MAGNETIC MARKER BOARD - NO MAP RAIL
MB-5	4'-6" x 12'-0" - MAGNETIC MARKER BOARD - NO MAP RAIL
MB-6	4'-6" x IO'-O" - MAGNETIC MARKER BOARD FOR PROJECTION NO MAP RAIL - NO MARKER TRAY
TS-I	2" HIGH - TACK STRIP - PROVIDED BY OWNER, INSTALLED BY CONTRACTOR

TACK STRIP - PROVIDED BY OWNER, INSTALLED BY CONTRACTOR TO MEET INTENT OF DRAWINGS. ADDITIONALLY CONTRACTOR SHALL INSTALL AN ADDITIONAL 200 LF OF TACK STRIP AT LOCATIONS NOT SHOWN ON DRAWINGS.

EX.:	EXISTING FINISH	H TO REMAIN	B-3:	RUBBER BASE
LOORING	METALLIC LIDES	THANE FLOOR FINISH -		COLOR: ROPPE BLACK USE WITH F-7
-1:	FIELD COLOR:	P 1020 DOLPHIN BASALT GRAY	B-4:	8" QUARTZ BASE COLOR: TO MATCH FLOOR
-2:	URETHANE FLOO COLOR: BASAL	OR FINISH - BORDER .T <i>G</i> RAY	<u>WALLS</u> W-1:	PAINTED WALL FINISH - P-I U.N.O.
-3:	RUBBER FLOOR SPLASH - 4 CO	RING - TARKETT - COLOR DLOR PATTERN	W-2:	PAINTED CORRIDOR WALL FINISH REFER TO A/A4.II
	FIELD COLOR TARKETT - COI	LOR SPLASH	W-3:	PRIME WALLS ONLY
	TEXTURE: HA		MALL COV	ÆRING:
		ECKLED 55 SILVER GREY SW 7588 SHOW STOPPER	WC-I:	WALL COVERING - RED MANUF: GERFLOR - SPM COLOR: POPPY
	CHIP COLOR:	WHITE	<u>CEILING</u> C-I:	EXISTING CEILING GRID TO REMAIN, AI T-BARS TO CREATE 2x2 GRID, PAINT & NEW GRID, INSTALL NEW 2x2 TILES.
	ACCENT COLOR TARKETT - COL TEXTURE: HA PATTERN: SPI	LOR SPLASH MMERED	C-2:	NEW 2 X 2 CEILING GRID AND NEW ACOUSTICAL TILES
	FIELD COLOR:	SM 7588 SHOW STOPPER SM 6524 COMMODORE	C-3:	EXISTING CEILING GRID TO REMAIN, REPLACE DAMAGED TILES AS REQUIR
	CHIP COLOR:		C-4:	EXISTING PLASTER CEILING TO REMAIL PAINT.
	ACCENT COLOR		C-5:	OPEN TO ABOVE - NO CEILING
	TEXTURE: HA		C-6:	NEW GYPSUM BOARD CEILING. PAINT.
	PATTERN: SPI	ECKLED SW 7035 AESTHETIC	PAINT:	
	CHIP COLOR:	WHITE SW 7588 SHOW	P-I:	GENERAL PAINT [WHITE] MANUF: SHERWIN WILLIAMS COLOR: AESTHETIC WHITE SW 7035
	CHIP COLOR:	STOPPER SM 6524 COMMODORE		FINISH: SEMI GLOSS
	ACCENT COLOR TARKETT - COL TEXTURE: HA PATTERN: SP	OR SPLASH MMERED ECKLED	P-2:	ACCENT PAINT [BLUE] MANUF: SHERWIN WILLIAMS COLOR: COMMODORE SW 6624 FINISH: SEMI GLOSS
	CHIP COLOR:	SW 6524 COMMODORE SW 7588 SHOW STOPPER SW 7035 AESTHETIC	P-3:	ACCENT PAINT [RED] MANUF: SHERWIN WILLIAMS COLOR: SHOW STOPPER 7588
	Orm GOLOIN:	WHITE		FINISH: SEMI GLOSS
:-4: :-5:	QUARTZ FLOOR	RING 'L FLAKE FLOORING	P-4:	DOOR/FRAME PAINT MANUF: SHERWIN WILLIAMS COLOR: MISSISSIPPI BRONZE BRZS
- J :		SIKA - BASALT <i>G</i> RAY		FINISH: SEMI GLOSS
	F 1410 F 1820	9 BLACK - 28% 9 GRANITE - 28% 9 WHITE - 28% 9 DARK BLUE - 16%	P-5:	CEILING/SOFFIT PAINT MANUF: SHERWIN WILLIAMS COLOR: WHITE FINISH: FLAT
-6:	CARPET TILE SHAW 2x2 TILE COLOR: ROUTI	S: DIFFUSE 54575 ES 75500	P-6:	CONTROL ROOM PAINT MANUF: SHERWIN WILLIAMS COLOR: BLACK FINISH: SATIN
:-7:		- BERTIVE ACTION 837 SMELTER	MILLWORK	<u>:</u>
- 8:	CONCRETE	031 SMILLTER	PL-I:	PLASTIC LAMINATE [CABINET FRONTS] MANUF: FORMICA
HRESHOLD -1:	<u>25</u> CARPET TILE -	URETHANE	PL-2:	COLOR: 464-58 GRAYSTONE PLASTIC LAMINATE [COUNTERTOPS]
-2:	URETHANE - CO		-	MANUF: WILSONART COLOR: 4761-60 MYSTIQUE MOUNT
- 3:	URETHANE - WA	NLK OFF	SOLID SUR	FACE:
-4:	RUBBER - URET	HANE	SS-I:	SOLID SURFACE
				MANUF: CORIAN

COORD. ALL SELECTIONS WITH OWNER PRIOR TO ORDERING. REFER TO SPECIFICATIONS FOR ADDITIONAL INFORMATION

RUBBER BASE COLOR: ROPPE 139 DEEP NAVY USE WITH F-3, F-6

8" EPOXY WALL BASE

COLOR: BASALT GRAY

USE WITH F-I, F-2

- CMU WALL -SEE FINISH SCHEDULE INSTALL JOINT SEALANT AT TOP OF BASE [COLOR MATCH TO BASE COLOR] TERMINATE FLUID APPLIED BASE BELOW FIRST GROUT LINE OF BLOCK - FLUID APPLIED INTEGRAL BASE W/6" BORDER - TIGHT CORNER FLUID APPLIED FLOOR VERIFY / MOCKUP W/ OWNER PRIOR TO INSTALL

EPOXY COVE BASE DETAIL

SCALE: 3" = 1'-0"

ROOM FINISH SCHEDULE

#	NAME	FLOOR	BASE	WALLS	CEILING	REMARKS
V-I	VESTIBULE	F-7	B-2	EX.	C-3	-
V - 2	VESTIBULE	F-7	B-2	EX.	C-3	-
V - 3	VESTIBULE	F-7	B-2	EX.	C-3	-
V -4	VESTIBULE	F-7	B-2	EX.	C-3	-
S-I	STAIR	F-7	B-2	EX.	C-3	FLOOR AT BOTTOM LANDING
S-2	STAIR	F-7	B-2	EX.	C-3	FLOOR AT BOTTOM LANDING
5-3	STAIR	F-7	B-2	EX.	C-3	FLOOR AT BOTTOM LANDING
S-4	STAIR	F-7	B-2	EX.	C-3	FLOOR AT BOTTOM LANDING
1001	CORRIDOR	F-I/F-2	B-I	W-2	C-3	-
1002	CORRIDOR	F-I/F-2	B-I	W-2	C-3	-
1003	CORRIDOR	F-I/F-2	B-I	W-2	C-3	-
1004	CORRIDOR	F-I/F-2	B-I	W-2	C-3	-
1005	CORRIDOR	F-I/F-2	B-I	W-2	C-3	ADD ALUM. OXIDE TEXTURE TO
1006	CORRIDOR	F-I/F-2	B-I	W-2	C-3	ADD ALUM. OXIDE TEXTURE TO
100	JANITOR	EX.	EX.	EX.	EX.	-
						-
100A	STAFF TOILET	EX.	EX.	EX.	EX.	
IOIA	GIRLS	EX.	EX.	EX.	EX.	-
IOIB	BOYS	EX.	EX.	EX.	EX.	-
1010	JANITOR	EX.	EX.	EX.	EX.	-
102	CLASSROOM	F-I/F-2	B-I	M-I	C-I	-
103	CLASSROOM	F-I/F-2	B-I	M-I	C-I	-
104	CLASSROOM	F-I/F-2	B-I	M-I	C-I	-
105	CLASSROOM	F-I/F-2	B-I	M-I	C-I	-
106	CLASSROOM	F-I/F-2	B-I	M-I	C-2	-
107	CLASSROOM	F-I/F-2	B-I	M-I	C-2	-
108	CLASSROOM	F-I/F-2	B-I	M-I	C-I	-
109	CLASSROOM	F-I/F-2	B-I	M-I	C-I	-
110	CLASSROOM	F-I/F-2	B-I	M-I	C-I	-
IIOA	STORAGE	F-I/F-2	B-I	M-I	C-I	-
III	MEDIA CENTER	EX.	EX.	EX.	EX.	_
112	CLASSROOM	F-I/F-2	B-I	M-I	C-I	-
II3	CLASSROOM	F-I/F-2	B-I	M-I	C-I	-
114	CUSTODIAN	F-I/F-2	B-I	M-I	C-I	-
115	CLASSROOM	F-I/F-2	B-I	M-I	C-I	-
116	CLASSROOM	F-I/F-2	B-I	M-I	C-I	-
IIT	STORAGE	F-I/F-2	B-I	M-I	C-I	-
118	CLASSROOM	F-I/F-2	B-I	M-I	C-I	-
119	CLASSROOM	F-I/F-2	B-I	M-I	C-I	-
120	FUTURE CAFE	F-8	-	W-3	C-5	-
120A	FUTURE STORAGE	F-8	-	W-3	C-5	-
121	STUDENT FORUM	F-3	B-2	M-I	C-2/C-6	-
122	STUDENT FORUM	F-6	B-2	M-I	C-2/C-6	-
122A	CONFERENCE	F-6	B-2	M-I	C-2	-
122B	STORAGE	F-6	B-2	M-I	C-2	-
123	COUNSELING OFFICE	F-6	B-2	M-I	C-6	-
123A	CORRIDOR	F-6	B-2	M-I	C-2	-
123B	FILES/STORAGE	F-6	B-2	M-I	C-2	-
			B-2		C-2	_
1230	OFFICE	F-6		M-I		-
123D	OFFICE	F-6	B-2	M-I	C-2	
123E	OFFICE	F-6	B-2	M-I	C-2	-
123F	OFFICE	F-6	B-2	M-I	C-2	-
1236	CONFERENCE	F-6	B-2	M-I	C-2	-
124	CLASSROOM	F-I/F-2	B-I	M-I	C-2	-
125	CLASSROOM	F-I/F-2	B-I	M-I	C-2	-
126	CLASSROOM	F-I/F-2	B-I	M-I	C-2	-
127	CLASSROOM	F-I/F-2	B-I	M-I	C-I	-
128	CLASSROOM	F-I/F-2	B-I	M-I	C-I	-
	STAFF LOUNGE	EX.	EX.	EX.	EX.	-
129	CLASSROOM	F-I/F-2	B-I	M-I	C-2	-
129 130		F-I/F-2	B-I	M-I	C-I	-
130	STORAGE	1// ~	B-2	M-I	C-4	_
130 130A	STORAGE FLEVATOR FOURMENT	F_A	I — /	7.1-1		-
130 130A 303	ELEVATOR EQUIPMENT	F-8		lal I	· · ·	
130 130A 303 304	ELEVATOR EQUIPMENT CORRIDOR	F-6	B-2	M-I	C-2	
130 130A 303 304 304A	ELEVATOR EQUIPMENT CORRIDOR OFFICE	F-6 F-6	B-2 B-2	M-I	C-I	-
130 130A 303 304 304A 304B	ELEVATOR EQUIPMENT CORRIDOR OFFICE OPEN OFFICE	F-6 F-6 F-6	B-2 B-2 B-2	M-I	C-I C-2	-
130 130A 303 304 304A 304B 304C	ELEVATOR EQUIPMENT CORRIDOR OFFICE OPEN OFFICE OFFICE	F-6 F-6 F-6	B-2 B-2 B-2 B-2	M-I M-I M-I	C-I C-2 C-I	-
130 130A 303 304 304A 304B	ELEVATOR EQUIPMENT CORRIDOR OFFICE OPEN OFFICE OFFICE OFFICE	F-6 F-6 F-6	B-2 B-2 B-2	M-I	C-I C-2	-
130 130A 303 304 304A 304B 304C	ELEVATOR EQUIPMENT CORRIDOR OFFICE OPEN OFFICE OFFICE	F-6 F-6 F-6	B-2 B-2 B-2 B-2	M-I M-I M-I	C-I C-2 C-I	-

- a. FLOORING CONTRACTOR SHALL CONFIRM ALL TRANSITIONS BETWEEN ROOMS, CORRIDORS, EXISTING DEMOLITION OF FLOOR TILE, EXISTING CONCRETE, ETC.
- FIELD VERIFY HEIGHTS OF FLOOR FINISH / SLAB AFTER DEMOLITION OF EXISTING FLOOR FINISHES AND FLOAT EXISTING FLOOR UP WITH FLOOR LEVELER AS REQUIRED TO ALIGN WITH NEW FLOOR FINISHES.
- SKIM, FLOAT, SLOPE FLOOR AS REQUIRED BETWEEN VARIOUS FLOOR LEVELS. COMPLY WITH ADAAG SECTION 3030 FOR ALL CHANGE IN LEVELS. PROVIDE THRESHOLD / TRANSITION STRIP ONLY IN LOCATIONS WHERE FLOATING THE FLOOR WILL NOT WORK FOR THE
- d. PROVIDE ALL PREP WORK FOR PROPOSED FINISHES AS NOTED.
- e. ALL COLORS/FINISHES AS SELECTED BY OWNER. COORD. ALL FINISHES WITH OWNER PRIOR TO ORDERING.

CONSTRUCTION Project Number

Print Record

10/11/21 PRELIMINARY

12/07/21 DESIGN REVIEW

11/16/21 REVIEW

01/11/22 REVIEW

01/24/22 BID SET/

2021-203

GROUP ARCHITECTS

JONATHAN ROBERT SCHAAF

Jonathan Robert Schaaf #14503 Expiration Date 12/31/2023

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2022

Alterati

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7945 Washingtor Woods Drive Dayton, Ohio 45459

O: 937.610.3440 F: 937.610.3441

Date


January 24, 2022

Sheet Title

FINISH SCHEDULE


Sheet Number

A4.1

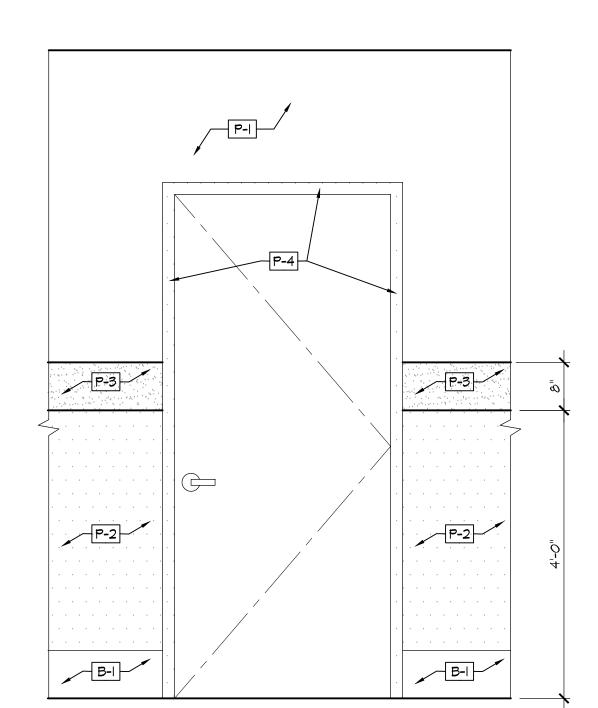



SCALE: 3/8" = 1'-0"

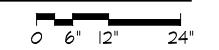



SCALE: 3" = 1'-0"

DIFFERENCE, FLOAT / SLOPE FLOORING IF POSSIBLE IN LIEU OF THRESHOLD

- DOOR FRAME OPENING

METALLIC EPOXY FLOOR

TRANSITION

- DOOR FRAME OPENING

-METALLIC EPOXY FLOOR

FIELD VERIFY SLAB ELEVATION

S.S. THRESHOLD -

SCALE: 3" = 1'-0"

BEYOND -

FINISH ---

STRIP DETAIL

- RUBBER TRANSITION

BEYOND -

— CARPET

STRIP



March	DOC	R SCHEDUL	E.											DOC	OR SCHED	PULE									
Section Sect				_							FRA	ME DE	TAILS										FRAN	1E DET	AILS
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Dec Surf No. Dec	124	3'-4" × 7'-4"		F-3	•		D-8	38.0	-		H5	J4	53	302B	3'-0" X 7'-4"		F-3		D-19	14.0	-	1, 3, 30	•	-	-
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Book 3-01 x 7-44	129	3'-0" × 7'-4"	•	F-3		•	1	1			-	-	-	3040	3'-0" × 7'-4"				D-19	17.0	-	1, 3, 30	-	_	-
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S00-8 S-44 X T-44	1005-B	3'-4" × 7'-4"	•	F-3	•		D-12	13.2	90	20, 21	-	-	-	306-B	[2] 2'-IO" X 7'-4"			+	D-16	40.2	-		H4	J3/J6	53
SOLA S-0' X T-44'			•	_	+-+	_	+	+	-		-	1	-					+	_					J3	
200A 3-0* X T-4*	1006-8	3'-4" X 1'-4"		+-3			D-12	13.2	90	20, 21		-	-			+~+		+~+		 		a			
204 9-0**X****** 0 F5 0 0 0 4 6 0 4 6 6 0 4 6 6 0 4 6 6 0 4 6 6 0 4 6 6 6 0 4 6 6 0 6 6 6 6 6 6 6	2010	3'-0" × 7'-4"	•	F-3		•	D-4	6.0	-	4, 6, 8, 17	T -	-	-			+-+-		 	_	1			-		-
205 8'-0' XT-4'	203		•	_	+		1	1	-	1, 3, 18, 19	-	-	-				-	+ + -			-		-	-	-
206 3-0' X T-4' 0 F-5 0 D-1 34 -			_	_	+		1	+	+		-		-			+ + - + -		+	_				-		-
207 3'4' X T-4"				_	+		1	+	_		-		-			+-+-		+	_	 					
2008 3'-4' X T-4'			_	_	+	•	1	+	_	<u> </u>	_			<u> </u>		+-+-		+~+	_	1	-				
208A 3-4" X T-4" 0 F-5 0 D-4 8 - 4,6,1T - - - -	-		•	_	+		+	+	60	4, 6, 17, 20	-	-	-			 	F-2				-		HI	L	52
204 3-4' X 7-4' F-3 D-5 B-0 -				_	+		+	+	+	1	-		-			+ + +	-	+ + - +	_	1			-		-
210-A 3'-4' X T-4'				_	+		1	+			-		-			 	_	+	_		1		_		-
210-B 3'-4' X T'-4'			-	_	+		+	+	+				_			 		+		 					_
2 1 5'-4' X 7'-4'			•	_	+		+	+	+	1	-	-	-			 	+	 	_		-		-	-	-
215 3:-4" x 7:-4"			-	_	+		+	+	_		-		-			+ + +	+	 	_		-		-		-
214 3'-0' X T-4'				_	+		+	+	_		-	-	-			 	+	 	_				_		-
215 3'-4" X T'-4"			•		+	•	1	1	_		-	-	-				_		_	-			-	-	-
216A 3'-4' X T'-4"	215			_	+		D-8	18.0) -		-	-	-	3 3-B		•	+		D-I	11.1			-	_	-
217 3'-4" X 7'-4"				_	+		1	1	_		-		-					$+$ $\overline{-}+$ $\overline{-}+$	_				-		-
218-A 3'-0" X T'-4"				_	+		+	+	_		-		-			 	+		_	 			-		-
218-B 3'-0" X T'-4"				_	+		+	+	_		-		-			 	-	+ - + - +					-		-
220 3'-4" X T'-4"				_	+	•	+	+	_	<u> </u>							+	+ + +							_
22 3'-4" X T'-4"			•	+	+ +		+	+	+	1, 3, 5	-	-	-	_/_/				-1 1 1	-4		///		///	<u> </u>	/-/
222 3'-4" X 7'-4"				_	+		+	+	_		-		-			1 1 1	+	+ + +	_				-		-
223 3'-4" X 7'-4"				+	+ +		1	1	-		-		-			 	_	+ + - +	_				-		-
224 3'-4" X 7'-4"				_	+	•	+	+	-	<u> </u>	-		-			1 1 1	-	+ + + +	_				-		-
225-B 3'-4" X 7'-4"				+	+ +		+	+	_		-	-	-			 	_	- - 	_	1			-	_	_
				+	+ +		+	+	_		-		-			 		+	_	-	-	2, 3	-		-
				_	+		+	+	+	1	-	+	-			+-+-		+		 		3	HI -		52
				1, -5	1 1		۱-۰	1 5.0	1 50	1, 0, 11, 27					-10 0 7 1-4		<u> </u>		דויים	10.2	1 -				ائے


#		UL												<i>y</i> =:	
	SIZE	FF MAN	/_	SALV. IT	FRAME TYPE	MIN	EXIST.	SALV.	DOOR TYPE	HDWR. SET#	FIRE RAT'G	REMARKS	FRAN HEAD	JAMB	SILL
3 5-B	2'-0" × 4'-0" 3'-4" × 7'-4"	/	9		F-3/ F-3	_	Ø	\angle	D-8	180	///	NO WORK THIS OPENING	<u>/</u> /	<u>/-</u> /	<u> </u>
316-A 316-B	3'-4" × 7'-4" [2] 3'-0" × 7'-0"				F-3 F-3	_			D-8 D-6	18.0 6.0	-	1, 3, 5 4, 6	-	-	- -
316-6	3'-4" X 7'-4"	•			F-3	•			D-23	25.0	-	1, 0	H3		52
316A	3'-0" X 7'-4"		•		F-3		•		D-I	17.0	-	1, 3	-	-	-
317	3'-4" × 7'-4"		•		F-3		•		D-8	18.0	-	1, 3, 5, 18	-	-	-
318-A	3'-4" × 7'-4"		•		F-3		•		D-8	18.0	-	1, 3, 5	-	-	-
318-B	3'-4" × 7'-4"		•		F-3		•		D-I	19.0	-	1, 3	-	-	-
318A-A	3'-0" X 7'-4"		•		F-3			L	D-I	17.0		1, 3	-	-	-
318A-B	3'-0" X 7'-4"		•		F-3		•		D-I	17.0	-	1, 3	-	-	-
319	3'-4" X 7'-4"		•		F-3	_	•	_	D-8	18.0	-	1, 3, 5, 18, 19	-	-	-
320-A	[2] 3'-0" X 7'-4"		•		F-3			_	D-14	17.5	-	2, 3	- -	-	-
320-B 321	[2] 3'-0" X 7'-4" 3'-4" X 7'-4"				F-3 F-3				D-14 D-8	42.0 18.0	-	351212	HI -	_ _	52
322-A	2'-4" X 7'-4"				F-3	\vdash		\vdash	D-0	6.0	-	1, 3, 5, 18, 19 4, 17	-	-	- -
322-B	2'-4" X 7'-4"				F-3	\vdash			D-I	6.0	-	4, 17	-	<u>-</u>	- -
322-C	2'-4" X 7'-4"		•		F-3		•		D-I	6.0	-	4, 17	-	-	-
322-D	2'-4" X 7'-4"		•		F-3		•		D-I	6.0	-	4, 17	-	-	-
322-E	2'-4" X 7'-4"				F-3		•		D-I	6.0	-	4, 17	-	-	-
322-F	3'-0" X 7'-4"		•		F-3		•		D-I	6.0	-	4, 17	-	-	-
322-6	3'-0" X 7'-4"		•		F-3		•		D-I	6.0	-	4, 17	-	-	_
322-H	2'-4" X 7'-4"		•		F-3		•		D-I	6.0	-	4, 17	-	-	-
322-J	2'-4" X 7'-4"		•		F-3		•		D-I	6.0	-	4, 17	-	-	_
322-K	2'-4" X 7'-4"		•		F-3		•		D-I	6.0	-	4, 17	-	-	-
322A	2'-8" X 7'-4"		•		F-3	_	•	_	D-I	29.0	-	4, 17	-	-	-
322B	4'-0" X 7'-4"		•		F-3	\vdash		\vdash	D-4	27.0	-	4, 6, 17	<u>-</u>	-	-
322C 323-A	4'-0" X 7'-4"		•		F-3 F-3	-			D-4	27.0	- 45	4, 6, 17	- <u>-</u>	- -	- -
323-A 323-B	[2] 3'-0" X 7'-4" 3'-4" X 7'-4"		•		F-3 F-3	\vdash		\vdash	D-14 D-33	17.6 15.0	45 45	2, 3, 20	-	-	- -
323-B	3'-0" X 7'-4"		•		F-3	\vdash		\vdash	D-1	17.0	4 5 -	1, 3, 18, 19 1, 3	-	-	<u> </u>
323B	3'-4" × 7'-4"		•		F-3	\vdash		\vdash	D-1	17.0	-	1, 3	-	<u>-</u>	<u>-</u>
323C-A	3'-4" X 7'-4"		•		F-3	\vdash	•	\vdash	D-I	17.0	-	1, 3	-	-	-
323C-B	3'-4" × 7'-4"		•		F-3		•		D-I	17.0	-	1, 3	-	-	-
323D	3'-4" × 7'-4"		•		F-3		•		D-9	17.0	-	1, 3	-	-	-
323E-A	3'-4" X 7'-4"		•		F-3		•		D-8	17.0	-	1, 3	-	-	-
323E-B	4'-0" × 7'-4"	•			F-2	•			D-30	35.0	-		н	J	52
323F	3'-0" X 7'-4"		•		F-3		•		D-4	7.0	-	1, 3	-	-	-
324-A	[2] 3'-0" X 7'-4"		•		F-3		•		D-14	17.6	45	2, 3	-	-	-
324-B	3'-0" X 7'-4"				F-3				D-33	15.0	45	1, 3	-	-	-
,			-		<u> </u>	-	_	_					I	I	<u> </u>
400-A	3'-8" X 7'-4"		•		F-3	•	_	_	D-8	11.2	-	1, 3, 5, 18, 19, 24	-	-	-
400-B	[2] 3'-0" X 7'-4"		•		F-3		_	_	D-7	9.0	-	1, 3, 5, 12, 18, 19, 24	-	-	-
400-C	[2] 3'-0" X 7'-4"		•		F-3		\vdash	\vdash	D-7	9.0	-	1, 3, 5, 12, 18, 19, 24	<u>-</u>	-	-
400-D	3'-8" X T'-4" 3'-8" X T'-4"				F-3 F-2		\vdash	\vdash	D-8 D-9	11.2 23.0	-	1, 3, 5, 18, 19, 24	- HI	_ 	- 52
400-E	[2] 3'-0" X 7'-4"			\vdash	F-2		\vdash		D-14	26.0	-	13	HI	J3 J3	52
400-6	[2] 3'-0" X 7'-4"				F-2		\vdash	\vdash	D-14 D-14		-	13			52
400-H	3'-8" × 7'-4"	-	-	_	. –		1	1					HI	J3	
400A					F-2	•			D-9	23.0	-		HI	J3 J3	
400B	[2] 3'-0" X 7'-4"		•		F-3	•			D-9 D-22			3, 25			
_ - 000	[2] 3'-0" X 7'-4" [2] 3'-0" X 7'-4"		•			•				23.0	-	3, 25 3, 25	HI	JЗ	52
401			F		F-3	•	•		D-22	23.0 17.7	-		HI -	J3 -	52
	[2] 3'-0" X 7'-4"		•		F-3	•	•		D-22 D-22	23.0 17.7 17.7	-	3, 25	HI -	J3 - -	52 - -
401 401A 402	[2] 3'-0" X 7'-4" 3'-4" X 7'-4" 3'-0" X 7'-4" 3'-0" X 7'-4"		•		F-3 F-3 F-3 F-3	•			D-22 D-22 D-8 D-1 D-1	23.0 17.7 17.7 8.0 17.0 20.0	-	3, 25 1, 3, 5, 18, 19	HI	J3 - -	52 - -
401 401A 402 402A	[2] 3'-0" X 7'-4" 3'-4" X 7'-4" 3'-0" X 7'-4" 3'-0" X 7'-4" 3'-0" X 7'-4"		•		F-3 F-3 F-3 F-3 F-3	•	•		D-22 D-22 D-8 D-1 D-1 D-1	23.0 17.7 17.7 18.0 17.0 20.0		3, 25 1, 3, 5, 18, 19 1, 3 1, 3 4, 6, 17	HI	J3 - - -	52 - - -
401 401A 402 402A 402B	[2] 3'-O" X 7'-4" 3'-4" X 7'-4" 3'-O" X 7'-4" 3'-O" X 7'-4" 3'-O" X 7'-4" 3'-O" X 7'-4"		•		F-3 F-3 F-3 F-3 F-3 F-3	•	•		D-22 D-22 D-8 D-1 D-1 D-1	23.0 17.7 17.7 18.0 17.0 20.0 6.0 17.0	-	3, 25 1, 3, 5, 18, 19 1, 3 1, 3 4, 6, 17 1, 3	HI		52 - - - -
401 401A 402 402A 402B 402C	[2] 3'-0" X 7'-4" 3'-4" X 7'-4" 3'-0" X 7'-4" 3'-0" X 7'-4" 3'-0" X 7'-4" 3'-0" X 7'-4" 3'-0" X 7'-4"		• • • • • • • • • • • • • • • • • • •		F-3 F-3 F-3 F-3 F-3 F-3 F-3	•	•		D-22 D-8 D-1 D-1 D-1 D-1 D-1 D-1	23.0 17.7 17.7 18.0 17.0 20.0 6.0 17.0		3, 25 1, 3, 5, 18, 19 1, 3 1, 3 4, 6, 17 1, 3 1, 3, 14	HI		52 - - - -
401 401A 402 402A 402B 402C 403A-A	[2] 3'-O" X 7'-4" 3'-4" X 7'-4" 3'-O" X 7'-4"		•		F-3 F-3 F-3 F-3 F-3 F-3 F-3		•		D-22 D-8 D-1 D-1 D-1 D-1 D-4 D-4	23.0 17.7 18.0 17.0 20.0 6.0 17.0 17.1 17.0		3, 25 1, 3, 5, 18, 19 1, 3 1, 3 4, 6, 17 1, 3 1, 3, 14 1, 3, 14	HI		52 - - - - - -
401 401A 402 402A 402B 402C 403A-A 403A-B	[2] 3'-O" X 7'-4" 3'-4" X 7'-4" 3'-O" X 7'-4"				F-3 F-3 F-3 F-3 F-3 F-3 F-3 F-3 F-3		• • • • • • • • • • • • • • • • • • •		D-22 D-8 D-1 D-1 D-1 D-1 D-4 D-4 D-8	23.0 17.7 17.7 18.0 17.0 20.0 6.0 17.0 17.0 17.0		3, 25 1, 3, 5, 18, 19 1, 3 1, 3 4, 6, 17 1, 3 1, 3, 14 1, 3, 14 1, 3, 5	HI		
401 401A 402A 402A 402B 402C 403A-A 403A-B 403B	[2] 3'-O" X 7'-4" 3'-0" X 7'-4" 3'-O" X 7'-4"				F-3 F-3 F-3 F-3 F-3 F-3 F-3 F-3 F-3		•		D-22 D-8 D-1 D-1 D-1 D-4 D-4 D-8 D-8	23.0 17.7 17.7 18.0 17.0 20.0 6.0 17.0 17.0 17.0 17.0		3, 25 1, 3, 5, 18, 19 1, 3 1, 3 4, 6, 17 1, 3 1, 3, 14 1, 3, 14 1, 3, 5 1, 3, 26	HI		52 - - - - - - -
40I 40IA 402A 402B 402C 403A-A 403A-B 403B 403C	[2] 3'-O" X 7'-4" 3'-4" X 7'-4" 3'-O" X 7'-4"				F-3 F-3 F-3 F-3 F-3 F-3 F-3 F-3 F-3		•		D-22 D-8 D-1 D-1 D-1 D-4 D-4 D-8 D-8	23.0 17.7 18.0 17.0 20.0 6.0 17.0 17.0 17.0 17.0 17.0		3, 25 1, 3, 5, 18, 19 1, 3 1, 3 4, 6, 17 1, 3 1, 3, 14 1, 3, 14 1, 3, 5 1, 3, 26 1, 3, 26	HI		52 - - - - - - - -
401 401A 402A 402A 402B 402C 403A-A 403A-B 403B	[2] 3'-O" X 7'-4" 3'-0" X 7'-4" 3'-O" X 7'-4"				F-3 F-3 F-3 F-3 F-3 F-3 F-3 F-3 F-3		•		D-22 D-8 D-1 D-1 D-1 D-4 D-4 D-8 D-8	23.0 17.7 17.7 18.0 17.0 20.0 6.0 17.0 17.0 17.0 17.0		3, 25 1, 3, 5, 18, 19 1, 3 1, 3 4, 6, 17 1, 3 1, 3, 14 1, 3, 14 1, 3, 5 1, 3, 26 1, 3, 26 1, 3, 18, 19	HI		52 - - - - - - -
40IA 402A 402B 402C 403A-A 403A-B 403B 403C 403D	[2] 3'-O" X 7'-4" 3'-4" X 7'-4" 3'-O" X 7'-4"				F-3 F-3 F-3 F-3 F-3 F-3 F-3 F-3 F-3 F-3				D-22 D-8 D-1 D-1 D-1 D-4 D-4 D-8 D-8 D-8 D-1	23.0 17.7 18.0 17.0 20.0 6.0 17.0 17.0 17.0 17.0 17.0		3, 25 1, 3, 5, 18, 19 1, 3 1, 3 4, 6, 17 1, 3 1, 3, 14 1, 3, 14 1, 3, 5 1, 3, 26 1, 3, 26 1, 3, 18, 19 1, 3, 18, 19	HI		
40I 40IA 402A 402B 402C 403A-A 403A-B 403B 403C 403D 403E	[2] 3'-O" X T'-4" 3'-4" X T'-4" 3'-O" X T'-4"				F-3 F-3 F-3 F-3 F-3 F-3 F-3 F-3 F-3 F-3				D-22 D-8 D-1 D-1 D-1 D-4 D-8 D-8 D-8 D-1 D-1	23.0 17.7 18.0 17.0 20.0 6.0 17.0 17.0 17.0 17.0 17.0 17.0		3, 25 1, 3, 5, 18, 19 1, 3 1, 3 4, 6, 17 1, 3 1, 3, 14 1, 3, 14 1, 3, 5 1, 3, 26 1, 3, 26 1, 3, 18, 19	HI	J3	
40I 401A 402A 402B 402C 403A-A 403A-B 403B 403C 403D 403E 403F	[2] 3'-O" X 7'-4"				F-3 F-3 F-3 F-3 F-3 F-3 F-3 F-3 F-3 F-3				D-22 D-8 D-1 D-1 D-1 D-4 D-8 D-8 D-8 D-1 D-1 D-1 D-1	23.0 17.7 18.0 17.0 20.0 6.0 17.0 17.0 17.0 17.0 17.0 17.0 17.0		3, 25 1, 3, 5, 18, 19 1, 3 1, 3 4, 6, 17 1, 3 1, 3, 14 1, 3, 14 1, 3, 5 1, 3, 26 1, 3, 26 1, 3, 18, 19 1, 3, 18, 19 1, 3	HI	J3	500
40I 40IA 402A 402B 402C 403A-A 403A-B 403B 403C 403D 403E 403F 4036	[2] 3'-O" X 7'-4" 3'-4" X 7'-4" 3'-O" X 7'-4"				F-3 F-3 F-3 F-3 F-3 F-3 F-3 F-3 F-3 F-3				D-22 D-8 D-1 D-1 D-1 D-4 D-8 D-8 D-8 D-1 D-1 D-1 D-1	23.0 17.1 18.0 17.0 20.0 6.0 17.0 17.0 17.0 17.0 17.0 17.0 17.0 17.0		3, 25 1, 3, 5, 18, 19 1, 3 1, 3 4, 6, 17 1, 3 1, 3, 14 1, 3, 14 1, 3, 5 1, 3, 26 1, 3, 26 1, 3, 18, 19 1, 3, 18, 19 1, 3 1, 3	HI	J3	500
40I 40IA 402A 402B 402C 403A-A 403A-B 403B 403C 403D 403E 403F 4036 403H	[2] 3'-O" X 7'-4" 3'-4" X 7'-4" 3'-O" X 7'-4"				F-3 F-3 F-3 F-3 F-3 F-3 F-3 F-3 F-3 F-3				D-22 D-8 D-1 D-1 D-1 D-4 D-8 D-8 D-8 D-9 D-1 D-1 D-1 D-1 D-1 D-1 D-1	23.0 17.1 18.0 17.0 20.0 6.0 17.0 17.0 17.0 17.0 17.0 17.0 17.0 17.0 17.0		3, 25 1, 3, 5, 18, 19 1, 3 1, 3 4, 6, 17 1, 3 1, 3, 14 1, 3, 14 1, 3, 5 1, 3, 26 1, 3, 26 1, 3, 18, 19 1, 3, 18, 19 1, 3 1, 3 4, 6, 17	HI	J3	
40I 40IA 402A 402B 402C 403A-A 403B 403B 403B 403C 403D 403E 403F 403F 403H 403J	[2] 3'-O" X 7'-4"				F-3 F-3 F-3 F-3 F-3 F-3 F-3 F-3 F-3 F-3				D-22 D-8 D-1 D-1 D-1 D-4 D-8 D-8 D-8 D-1 D-1 D-1 D-1 D-1 D-1 D-1 D-1	23.0 17.7 18.0 17.0 20.0 6.0 17.0 17.0 17.0 17.0 17.0 17.0 17.0 17.0 17.0 17.0		3, 25 1, 3, 5, 18, 19 1, 3 1, 3 4, 6, 17 1, 3 1, 3, 14 1, 3, 14 1, 3, 5 1, 3, 26 1, 3, 26 1, 3, 18, 19 1, 3, 18, 19 1, 3 1, 3 4, 6, 17 4, 6, 17	HI	J3	52 - - - - - - - - - - - - - -
40I 40IA 402A 402B 402C 403A-A 403A-B 403B 403C 403D 403E 403F 403F 403H 403J 403L 403N	[2] 3'-O" X 7'-4"				F-3 F-3 F-3 F-3 F-3 F-3 F-3 F-3 F-3 F-3				D-22 D-8 D-1 D-1 D-1 D-4 D-8 D-8 D-9 D-1 D-1 D-1 D-1 D-1 D-1 D-1 D-1 D-1	23.0 17.7 18.0 17.0 20.0 6.0 17.0 17.0 17.0 17.0 17.0 17.0 17.0 17.0 17.0 17.0 17.0		3, 25 1, 3, 5, 18, 19 1, 3 1, 3 4, 6, 17 1, 3 1, 3, 14 1, 3, 14 1, 3, 5 1, 3, 26 1, 3, 26 1, 3, 18, 19 1, 3 1, 3 4, 6, 17 4, 6, 17 1, 3	HI	J3	500
40I 40IA 402A 402B 402C 403A-A 403A-B 403B	[2] 3'-O" X 7'-4" 2'-8" X 7'-4" 2'-8" X 7'-4"				F-3 F-3 F-3 F-3 F-3 F-3 F-3 F-3 F-3 F-3				D-22 D-8 D-1 D-1 D-1 D-4 D-8 D-8 D-8 D-9 D-1	23.0 17.1 18.0 17.0 20.0 6.0 17.0		3, 25 1, 3, 5, 18, 19 1, 3 1, 3 4, 6, 17 1, 3 1, 3, 14 1, 3, 14 1, 3, 5 1, 3, 26 1, 3, 26 1, 3, 18, 19 1, 3 1, 3 4, 6, 17 4, 6, 17 1, 3 4, 6, 17 1, 3 1, 3 1, 3	HI	J3	500
40I 40IA 402A 402B 402C 403A-A 403A-B 403B 403C 403D 403E 403F 403F 403H 403H 403L 403N 403P-A 403P-B 404	[2] 3'-O" X 7'-4"				F-3 F-3 F-3 F-3 F-3 F-3 F-3 F-3 F-3 F-3				D-22 D-8 D-1 D-1 D-1 D-4 D-8 D-8 D-8 D-1	23.0 17.1 18.0 17.0 20.0 6.0 17.0 1		3, 25 1, 3, 5, 18, 19 1, 3 1, 3 4, 6, 17 1, 3 1, 3, 14 1, 3, 14 1, 3, 5 1, 3, 26 1, 3, 26 1, 3, 18, 19 1, 3 1, 3 4, 6, 17 1, 3 4, 6, 17 1, 3 4, 6, 17 1, 3 1, 3 4, 6, 17 1, 3 1, 3 4, 6, 15, 17	HI	J3	52
40I 40IA 402A 402B 402C 403A-A 403A-B 403B 403C 403D 403E 403F 403F 403H 403J 403L 403N 403P-A 403P-B 404 405	[2] 3'-O" X T'-4" 3'-4" X T'-4" 3'-O" X T'-4"				F-3 F-3 F-3 F-3 F-3 F-3 F-3 F-3 F-3 F-3				D-22 D-8 D-1 D-1 D-1 D-4 D-8 D-8 D-8 D-9 D-1	23.0 17.1 18.0 17.0 20.0 6.0 17.0 1		3, 25 1, 3, 5, 18, 19 1, 3 1, 3 4, 6, 17 1, 3 1, 3, 14 1, 3, 14 1, 3, 5 1, 3, 26 1, 3, 26 1, 3, 18, 19 1, 3 1, 3 4, 6, 17 1, 3 4, 6, 17 1, 3 1, 3 4, 6, 17 1, 3 1, 3 4, 6, 17 1, 3 1, 3	HI	J3	52
40I 40IA 402A 402B 402C 403A-A 403A-B 403B 403C 403D 403E 403F 403F 403H 403J 403J 403L 403N 403P-A 403P-B 404 405 405A	[2] 3'-O" X 7'-4"				F-3 F-3 F-3 F-3 F-3 F-3 F-3 F-3 F-3 F-3				D-22 D-8 D-1 D-1 D-1 D-4 D-8 D-8 D-8 D-9 D-1	23.0 17.1 18.0 17.0 20.0 6.0 17.0 1		3, 25 1, 3, 5, 18, 19 1, 3 4, 6, 17 1, 3 1, 3, 14 1, 3, 14 1, 3, 5 1, 3, 26 1, 3, 26 1, 3, 18, 19 1, 3 1, 3 4, 6, 17 4, 6, 17 1, 3 1, 3 4, 6, 17 1, 3 1, 3 1, 3 1, 3 1, 3 1, 3 1, 3 1, 3	HI	J3	52
40I 40IA 402A 402B 402C 403A-A 403B 403B 403C 403B 403B 403E 403B 405B 405B	[2] 3'-O" X 7'-4" 3'-A" X 7'-4" 3'-O" X 7'-4"				F-3 F-3 F-3 F-3 F-3 F-3 F-3 F-3 F-3 F-3				D-22 D-8 D-1 D-1 D-1 D-4 D-8 D-8 D-8 D-9 D-1	23.0 17.1 17.1 18.0 17.0 20.0 17.0 17.0 17.0 17.0 17.0 17.0 17.0 1		3, 25 1, 3, 5, 18, 19 1, 3 4, 6, 17 1, 3 1, 3, 14 1, 3, 14 1, 3, 5 1, 3, 26 1, 3, 26 1, 3, 18, 19 1, 3 1, 3 4, 6, 17 1, 3 4, 6, 17 1, 3 1, 3 4, 6, 15, 17 1, 3 1, 3 1, 3 1, 3 1, 3 1, 3 1, 3 1, 3	HI	J3	52
40I 40IA 402A 402B 402C 403A-A 403A-B 403B 403C 403D 403E 403F 403F 403H 403L 403H 403L 403N 403P-A 403P-B 404 405 405A 405B 406	[2] 3'-O" X 7'-4" 3'-A" X 7'-4" 3'-O" X 7'-4"				F-3 F-3 F-3 F-3 F-3 F-3 F-3 F-3 F-3 F-3				D-22 D-8 D-1 D-1 D-1 D-4 D-8 D-8 D-8 D-9 D-1	23.0 17.1 18.0 17.0 20.0 17.0 17.0 17.0 17.0 17.0 17.0 17.0 1		3, 25 1, 3, 5, 18, 19 1, 3 1, 3 4, 6, 17 1, 3 1, 3, 14 1, 3, 14 1, 3, 5 1, 3, 26 1, 3, 26 1, 3, 18, 19 1, 3 1, 3 4, 6, 17 1, 3 4, 6, 17 1, 3 1, 3 4, 6, 17 1, 3 1, 3 4, 6, 17 1, 3 1, 3 4, 6, 17 1, 3 1, 3 4, 6, 17 1, 3 1, 3 4, 6, 17	HI	J3	52
40I 40IA 402A 402B 402C 403A-A 403A-B 403B 403C 403D 403E 403F 403H 403J 403L 403N 403P-A 403P-A 403P-B 404 405 405A 405A 406 407	[2] 3'-O" X T'-4" 3'-4" X T'-4" 3'-O" X T'-4"				F-3 F-3 F-3 F-3 F-3 F-3 F-3 F-3 F-3 F-3				D-22 D-8 D-1 D-1 D-1 D-4 D-8 D-8 D-8 D-9 D-9 D-1	23.0 17.1 17.1 18.0 17.0 20.0 17.0 17.0 17.0 17.0 17.0 17.0 17.0 1		3, 25 1, 3, 5, 18, 19 1, 3 4, 6, 17 1, 3 1, 3, 14 1, 3, 14 1, 3, 5 1, 3, 26 1, 3, 18, 19 1, 3 1, 3 4, 6, 17 1, 3 4, 6, 17 1, 3 1, 3 4, 6, 17 1, 3 1, 3 4, 6, 17 1, 3 1, 3 4, 6, 17 1, 3, 5	HI	J3	52
40I 40IA 402A 402B 403A-A 403B 403C 403D 403E 403H 403J 403L 403N 403P-A 405A 405A 405B 406 407 408-A	[2] 3'-O" X 7'-4" 3'-A" X 7'-4" 3'-O" X 7'-4"				F-3 F-3 F-3 F-3 F-3 F-3 F-3 F-3 F-3 F-3				D-22 D-8 D-1 D-1 D-1 D-4 D-8 D-8 D-8 D-9 D-9 D-1	23.0 17.1 17.1 18.0 17.0 20.0 17.0 17.0 17.0 17.0 17.0 17.0 17.0 1		3, 25 1, 3, 5, 18, 19 1, 3 1, 3 4, 6, 17 1, 3 1, 3, 14 1, 3, 15 1, 3, 26 1, 3, 26 1, 3, 18, 19 1, 3 1, 3 4, 6, 17 1, 3 1, 3 4, 6, 17 1, 3 1, 3 1, 3 1, 3 1, 3 1, 3 1, 3 1, 3	HI	J3	52
40I 40IA 402A 402B 402C 403A-A 403A-B 403B 403C 403B 404 405 405 405 405 405 405 405	[2] 3'-O" X 7'-4" 3'-A" X 7'-4" 3'-O" X 7'-4"				F-3 F-3 F-3 F-3 F-3 F-3 F-3 F-3 F-3 F-3				D-22 D-8 D-1 D-1 D-1 D-4 D-8 D-8 D-8 D-9 D-1	23.0 17.1 18.0 17.0 20.0 17.0 17.0 17.0 17.0 17.0 17.0 17.0 1		3, 25 1, 3, 5, 18, 19 1, 3 1, 3 4, 6, 17 1, 3 1, 3, 14 1, 3, 14 1, 3, 5 1, 3, 26 1, 3, 26 1, 3, 18, 19 1, 3 1, 3 4, 6, 17 1, 3 1, 3 4, 6, 17 1, 3 1, 3 1, 3 1, 3 1, 3 1, 3 1, 3 1, 3	HI	J3	52
40I 40IA 402A 402B 402C 403A-A 403A-B 403B 403C 403D 403E 403F 403H 403J 403H 403J 403H 403N 403P-A 403P-A 405P-A 405A 405A 405B 406 407 408-B 408A	[2] 3'-O" X 7'-4" 3'-A" X 7'-4" 3'-O" X 7'-4"				F-3 F-3 F-3 F-3 F-3 F-3 F-3 F-3 F-3 F-3				D-22 D-8 D-1 D-1 D-1 D-4 D-8 D-8 D-8 D-9 D-1	23.0 17.1 18.0 17.0 20.0 17.0 17.0 17.0 17.0 17.0 17.0 17.0 1		3, 25 1, 3, 5, 18, 19 1, 3 1, 3 4, 6, 17 1, 3 1, 3, 14 1, 3, 14 1, 3, 5 1, 3, 26 1, 3, 26 1, 3, 18, 19 1, 3 1, 3 4, 6, 17 1, 3 1, 3 4, 6, 17 1, 3 1, 3 1, 3 1, 3 1, 3 1, 3 1, 3 1, 3	HI	J3	52
40I 402A 402B 403A-A 403B 403C 403B 403C 403B 403C 403B 403C 403B 403C 403B 405 405 405 405 405 405 406 407 408-A 408B 408B	[2] 3'-O" X 7'-4" 3'-A" X 7'-4" 3'-O" X 7'-4"				F-3 F-3 F-3 F-3 F-3 F-3 F-3 F-3 F-3 F-3				D-22 D-8 D-1 D-1 D-1 D-4 D-8 D-8 D-8 D-9 D-1	23.0 17.1 17.1 18.0 17.0 20.0 17.0 17.0 17.0 17.0 17.0 17.0 17.0 1		3, 25 1, 3, 5, 18, 19 1, 3 1, 3 4, 6, 17 1, 3 1, 3, 14 1, 3, 15 1, 3, 26 1, 3, 26 1, 3, 18, 19 1, 3 1, 3 4, 6, 17 1, 3 4, 6, 17 1, 3 1, 3 4, 6, 17 1, 3 1, 3 1, 3 1, 3 1, 3 1, 3 1, 3 1, 3	HI	J3	52 - - - - - - - - - - - - - - - - - - -
40I 402A 402B 403C 403B 403C 403B 403C 403B 403C 403B 403C 403B 403C 403D 403C 403C 403C 403C 403C 403C 403C 403C	[2] 3'-O" X 7'-4"				F-3 F-3 F-3 F-3 F-3 F-3 F-3 F-3 F-3 F-3				D-22 D-8 D-1 D-1 D-1 D-4 D-8 D-8 D-8 D-9 D-1	23.0 17.1 18.0 17.0 20.0 17.0 17.0 17.0 17.0 17.0 17.0 17.0 1		3, 25 1, 3, 5, 18, 19 1, 3 1, 3 4, 6, 17 1, 3 1, 3, 14 1, 3, 15 1, 3, 26 1, 3, 26 1, 3, 18, 19 1, 3 1, 3 4, 6, 17 1, 3 1, 3 4, 6, 17 1, 3 1, 3 1, 3 1, 3 1, 3 1, 3 1, 3 1, 3	HI	J3	52 - - - - - - - - - - - - - - - - - - -
40I 402A 402B 403A-A 403B 403C 403D 403E 403B 403P-A 405A 405B 406 407 408A 408B 408F 4086-A	[2] 3'-O" X 7'-4" 3'-A" X 7'-4" 3'-O" X 7'-4"				F-3 F-3 F-3 F-3 F-3 F-3 F-3 F-3 F-3 F-3				D-22 D-8 D-1 D-1 D-1 D-4 D-8 D-8 D-8 D-8 D-9 D-1	23.0 17.1 17.1 18.0 17.0 17.0 17.0 17.0 17.0 17.0 17.0 17		3, 25 1, 3, 5, 18, 19 1, 3 1, 3 4, 6, 17 1, 3 1, 3, 14 1, 3, 15 1, 3, 26 1, 3, 26 1, 3, 18, 19 1, 3 1, 3 4, 6, 17 1, 3 4, 6, 17 1, 3 1, 3 4, 6, 17 1, 3 1, 3 1, 3 1, 3 1, 3 1, 3 1, 3 1, 3	HI	J3	52
40I 402A 402B 402C 403A-A 403A-B 403B 403C 403B 403C 403B 403B 403H 403J 403H 403J 403H 403N 403P-A 403P-B 404 405 405 405A 405B 406-A 408-A 408-B	[2] 3'-O" X 7'-4" 3'-A" X 7'-4" 3'-O" X 7'-4"				F-3 F-3 F-3 F-3 F-3 F-3 F-3 F-3 F-3 F-3				D-22 D-8 D-1 D-1 D-1 D-4 D-8 D-8 D-8 D-9 D-1	23.0 17.1 18.0 17.0 17.0 17.0 17.0 17.0 17.0 17.0 17		3, 25 1, 3, 5, 18, 19 1, 3 1, 3 4, 6, 17 1, 3 1, 3, 14 1, 3, 14 1, 3, 5 1, 3, 26 1, 3, 26 1, 3, 18, 19 1, 3 1, 3 4, 6, 17 1, 3 1, 3 4, 6, 17 1, 3 1, 3 1, 3 1, 3 1, 3 1, 3 1, 3 1, 3	HI	J3	52

DOOR SCHEDULE

#	SIZE	型	<u>l</u>	ক	ITPE	<u> 22</u>	<u> ûù </u>	ক	ITPE	J	10110	REMARKS	HEAD	JAMB	ᄓᄓ
409A	3'-0" X 7'-4"				F-3				D-I	17.1	-	1, 3	-	-	-
409B	3'-0" X 7'-4"		•		F-3				D-I	17.0	-	1, 3	-	-	-
4090	3'-0" X 7'-4"		•		F-3				D-I	7.0	-	1, 3	-	-	-
409F	3'-0" X 7'-4"		•		F-3				D-I	6.0	-	4, 6, 17	-	-	-
4001	3'-4" X 7'-4"		•		F-3				D-I	11.0	-	1, 3	-	-	-
4002A	3'-4" X 7'-4"		•		F-3				D-I	7.0	-	1, 3	-	-	-
4002B	3'-4" × 7'-4"		•		F-3				D-I	7.0	-	1, 3	-	-	-
40020	3'-0" × 7'-4"	•			F-2				D-23	25.0	-		н	J2	52
		<u> </u>													
500	3'-4" × 7'-4"		•		F-3				D-8	18.0	-	1, 3, 5, 18, 19	-	-	-
500A	3'-4" × 7'-4"		•		F-3				D-4	17.0	-	1, 3, 14	-	-	-
501-A	3'-4" × 7'-4"		•		F-3				D-8	18.0	-	1, 3, 5, 18, 19	-	-	-
501-B	3'-4" × 7'-4"		•		F-3				D-I	19.0	-	1, 3, 18, 19	-	-	-
501A	3'-4" X 7'-4"		•		F-3		•		D-I	17.0	_	1, 3	-	-	_
502-A	3'-4" × 7'-4"		•		F-3		•		D-8	15.0	_	1, 3, 5, 18, 19, 27	-	_	_
502-B	[2] 4'-0" × 8'-0"				F-2		Ť		D-14	22.0	_		HI	J2	52
502A	3'-0" × 7'-4"				F-3	ľ			D-4	17.0	_	1, 3, 14	_	_	-
502B	3'-0" × 7'-0"		•		W-7				D-17	6.0	_	4, 17	_	_	_
5020	3'-0" × 7'-0"		•		F-I	H			D-9	6.0	_	4, 17	_	_	_
502D	3'-0" × 7'-0"		•		F-I				D-23	6.0	_	4, 17	_	_	_
502E	3'-0" × 7'-0"		•		F-2				D-9	30.0	_	4, 17	_	_	_
503-A	3'-4" X 7'-4"				F-3				D-I	13.3	_	3	_	_	_
503-B	[2] 3'-10" X 8'-0"				F-2		\vdash		D-32	22.1			HI	J2	52
503A	3'-4" X 7'-4"				F-3		\vdash		D-J2		-	13	H4	J2/J6	
503B	3'-4" X 7'-4"				F-3				D-1 D-1	17.0 17.0	-	1 2	TI=	J4/J0	53
					F-3				D-I		-	1, 3		-	_ -
5030	3'-4" X 7'-4"									17.0	-	3	-	-	-
503D	3'-4" X 7'-4"				F-3	\vdash			D-I	17.0	-	1, 3	-	-	-
503E	3'-4" X 7'-4"				F-3	Ļ			D-8	17.0	-	1, 3, 5	-	-	
504-A	3'-4" X 7'-4"				F-3				D-2	18.1	-	3	-	-	-
504-B	3'-4" X 7'-4"		•		F-3	Ļ			D-8	18.1	-	1, 3, 5	-	-	-
505-A	3'-4" X 7'-4"		•		F-3		L		D-2	18.0	-	3	-	-	
505-B	3'-0" X 7'-0"				F-I	igdash			D-23	6.0	-	4, 6, 17, 22	-	-	_
505A	3'-0" X 7'-4"				F-3	┞			D-8	17.0	-	1, 3, 5, 18, 19	-	-	-
505B	[2] 3'-10" X &'-0"				E 0		. 1		D-32	42.0	-	13		J2	52
506					F-2	${}^{+}$	\vdash				-		HI		-
	3'-4" × 7'-4"		•		F-3		•		D-8	18.0	-	1, 3, 5	-	-	
507	3'-4" × 7'-4" 3'-4" × 7'-4"		•		F-3		•			18.0 18.0	-			-	-
			•		F-3	•	•		D-8			1, 3, 5	-		-
507	3'-4" X 7'-4"		•		F-3	•	•		D-8 D-8	18.0	-	I, 3, 5 I, 3, 5	-	-	- -
507 508-A	3'-4" × 7'-4" 3'-4" × 7'-4"		•		F-3 F-3 F-3	•	•		D-8 D-8 D-2	18.0 18.0	-	I, 3, 5 I, 3, 5	-	-	-
507 508-A 508-B	3'-4" X 7'-4" 3'-4" X 7'-4" 3'-4" X 7'-4"		•		F-3 F-3 F-3	•	•		D-8 D-8 D-2 D-10	18.0 18.0 29.0	-	1, 3, 5 1, 3, 5 3 4, 6, 17, 22		-	- - - - 52
507 508-A 508-B 508A	3'-4" × 7'-4" 3'-4" × 7'-4" 3'-4" × 7'-4" 3'-0" × 7'-4"		•		F-3 F-3 F-3 F-3	•	•		D-8 D-8 D-2 D-10 D-8	18.0 18.0 29.0 17.0	-	1, 3, 5 1, 3, 5 3 4, 6, 17, 22		- - -	- - - - 52
507 508-A 508-B 508A 508B	3'-4" × 7'-4" 3'-4" × 7'-4" 3'-4" × 7'-4" 3'-0" × 7'-4" [2] 4'-6" × 8'-0"		•		F-3 F-3 F-3 F-3 F-3	•	•		D-8 D-8 D-2 D-10 D-8 D-14	18.0 18.0 29.0 17.0 40.1		1, 3, 5 1, 3, 5 3 4, 6, 17, 22 1, 3, 5, 18, 19	- - - -	- - - - J2	- - - - 52
507 508-A 508-B 508A 508B	3'-4" × 7'-4" 3'-4" × 7'-4" 3'-4" × 7'-4" 3'-0" × 7'-4" [2] 4'-6" × 8'-0" [2] 3'-0" × 7'-4" [2] 3'-0" × 7'-4"		•		F-3 F-3 F-3 F-3 F-2 F-3	•	•		D-8 D-8 D-2 D-10 D-8 D-14 D-14	18.0 18.0 29.0 17.0 40.1 6.0		1, 3, 5 1, 3, 5 3 4, 6, 17, 22 1, 3, 5, 18, 19 4, 6, 17, 22	- - - - H	- - - - J2	- - - - 52 - -
507 508-A 508-B 508A 508B 508C	3'-4" × 7'-4" 3'-4" × 7'-4" 3'-4" × 7'-4" 3'-0" × 7'-4" [2] 4'-6" × 8'-0" [2] 3'-0" × 7'-4" [2] 3'-0" × 7'-4"		•		F-3 F-3 F-3 F-3 F-2 F-3 F-3	•			D-8 D-2 D-10 D-8 D-14 D-14	18.0 18.0 29.0 17.0 40.1 6.0		1, 3, 5 1, 3, 5 3 4, 6, 17, 22 1, 3, 5, 18, 19 4, 6, 17, 22 4, 6, 17, 22	- - - - H	- - - - J2	- - - 52 - -
507 508-A 508-B 508B 508C 508D-A 508D-B	3'-4" × 7'-4" 3'-4" × 7'-4" 3'-4" × 7'-4" 3'-0" × 7'-4" [2] 4'-6" × 8'-0" [2] 3'-0" × 7'-4" [2] 3'-4" × 7'-4"		•		F-3 F-3 F-3 F-3 F-2 F-3 F-3				D-8 D-2 D-10 D-8 D-14 D-14 D-14 D-14	18.0 18.0 29.0 17.0 40.1 6.0 29.0		1, 3, 5 1, 3, 5 3 4, 6, 17, 22 1, 3, 5, 18, 19 4, 6, 17, 22 4, 6, 17, 22 3	- - - - H	- - - - J2	- - - - 52 - -
507 508-A 508-B 508B 508C 508D-A 508D-B	3'-4" × 7'-4" 3'-4" × 7'-4" 3'-4" × 7'-4" 3'-0" × 7'-4" [2] 4'-6" × 8'-0" [2] 3'-0" × 7'-4" [2] 3'-0" × 7'-4" 3'-4" × 7'-4"		•		F-3 F-3 F-3 F-3 F-3 F-3 F-3 F-3 EX				D-8 D-2 D-10 D-8 D-14 D-14 D-14 D-9 Ex.	18.0 18.0 29.0 17.0 40.1 6.0 29.0 19.0 Ex.		1, 3, 5 1, 3, 5 3 4, 6, 17, 22 1, 3, 5, 18, 19 4, 6, 17, 22 4, 6, 17, 22 3 NO MORK THIS OPENING	- - - - H	- - - - J2	- - -
507 508-A 508A 508B 508C 508D-A 508D-B 508E	3'-4" × 7'-4" 3'-4" × 7'-4" 3'-4" × 7'-4" 3'-0" × 7'-4" [2] 4'-6" × 8'-0" [2] 3'-0" × 7'-4" [3'-0" × 7'-4" 3'-0" × 6'-8" 3'-0" × 6'-8"		•		F-3 F-3 F-3 F-3 F-2 F-3 F-3 F-3 EX	•			D-8 D-2 D-10 D-8 D-14 D-14 D-14 D-9 EX.	18.0 29.0 17.0 40.1 6.0 29.0 19.0 EX.	- - - - -	1, 3, 5 1, 3, 5 3 4, 6, 17, 22 1, 3, 5, 18, 19 4, 6, 17, 22 4, 6, 17, 22 3 NO MORK THIS OPENING	- - - - HI -	- - - J2 - -	- - - /-
507 508-A 508A 508B 508C 508D-A 508D-B 508B 508F	3'-4" × 7'-4" 3'-4" × 7'-4" 3'-4" × 7'-4" 3'-0" × 7'-4" [2] 4'-6" × 8'-0" [2] 3'-0" × 7'-4" [3'-0" × 7'-4" 3'-4" × 7'-4" 3'-0" × 6'-8" 3'-0" × 7'-4"		•		F-3 F-3 F-3 F-3 F-2 F-3 F-3 F-3 EX	•			D-8 D-2 D-10 D-8 D-14 D-14 D-14 D-9 Ex. D-9	18.0 29.0 17.0 40.1 6.0 29.0 19.0 EX.		1, 3, 5 1, 3, 5 3 4, 6, 17, 22 1, 3, 5, 18, 19 4, 6, 17, 22 4, 6, 17, 22 3 NO MORK THIS OPENING	- - - - HI - -	- - - J2 - - - J2	- - - - /- 52
507 508-A 508-B 508B 508C 508D-A 508E 508E 508E 508E	3'-4" × 7'-4" 3'-4" × 7'-4" 3'-4" × 7'-4" 3'-0" × 7'-4" [2] 4'-6" × 8'-0" [2] 3'-0" × 7'-4" 3'-0" × 7'-4" 3'-0" × 6'-8" 3'-0" × 7'-4" 3'-0" × 7'-4"		•		F-3 F-3 F-3 F-3 F-3 F-3 F-3 F-3 EX F-2 F-2				D-8 D-2 D-10 D-8 D-14 D-14 D-14 D-9 EX. D-9 D-9	18.0 18.0 29.0 17.0 40.1 6.0 29.0 19.0 EX. 43.0 43.0	- - - - - -	1, 3, 5 1, 3, 5 3 4, 6, 17, 22 1, 3, 5, 18, 19 4, 6, 17, 22 4, 6, 17, 22 3 NO WORK THIS OPENING	- - - - - - - - - - - - - - - -	- - - J2 - - - J2	- - - - /- 52
507 508-A 508-B 508B 508C 508D-A 508E 508E 508E 508E 5086 508H	3'-4" × 7'-4" 3'-4" × 7'-4" 3'-4" × 7'-4" 3'-0" × 7'-4" [2] 4'-6" × 8'-0" [2] 3'-0" × 7'-4" 3'-0" × 6'-8" 3'-0" × 7'-4" 3'-0" × 7'-4" 3'-0" × 7'-4" 3'-0" × 7'-4" 3'-0" × 7'-4"		•		F-3 F-3 F-3 F-3 F-3 F-3 F-3 F-3 EX F-2 F-2 F-2 F-3				D-8 D-2 D-10 D-8 D-14 D-14 D-14 D-9 Ex. D-9 D-9 D-9	8.0 29.0 17.0 40.1 6.0 29.0 19.0 EX. 43.0 13.0 17.0	- - - - - - -	1, 3, 5 1, 3, 5 3 4, 6, 17, 22 1, 3, 5, 18, 19 4, 6, 17, 22 4, 6, 17, 22 3 NO MORK THIS OPENING NO MORK THIS OPENING		- - - J2 - - - J2	- - - - - 52
507 508-A 508A 508B 508C 508D-A 508D-B 508F 508F 5086 508H 509A	3'-4" × 7'-4" 3'-4" × 7'-4" 3'-4" × 7'-4" 3'-0" × 7'-4" [2] 4'-6" × 8'-0" [2] 3'-0" × 7'-4" 3'-0" × 6'-8" 3'-0" × 7'-4" 3'-0" × 7'-4" 3'-0" × 7'-4" 3'-0" × 7'-4" 3'-0" × 7'-4" 3'-0" × 7'-4" 3'-4" × 7'-4"		•		F-3 F-3 F-3 F-3 F-2 F-3 F-3 F-3 EX F-2 F-2 F-3 F-3				D-8 D-2 D-10 D-8 D-14 D-14 D-14 D-9 EX: D-9 D-9 D-8 D-8	8.0 29.0 17.0 40.1 6.0 29.0 19.0 EX. 43.0 18.0 17.0	- - - - - - -	1, 3, 5 1, 3, 5 3 4, 6, 17, 22 1, 3, 5, 18, 19 4, 6, 17, 22 4, 6, 17, 22 3 NO MORK THIS OPENING NO MORK THIS OPENING 1, 3, 5 1, 3, 5, 18, 19	- - J2 - - J2 J2 J2	- - - 52 52
507 508-A 508A 508B 508C 508D-A 508D-B 508F 508F 5086 508H 509A 509A	3'-4" × 7'-4" 3'-4" × 7'-4" 3'-4" × 7'-4" 3'-0" × 7'-4" [2] 4'-6" × 8'-0" [2] 3'-0" × 7'-4" 3'-0" × 6'-8" 3'-0" × 7'-4" 3'-0" × 7'-4" 3'-0" × 7'-4" 3'-0" × 7'-4" 3'-0" × 7'-4" 3'-0" × 7'-4" 3'-4" × 7'-4" 4'-0" × 7'-4"		•		F-3 F-3 F-3 F-3 F-3 F-3 F-3 EX F-2 F-2 F-3 F-3 F-2 F-3 F-2				D-8 D-2 D-10 D-8 D-14 D-14 D-14 D-9 EX. D-9 D-9 D-8 D-8 D-9	8.0 29.0 17.0 40.1 6.0 29.0 19.0 EX. 43.0 43.0 17.0 36.0	- - - - - - - -	1, 3, 5 1, 3, 5 3 4, 6, 17, 22 1, 3, 5, 18, 19 4, 6, 17, 22 4, 6, 17, 22 3 NO WORK THIS OPENING NO WORK THIS OPENING 1, 3, 5 1, 3, 5, 18, 19 -		- - - J2 - - J2 J2 J2	- - - 52 52 -

- I. REMOVE EXISTING SOLID CORE WOOD DOOR; PROVIDE MINOR REPAIRS AS NEEDED TO DOOR SLAB DUE TO WEAR, GOUGES, ETC.; REPAIR AS NEEDED FOR REMOVED / NEW HARDWARE AS SPECIFIED. PREP FOR NEW FINISHES, STAIN /
- REFINISH TO LIKE NEW CONDITION. 2. REMOVE EXISTING HOLLOW METAL DOOR; PROVIDE MINOR REPAIRS AS NEEDED TO DOOR SLAB DUE TO WEAR, DENTS, ETC. BY APPLYING BONDO TYPE REPAIR. REPAIR AS NEEDED FOR REMOVED / NEW HARDWARE AS SPECIFIED. PREP FOR NEW FINISHES, PRIME AND PAINT TO LIKE NEW CONDITION.
- 3. EXISTING HOLLOW METAL FRAME TO REMAIN. PROVIDE MINOR REPAIRS AS NEEDED TO FRAME DUE TO WEAR, DAMAGE, ETC.; REPAIR AS NEEDED FOR REMOVED / NEW HARDWARE AS SPECIFIED. PREP FOR NEW FINISHES, PRIME AND PAINT
- TO LIKE NEW CONDITION. REMOVE EXISTING, INSTALL NEW SILENCERS. 4. EXISTING DOOR / FRAME TO REMAIN AT THIS OPENING - EXISTING FINISHES, HARDWARE, ETC. TO REMAIN EXCEPT AS
- 5. REMOVE EXISTING WIRE GLASS, INSTALL NEW D-20 FIRE RATED GLASS INTO EXISTING OPENING. INSTALL W/ SEALANT / GASKETS TO PREVENT RATTLING OF GLASS IN OPENING. REMOVE AND REINSTALL WOOD OR METAL STOPS. PREP FOR
- 6. PREP AND PAINT EXISTING HOLLOW METAL DOOR FRAME. 7. REPAIR / MODIFY CLOSER ARM FROM RUBBING TOP OF DOOR.
- 8. INSTALL KICKPLATE AT EXISTING DOOR, WHERE MISSING. INTENT IS TO HAVE KICKPLATE AT BOTH SIDES OF DOOR.
- 9. REMOVE EXISTING DUTCH DOOR THIS LOCATION, INSTALL NEW DOOR LEAF AS SPECIFIED. REMOVE EXISTING, INSTALL NEW HOLLOW METAL DOOR FRAME TO PROVIDE NEW HINGE POCKETS, STRIKE, AND HARDWARE AS SPECIFIED.
- IO. REMOVE REMOVE EXISTING WIRE GLASS, INSTALL NEW XXX FIRE RATED GLASS INTO EXISTING OPENING. INSTALL W SEALANT / GASKETS TO PREVENT RATTLING OF GLASS IN OPENING. REMOVE AND REINSTALL WOOD OR METAL STOPS. PREP FOR NEW FINISHES.
- II. CUT OPENING INTO EXISTING FLUSH DOOR FOR NEW LITE KIT. PREP AND INSTALL NEW LITE / FRAME TO MATCH EXISTING
- 12. FIXED STEEL MULLION BETWEEN DOORS THIS LOCATION.
- 13. REMOVABLE STEEL MULLION BETWEEN DOORS THIS LOCATION. 14. REMOVE LOUVER / FRAME [BOTH SIDES OF DOOR SLAB AS REQUIRED] AS REQUIRED TO PREP AND REFINISH DOOR.
- PREP AND REFINISH LOUVER. 15. CUT OPENING INTO EXISTING DOOR SLAB FOR NEW LOUVER. PREP AND INSTALL NEW LOUVER / FRAME TO MATCH
- 16. INSTALL NEW ADA COMPLIANT AUTOMATIC DOOR OPENER ONLY ON LEAF CLOSEST TO WALL. 17. REPLACE CORE / RE-KEY EXISTING HARDWARE TO NEW BUILDING MASTER KEY SCHEDULE.
- 18. REMOVE EXISTING SOUND SEAL GASKET FROM DOOR FRAME. INFILL HOLES IN FRAME BY APPLYING BONDO TYPE
- 19. REMOVE EXISTING AUTOMATIC DOOR BOTTOM FROM DOOR SLAB. INSTALL NEW SOLID WOOD FILLER INTO EXISTING
- RABBITED EDGE. PROVIDE CLOSURE / END CAPS IF APPLICABLE AT DOOR SLAB. 20. MAGNETIC HOLD OPEN DEVICE[S] THIS OPENING. COORDINATE WITH DOOR HARDWARE SPECS AND ELECTRICAL
- 21. INSTALL 36" HIGH STAINLESS STEEL KICKPLATE AT OPEN SIDE OF DOOR ONLY.
- 22. PREP AND PAINT EXISTING METAL DOOR.

- 23. REMOVE EXISTING WIRE GLASS / LITE KIT. PREP AND INSTALL NEW LOUVER / FRAME TO MATCH DOOR.
- 24. MANUAL HOLD OPEN DEVICE[S] THIS OPENING. COORDINATE WITH DOOR HARDWARE.
- 25. INSTALL 36" HIGH STAINLESS STEEL KICKPLATE AT GYM SIDE OF DOORS.
- 26. REMOVE EXISTING LOUVER, INSTALL NEW LITE KIT PER DOOR TYPE INTO EXISTING OPENING IN DOOR. 27. REMOVE MANUAL HOLD OPEN DEVICE THIS DOOR.
- 28. ADD DOOR ACCESS CONTROLS TO THIS DOOR. COORDINATE WITH DOOR HARDWARE SPECS AND ELECTRICAL 29. ADD CLOSER TO THIS DOOR. COORDINATE WITH DOOR HARDWARE SPECS.
- 30. REMOVE EXISTING 1/4" TEMPERED GLAZING, INSTALL NEW 1/4" TEMPERED GLAZING. THESE DOORS HAVE METAL LITE

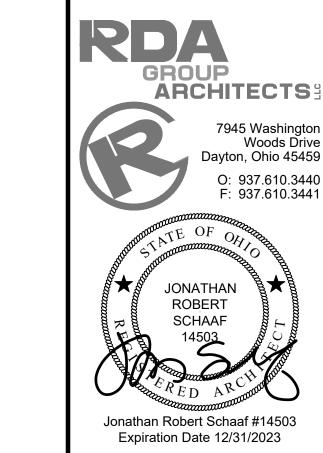

FRAME DETAILS

| HEAD | JAMB | SILL

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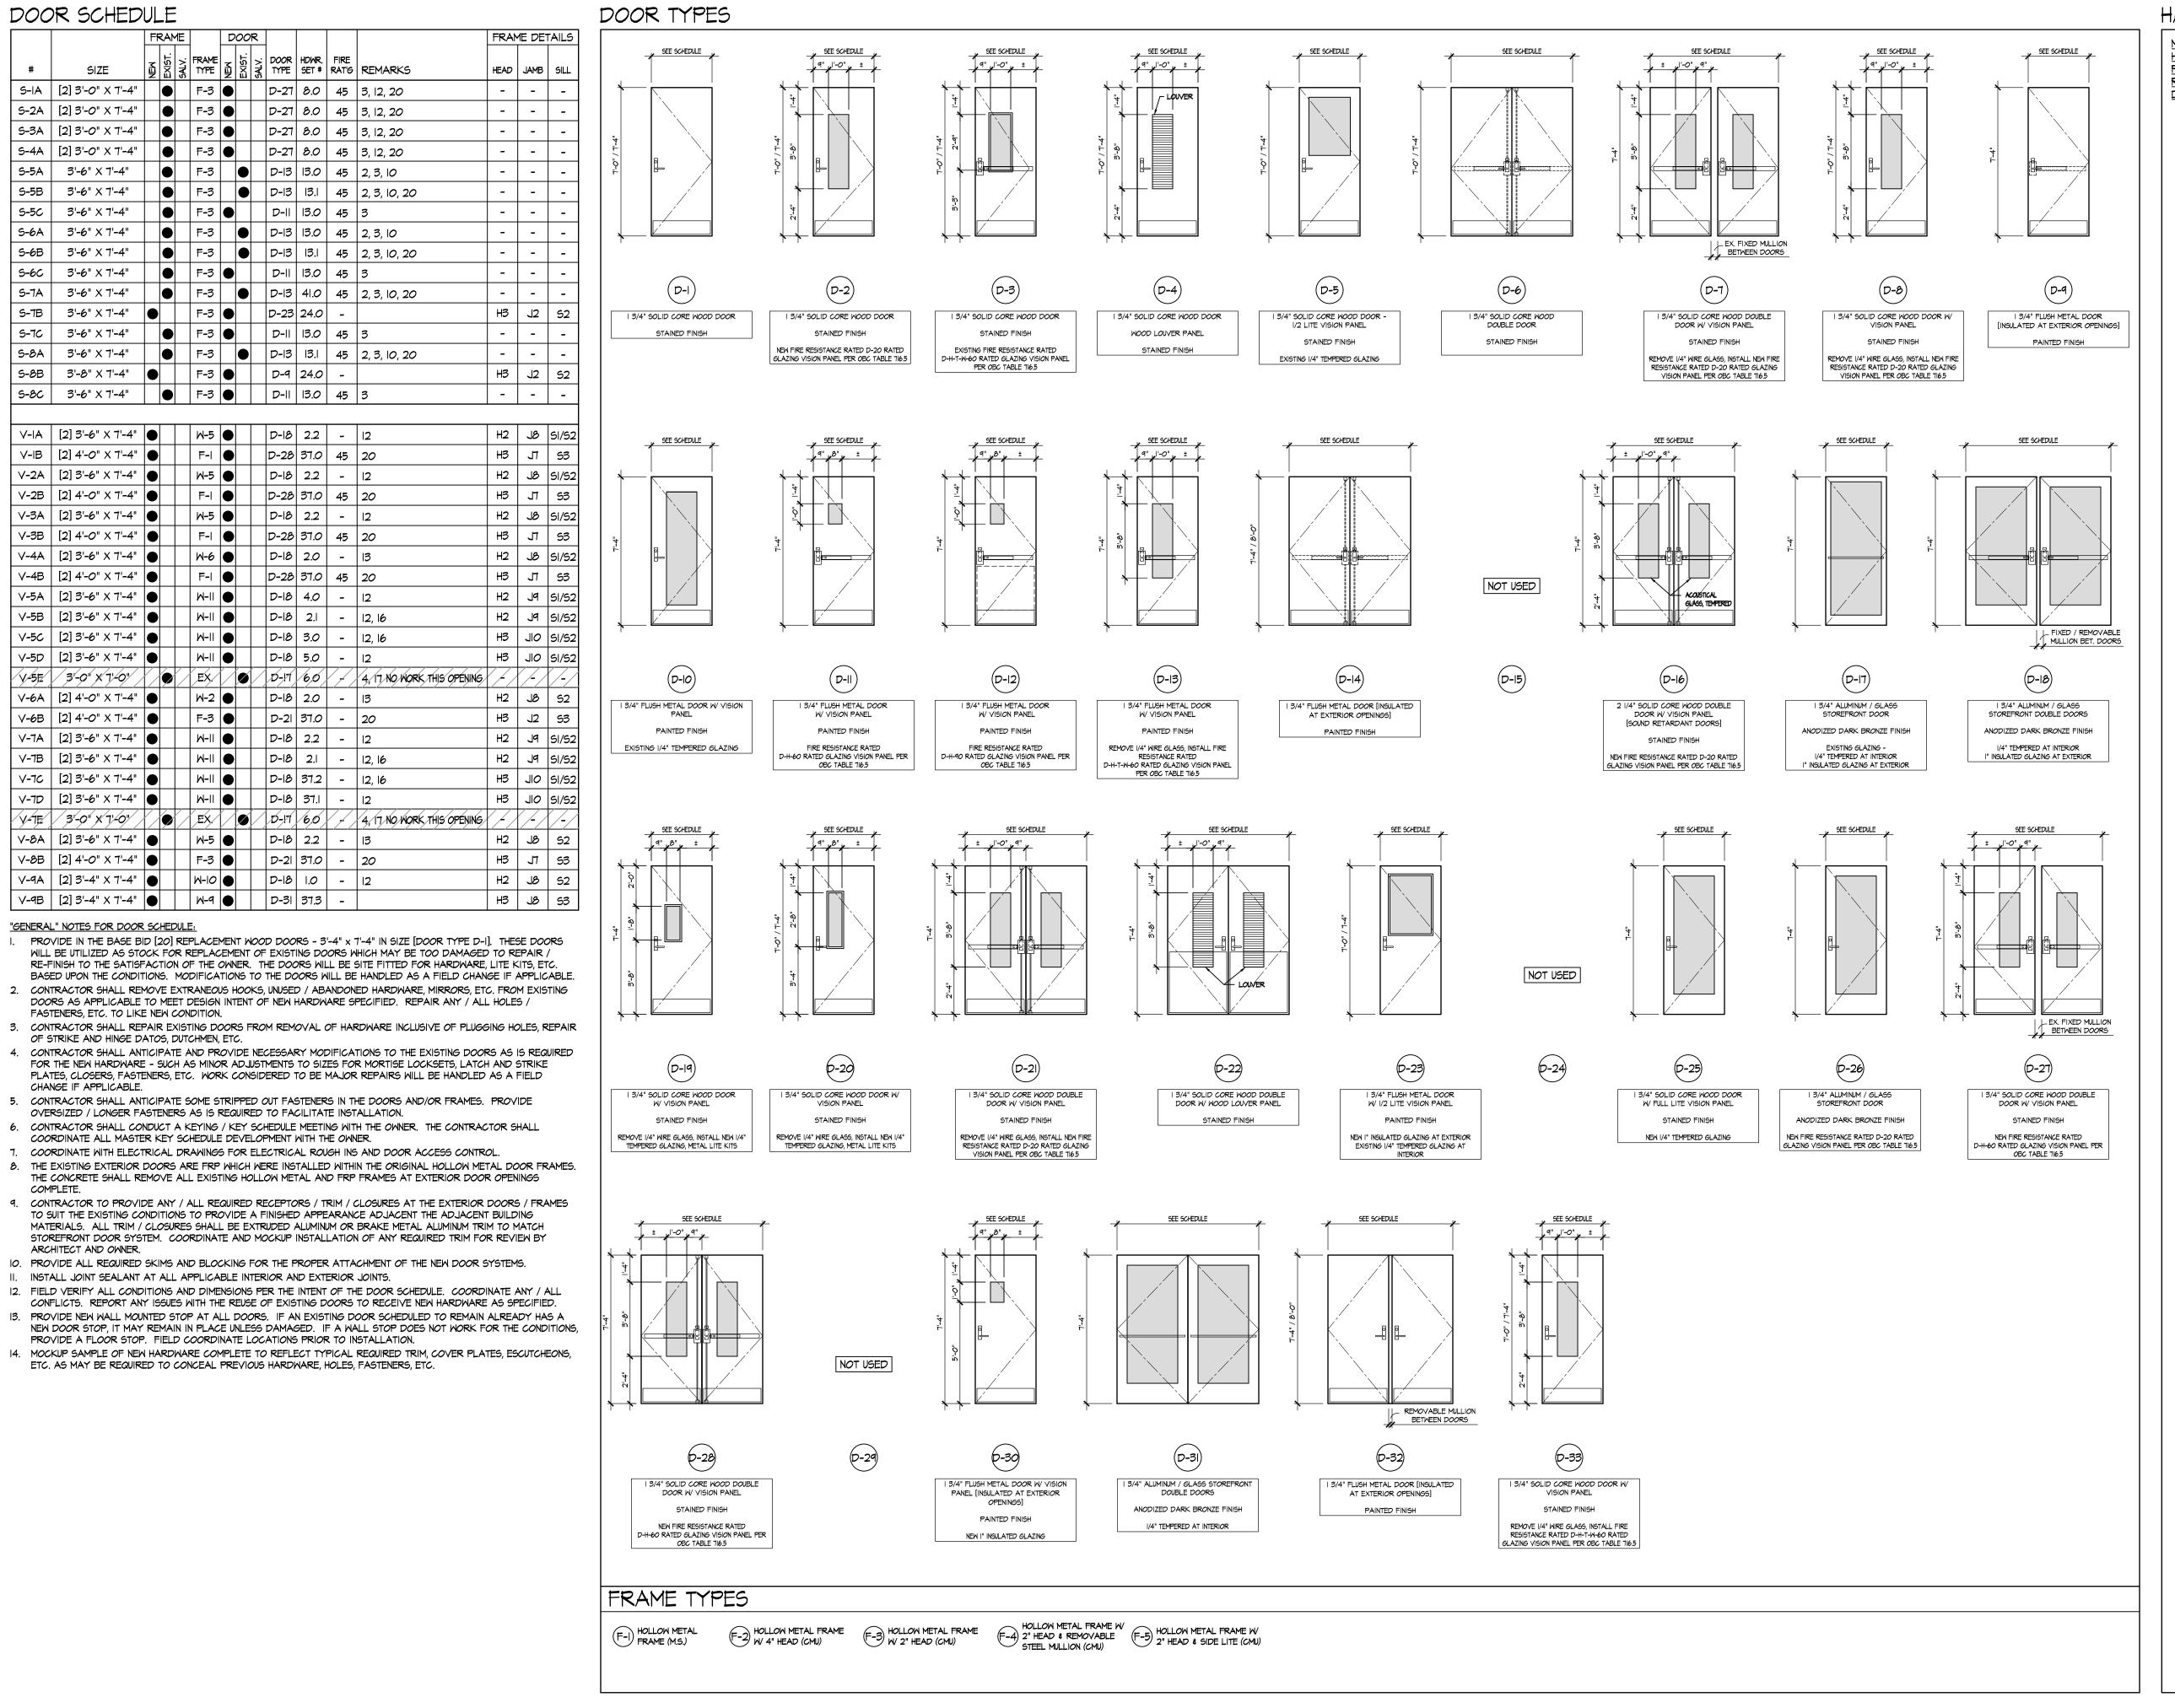
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Sheet Title


DOOR SCHEDULE

Sheet Number



HARDWARE TYPES

NOTE: REFER TO SPECIFICATIONS FOR DOOR HARDWARE INFORMATION. ANY INFORMATION <u>PROVIDED HEREIN ON DRAWINGS IS FOR GENERAL</u> REFERENCE OF INTENDED FUNCTION. COORDINATE ALL DETAILS AND REQUIREMENTS WITH SPECIFICATIONS.

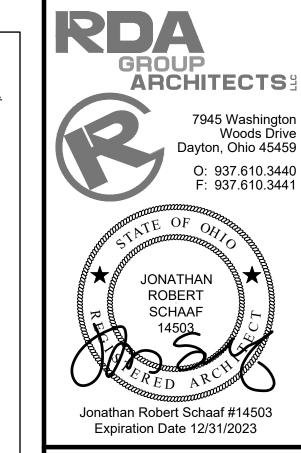

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Date January 24, 2022

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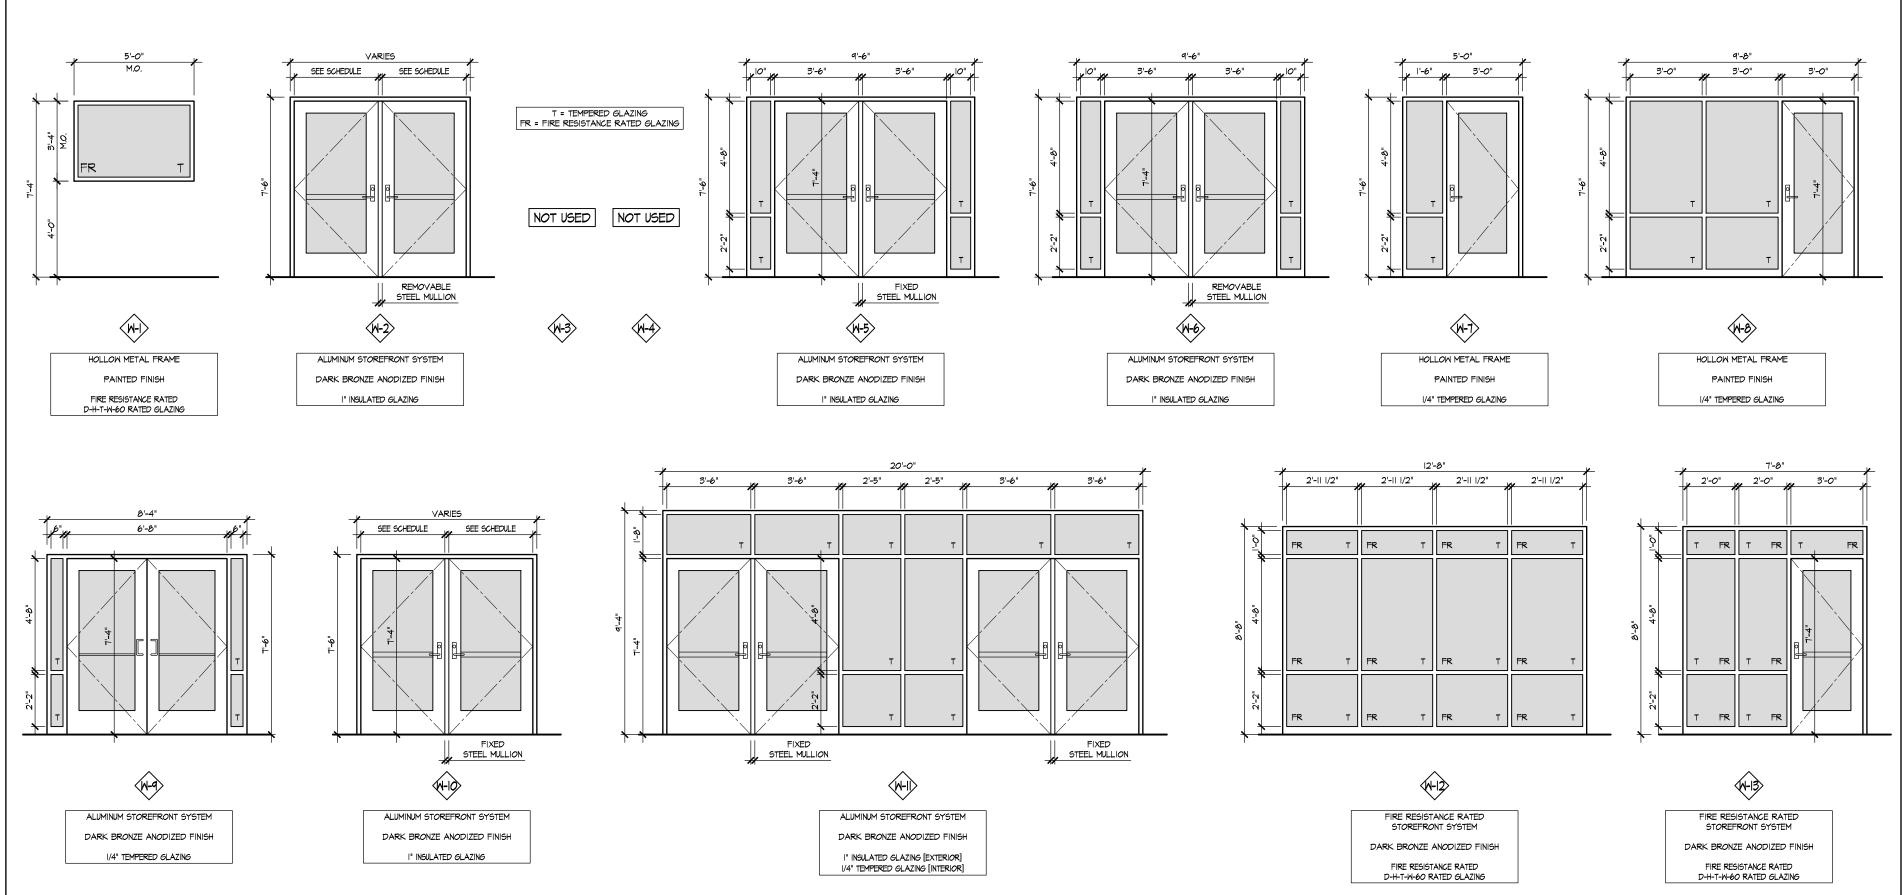
DOOR SCHEDULE


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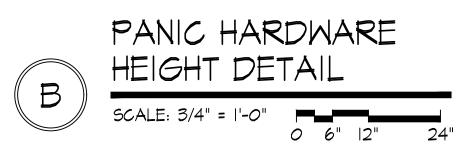
*> WINDOW SCHEDULE


#	SIZE	NH NH	EXIST	SALV.	TYPE/OPERATION	DETAILS	GLAZING TYPE	REMARKS
M-I	5'-0" × 3'-4"	•			FIXED WINDOW	D&E/A3.12	TEMPERED - FIRE RATED [D-H-T-W-60]	NEW FIRE RATED WINDOW IN NEW OPENING
W-2	7'-6" × 7'-6"	•			ALUM. DOOR FRAME	H7&J8/A4.31		NEW DOOR FRAME IN EX. OPENING
W-3	NOT USED							
W-4	NOT USED							
W-5	9'-6" × 7'-6"	•			ALUM/GLASS DOOR FRAME	H7&J8/A4.31	I" INSULATED TEMPERED GLAZING	NEW DOOR FRAME IN EX. OPENING
W-6	9'-6" × 7'-6"	•			ALUM/GLASS DOOR FRAME	H7&J8/A4.31	I" INSULATED TEMPERED GLAZING	NEW DOOR FRAME IN EX. OPENING
W-7	5'-0" × 7'-6"	•			HOLLOW METAL	HIO&JI2/A4.31	1/4" CLEAR TEMPERED GLAZING	NEW DOOR FRAME IN NEW OPENING
W-8	9'-8" × 7'-6"	•			HOLLOW METAL	J/A3.l2	1/4" CLEAR TEMPERED GLAZING	NEW DOOR FRAME IN NEW OPENING
W-9	8'-4" × 7'-6"	•			ALUM/GLASS DOOR FRAME	H7&J8/A4.31	I" INSULATED TEMPERED GLAZING	NEW DOOR FRAME IN EX. OPENING
M-10	VARIES X 7'-6"	•			ALUM/GLASS DOOR FRAME	H7&J8/A4.31	I" INSULATED TEMPERED GLAZING	NEW DOOR FRAME IN EX. OPENING
M-II	20'-0" X 9'-4"	•			ALUM/GLASS DOOR FRAME	15.4A/TH 18.4A/OIL \$PL	I" INSULATED TEMPERED GLAZING [EXTERIOR] I/4" CLEAR TEMPERED GLAZING [INTERIOR]	NEW DOOR FRAME IN EX. OPENING
W-12	2'-8" × 8'-8"	•			RATED STOREFRONT WINDOW	B,C,F/A3.12	TEMPERED - FIRE RATED [D-H-T-W-60]	NEW FIRE RATED WINDOW IN NEW OPENING
W-13	7'-8" X 8'-8"	•			RATED ALUM/GLASS DOOR FRAME	B,C,F/A3.12	TEMPERED - FIRE RATED [D-H-T-W-60]	NEW FIRE RATED DOOR FRAME IN NEW OPENING


WINDOW TYPES






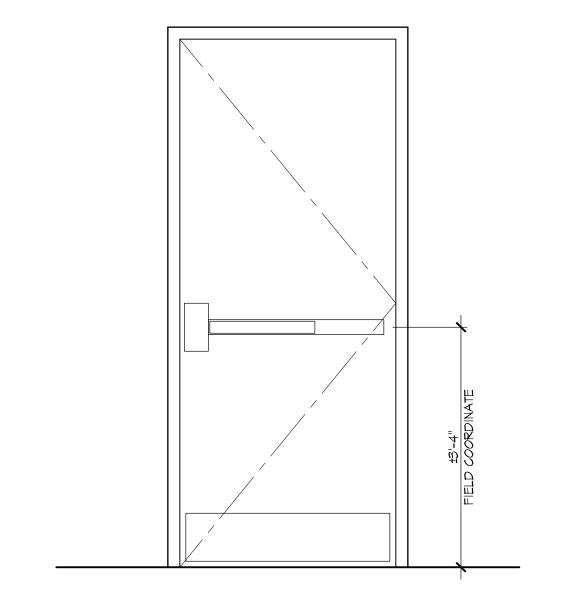

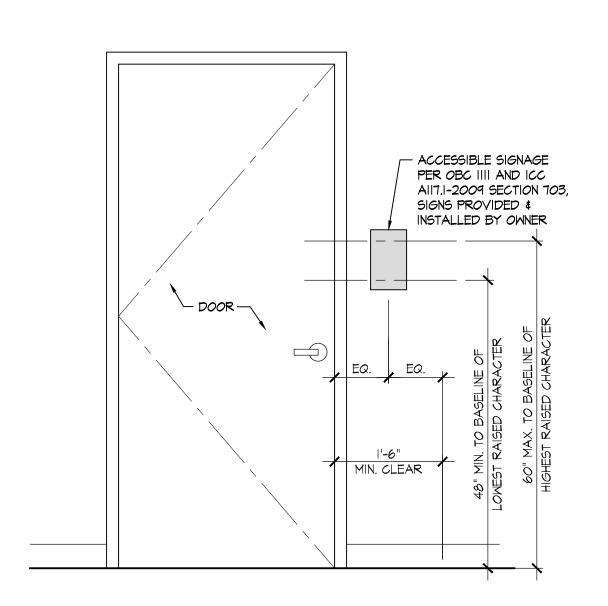

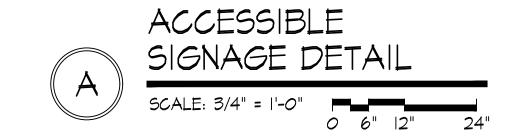

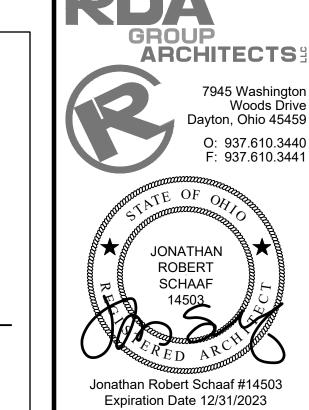

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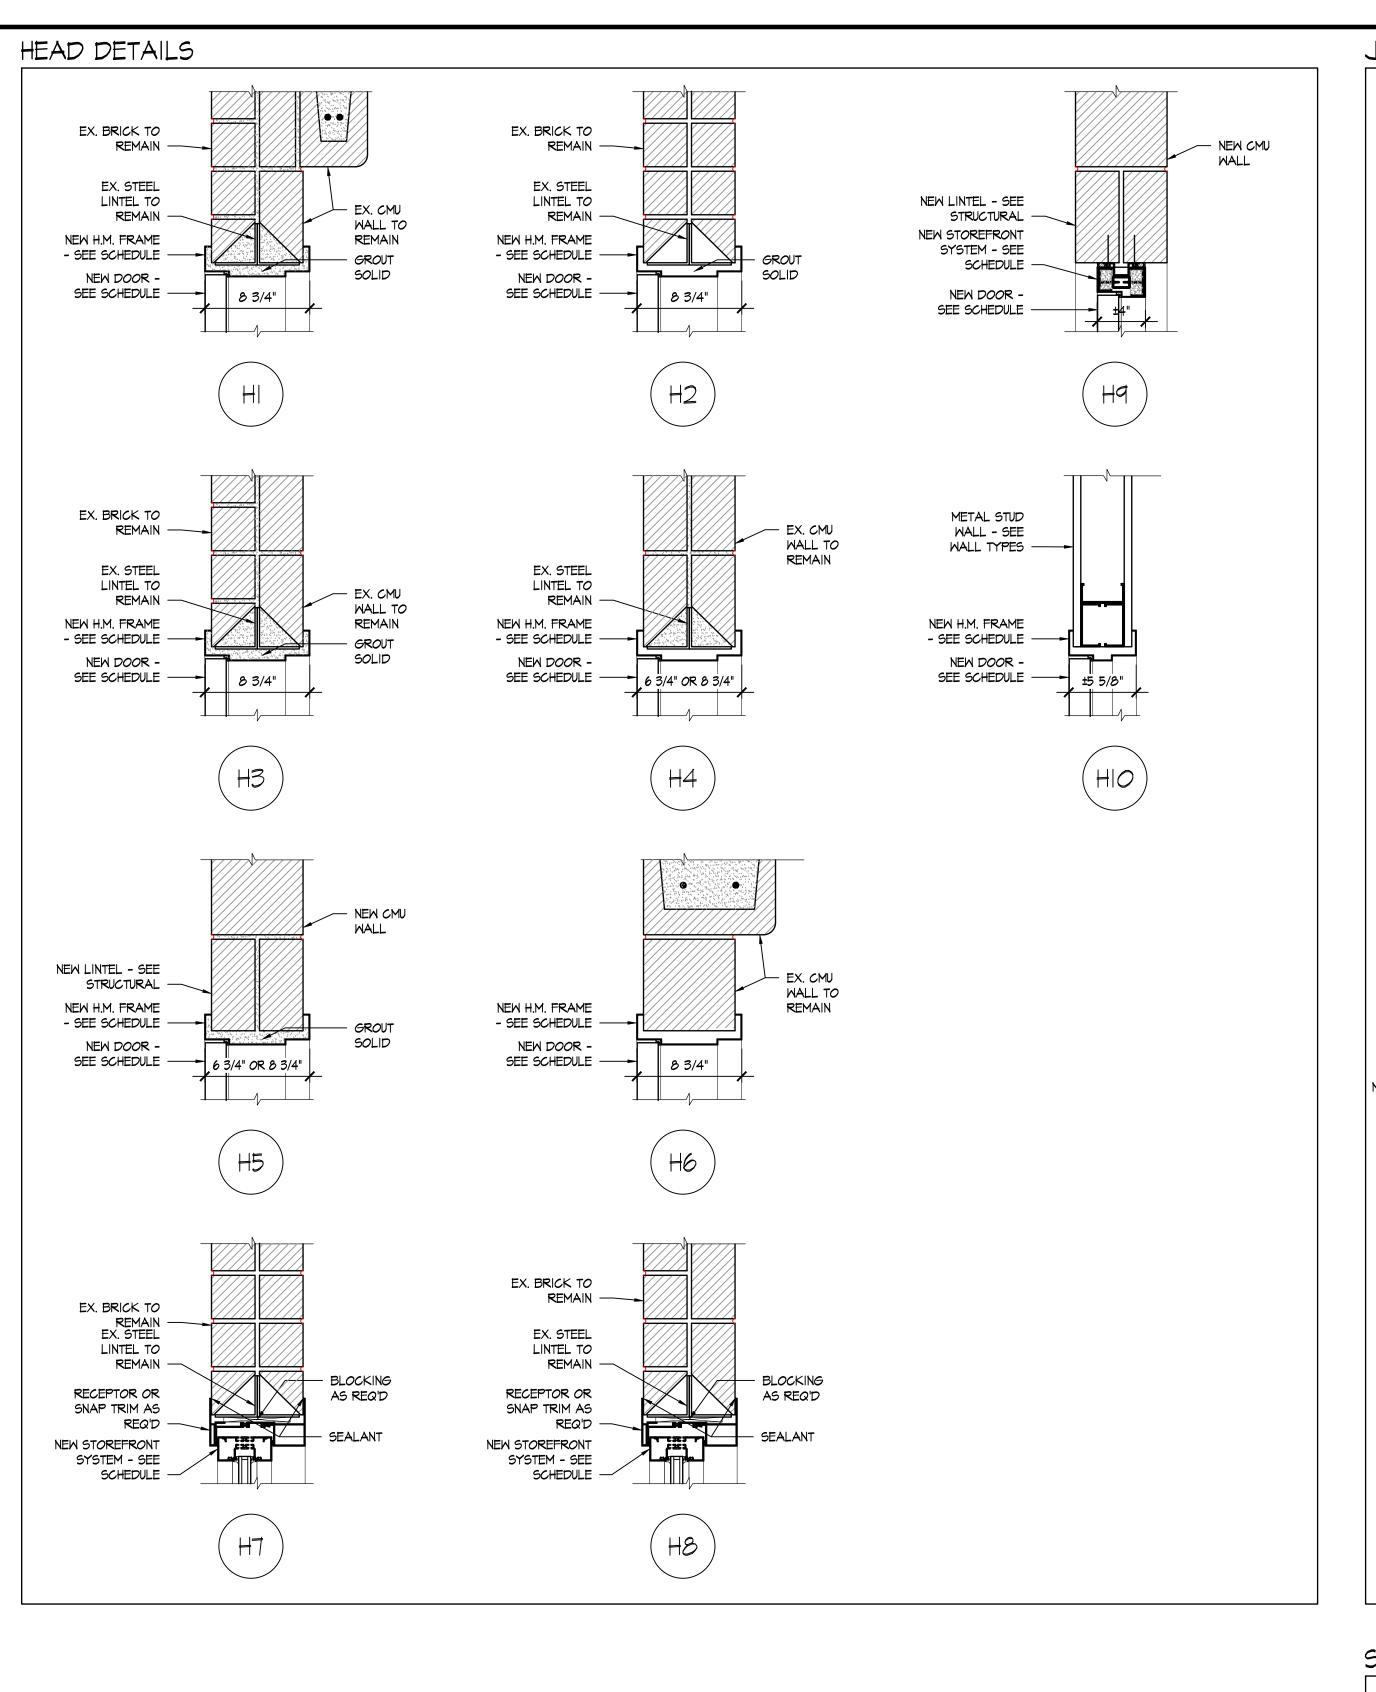
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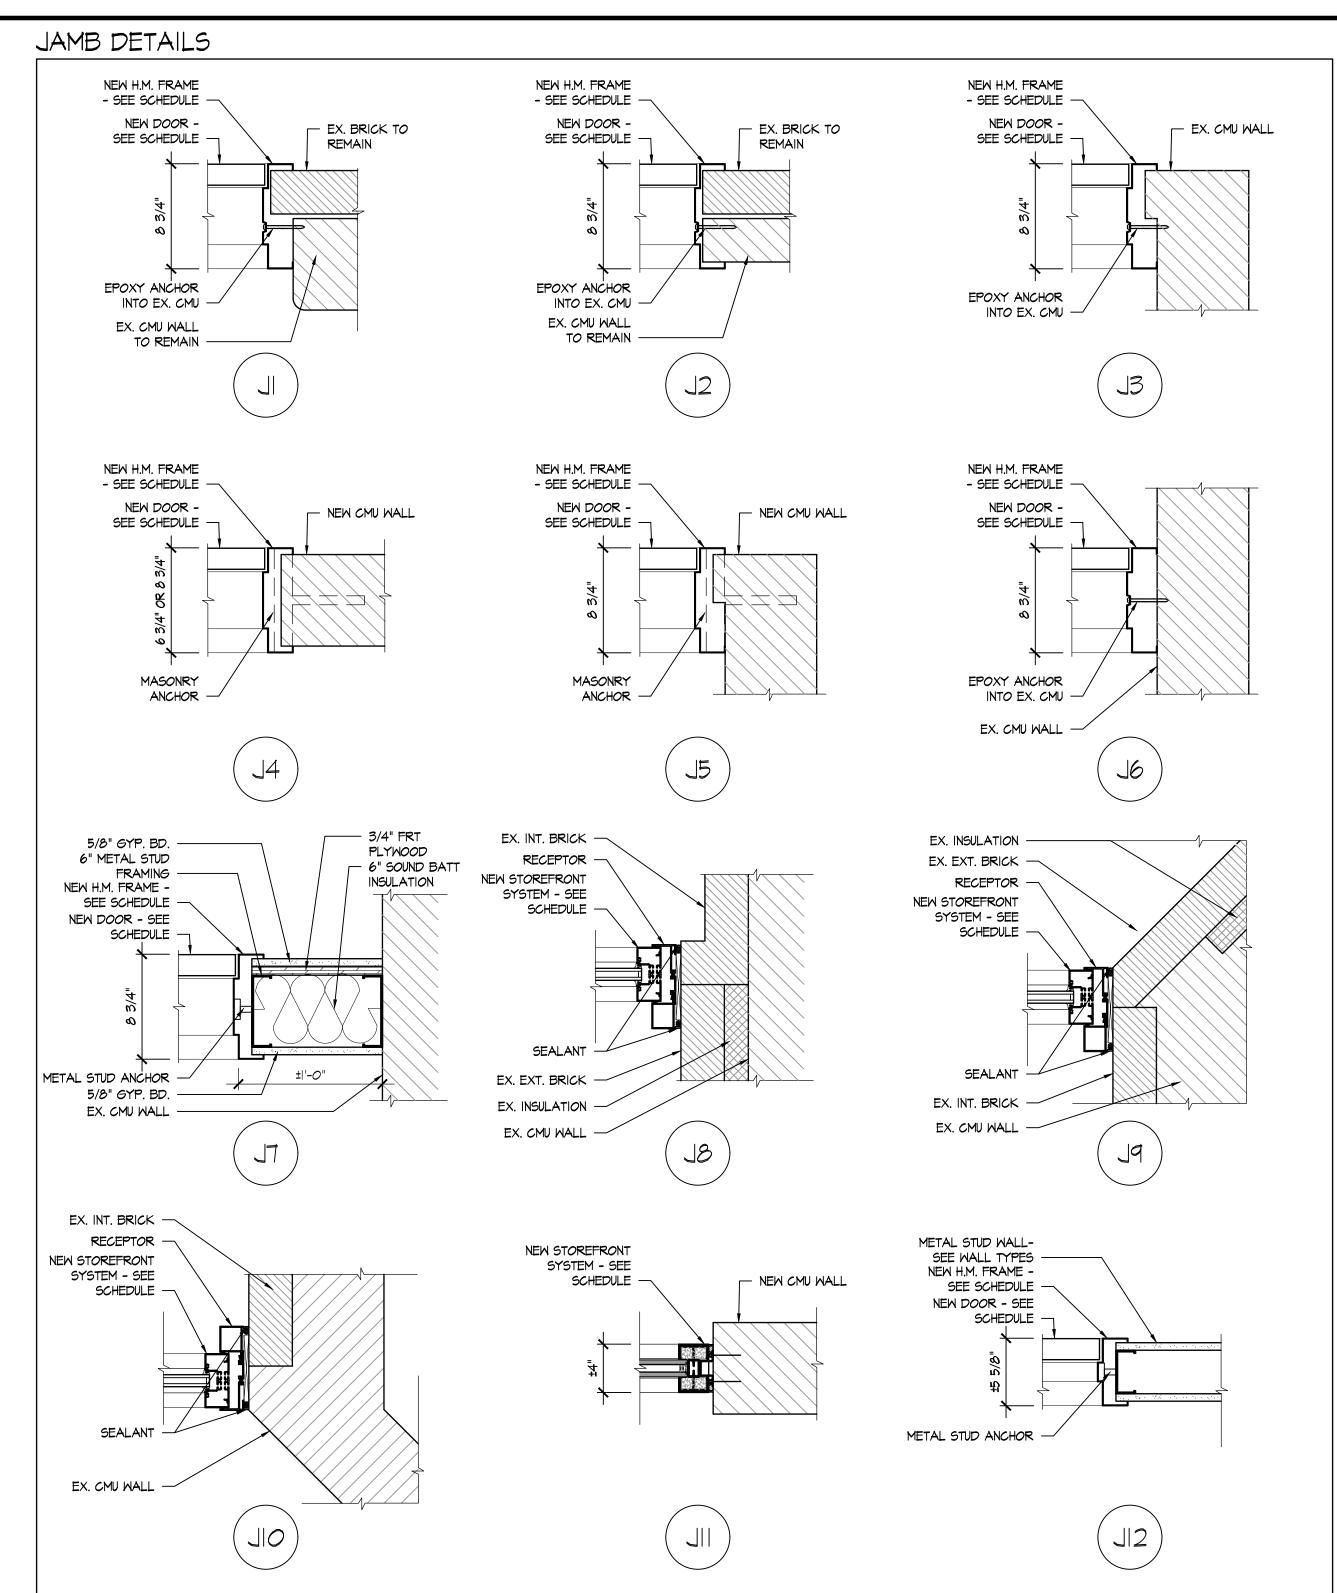
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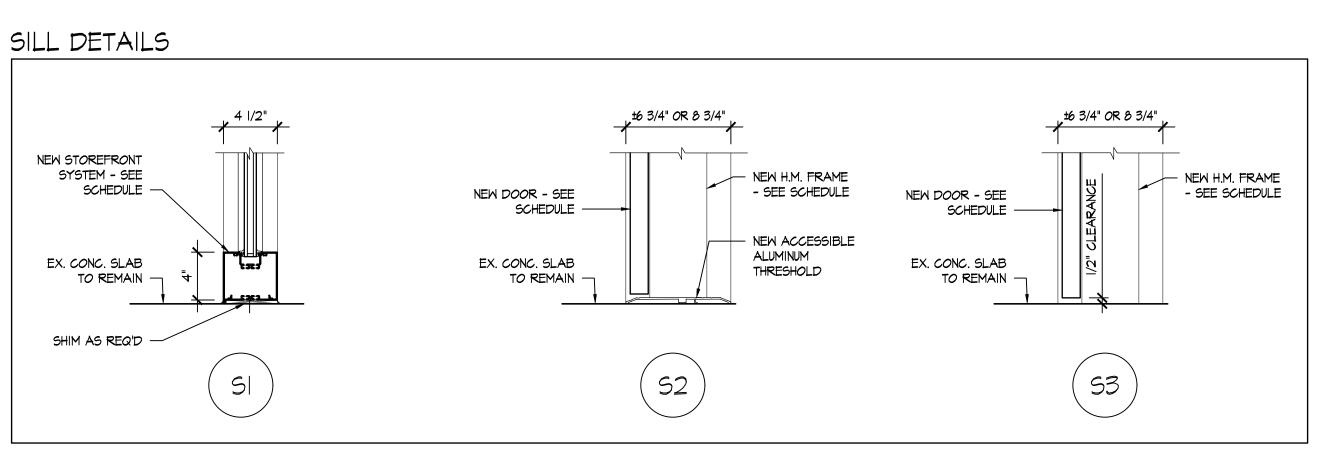
Sheet Title
WINDOW SCHEDULE &
DETAILS


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Sheet Number

DOOR \$ WINDOW HEAD AND JAMB DETAILS

GENERAL NOTES

- THIS CONTRACTOR SHALL FURNISH AND INSTALL THE PLUMBING SYSTEM AS PER THE STATE PLUMBING CODE AND APPLICABLE LOCAL CODES.
- 2. THIS CONTRACTOR SHALL BE RESPONSIBLE FOR SAW CUTTING, PATCHING AND REPAIR OF ALL WALLS, FLOORS, AND CEILINGS AS REQUIRED FOR THE PERFORMANCE OF HIS WORK. PATCHING AND REPAIR SHALL MATCH EXISTING ADJACENT SURFACES OR MATCH THE QUALITY OF ADJACENT NEW WORK SURFACES.
- THIS CONTRACTOR SHALL BE RESPONSIBLE FOR THE EXCAVATION AND BACKFILLING REQUIRED FOR BELOW GRADE / SLAB WORK, ASSOCIATED WITH HIS PORTION OF WORK.
- THIS CONTRACTOR SHALL COORDINATE THE PLANNING AND INSTALLATION OF HIS WORK WITH ALL OTHER TRADES PRIOR TO AND DURING ALL PHASES OF CONSTRUCTION.
- 5. THIS CONTRACTOR SHALL SECURE AND PAY FOR ALL PERMITS AND INSPECTIONS REQUIRED FOR HIS WORK UNDER THIS
- THIS CONTRACTOR SHALL NOT SCALE THE CONTRACT DOCUMENTS FOR THE PURPOSE OF OBTAINING FINAL MEASUREMENTS. COORDINATE WITH ARCHITECTURAL PLANS AND ACTUAL FIELD CONDITIONS.
- THIS CONTRACTOR SHALL BE RESPONSIBLE FOR THE CLEANING OF HIS WORK AREA AT THE CONCLUSION OF EACH WORKING DAY.
- ALL PLUMBING FIXTURES TO BE CAULKED WITH 1 PART SILICONE SEALANT, ALL AROUND. SEALANT TO MATCH FIXTURE COLOR. USE CLEAR SEALANT IN THE CASE OF STAINLESS STEEL FINISH.

REMOVAL OF PIPING, EQUIPMENT AND FIXTURES SHALL INCLUDE ALL MISCELLANEOUS APPURTENANCES SUCH AS HANGERS,

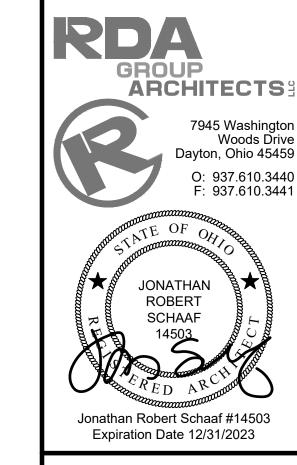- SUPPORTS, WIRING, INSULATION, ETC. THAT WILL BECOME OBSOLETE UNDER THE NEW WORK. PIPING SHALL BE REMOVED TO IT'S NEAREST MAIN AND CAPPED.
- REFER TO ARCHITECTURAL PLANS AND INTERIOR ELEVATIONS FOR EXACT LOCATIONS AND MOUNTING HEIGHTS FOR ALL NEW FIXTURES.
- 11. ALL EQUIPMENT, FIXTURES, DEVICES, ACCESSORIES, AND OTHER ITEMS SHOWN AS REMOVED SHALL BE REMOVED AND LEGALLY DISPOSED OF OFF SITE.
- 2. ALL ROOF REPAIR WORK SHALL BE ACCOMPLISHED BY KREMER ROOFING ON THE TYPE OF ROOF (SBS MODIFIED). REPAIR WORK SHALL NOT COMPROMISE THE INTEGRITY OF THE ROOF AND ANY EXISTING WARRANTY. SEE NOTES ON ARCHITECTURAL ROOF BLAN

P	LUMBING LEGEND
SYMBOL	DESCRIPTION
V	VENT PIPING (EX. PREFIX INDICATES EXISTING PIPING)
SAN	SANITARY PIPING (EX. PREFIX INDICATES EXISTING PIPING)
AW	CHEMICAL WASTE PIPING (EX. PREFIX INDICATES EXISTING PIPING)
CA	COMPRESSED AIR PIPING (EX. PREFIX INDICATES EXISTING PIPING)
NG	NATURAL GAS PIPING (EX. PREFIX INDICATES EXISTING PIPING)
CW	DOMESTIC COLD WATER PIPING (EX. PREFIX INDICATES EXISTING PIPING)
HW— — —	DOMESTIC HOT WATER PIPING (EX. PREFIX INDICATES EXISTING PIPING)
HWR — — —	DOMESTIC HOT WATER RETURN PIPING (EX. PREFIX INDICATES EXISTING PIPING)
	— BALL VALVE
	— CHECK VALVE
	BACKFLOW PREVENTER
	PIPE CAP
	PIPE UP
	PIPE DOWN
 >	FLOW ARROW
	FLOW ARROW
(##)	KEYNOTE DESIGNATION
1	DETAIL DECIDALATION
P2.02	DETAIL DESIGNATION
ADA	AMERICAN WITH DISABILITIES ACT
AFF	ABOVE FINISHED FLOOR
BFP	BACKFLOW PREVENTER
CO	CLEANOUT
CW	DOMESTIC COLD WATER
DS	DOWNSPOUT
ET	EXPANSION TANK
EX	EXISTING
FCO	FLOOR CLEANOUT
FD	FLOOR DRAIN
GMR	GAS METER/REGULATOR
GS	GAS SERVICE
НВ	HOSE BIBB
HW	DOMESTIC HOT WATER
HWR	DOMESTIC HOT WATER RETURN
IND	INDIRECT WASTE
LV	LAVATORY
MB	MOP BASIN
NG	NATURAL GAS
NP	NON POTABLE WATER
NTS	NOT TO SCALE
SAN	SANITARY
SK	SINK
TYP.	TYPICAL
UR	URINAL
VR	VENT RISER
VS	VENT STACK
VTR	
WC	VENT THRU ROOF
WCO	WATER CLOSET
	WALL CLEANOUT
WH	WATER HEATER
WS	WATER SERVICE
WTC	WATER COOLER
VCO	L MADD OF EAVIOUR


PIPE F	PHASING LEGEND
	INDICATES NEW WORK.
	INDICATES TO BE REMOVED.
	INDICATES EXISTING TO REMAIN.

YARD CLEANOUT

	PLUMBING INDEX OF DRAWINGS									
SHEET NUMBER	SHEET NAME									
P0.01	PLUMBING LEGEND AND GENERAL NOTES									
P1.01	PLUMBING OVERALL FIRST FLOOR PLAN DEMOLITION PART 'I' - BELOW SLAB									
P1.02	PLUMBING OVERALL FIRST FLOOR PLAN DEMOLITION PART 'I' - ABOVE SLAB									
P1.03	PLUMBING OVERALL SECOND FLOOR PLAN DEMOLITION PART '6'									
P1.04	PLUMBING ENLARGED LIBRARY FIRST FLOOR - DEMOLITION									
P2.01	PLUMBING OVERALL FIRST FLOOR PLAN NEW WORK PART 'I' - BELOW SLAB									
P2.02	PLUMBING OVERALL FIRST FLOOR PLAN NEW WORK PART 'I' - ABOVE SLAB									
P2.03	PLUMBING OVERALL SECOND FLOOR PLAN NEW WORK PART '6'									
P2.04	PLUMBING ENLARGED CLASSROOMS 127-130, 234 & 236 PLANS - NEW WORK									
P2.05	PLUMBING ENLARGED ROOMS 120-126 PLANS - NEW WORK									
P3.01	PLUMBING ISOMETRICS - LOUNGE AND CLASSROOMS 224 & 226									
P3.02	PLUMBING ISOMETRICS - CLASSROOMS 120-126, 208, 210, 225, 227, 229									
P4.01	PLUMBING SCHEDULES									



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Sheet Title

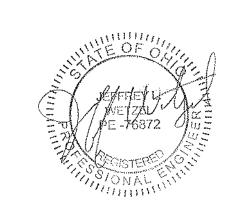PLUMBING LEGEND AND

GENERAL NOTES

Sheet Number


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DRAWING NOTES

EXISTING SANITARY PIPING TO REMAIN. PIPING INDICATED FOR REFERENCE ONLY.





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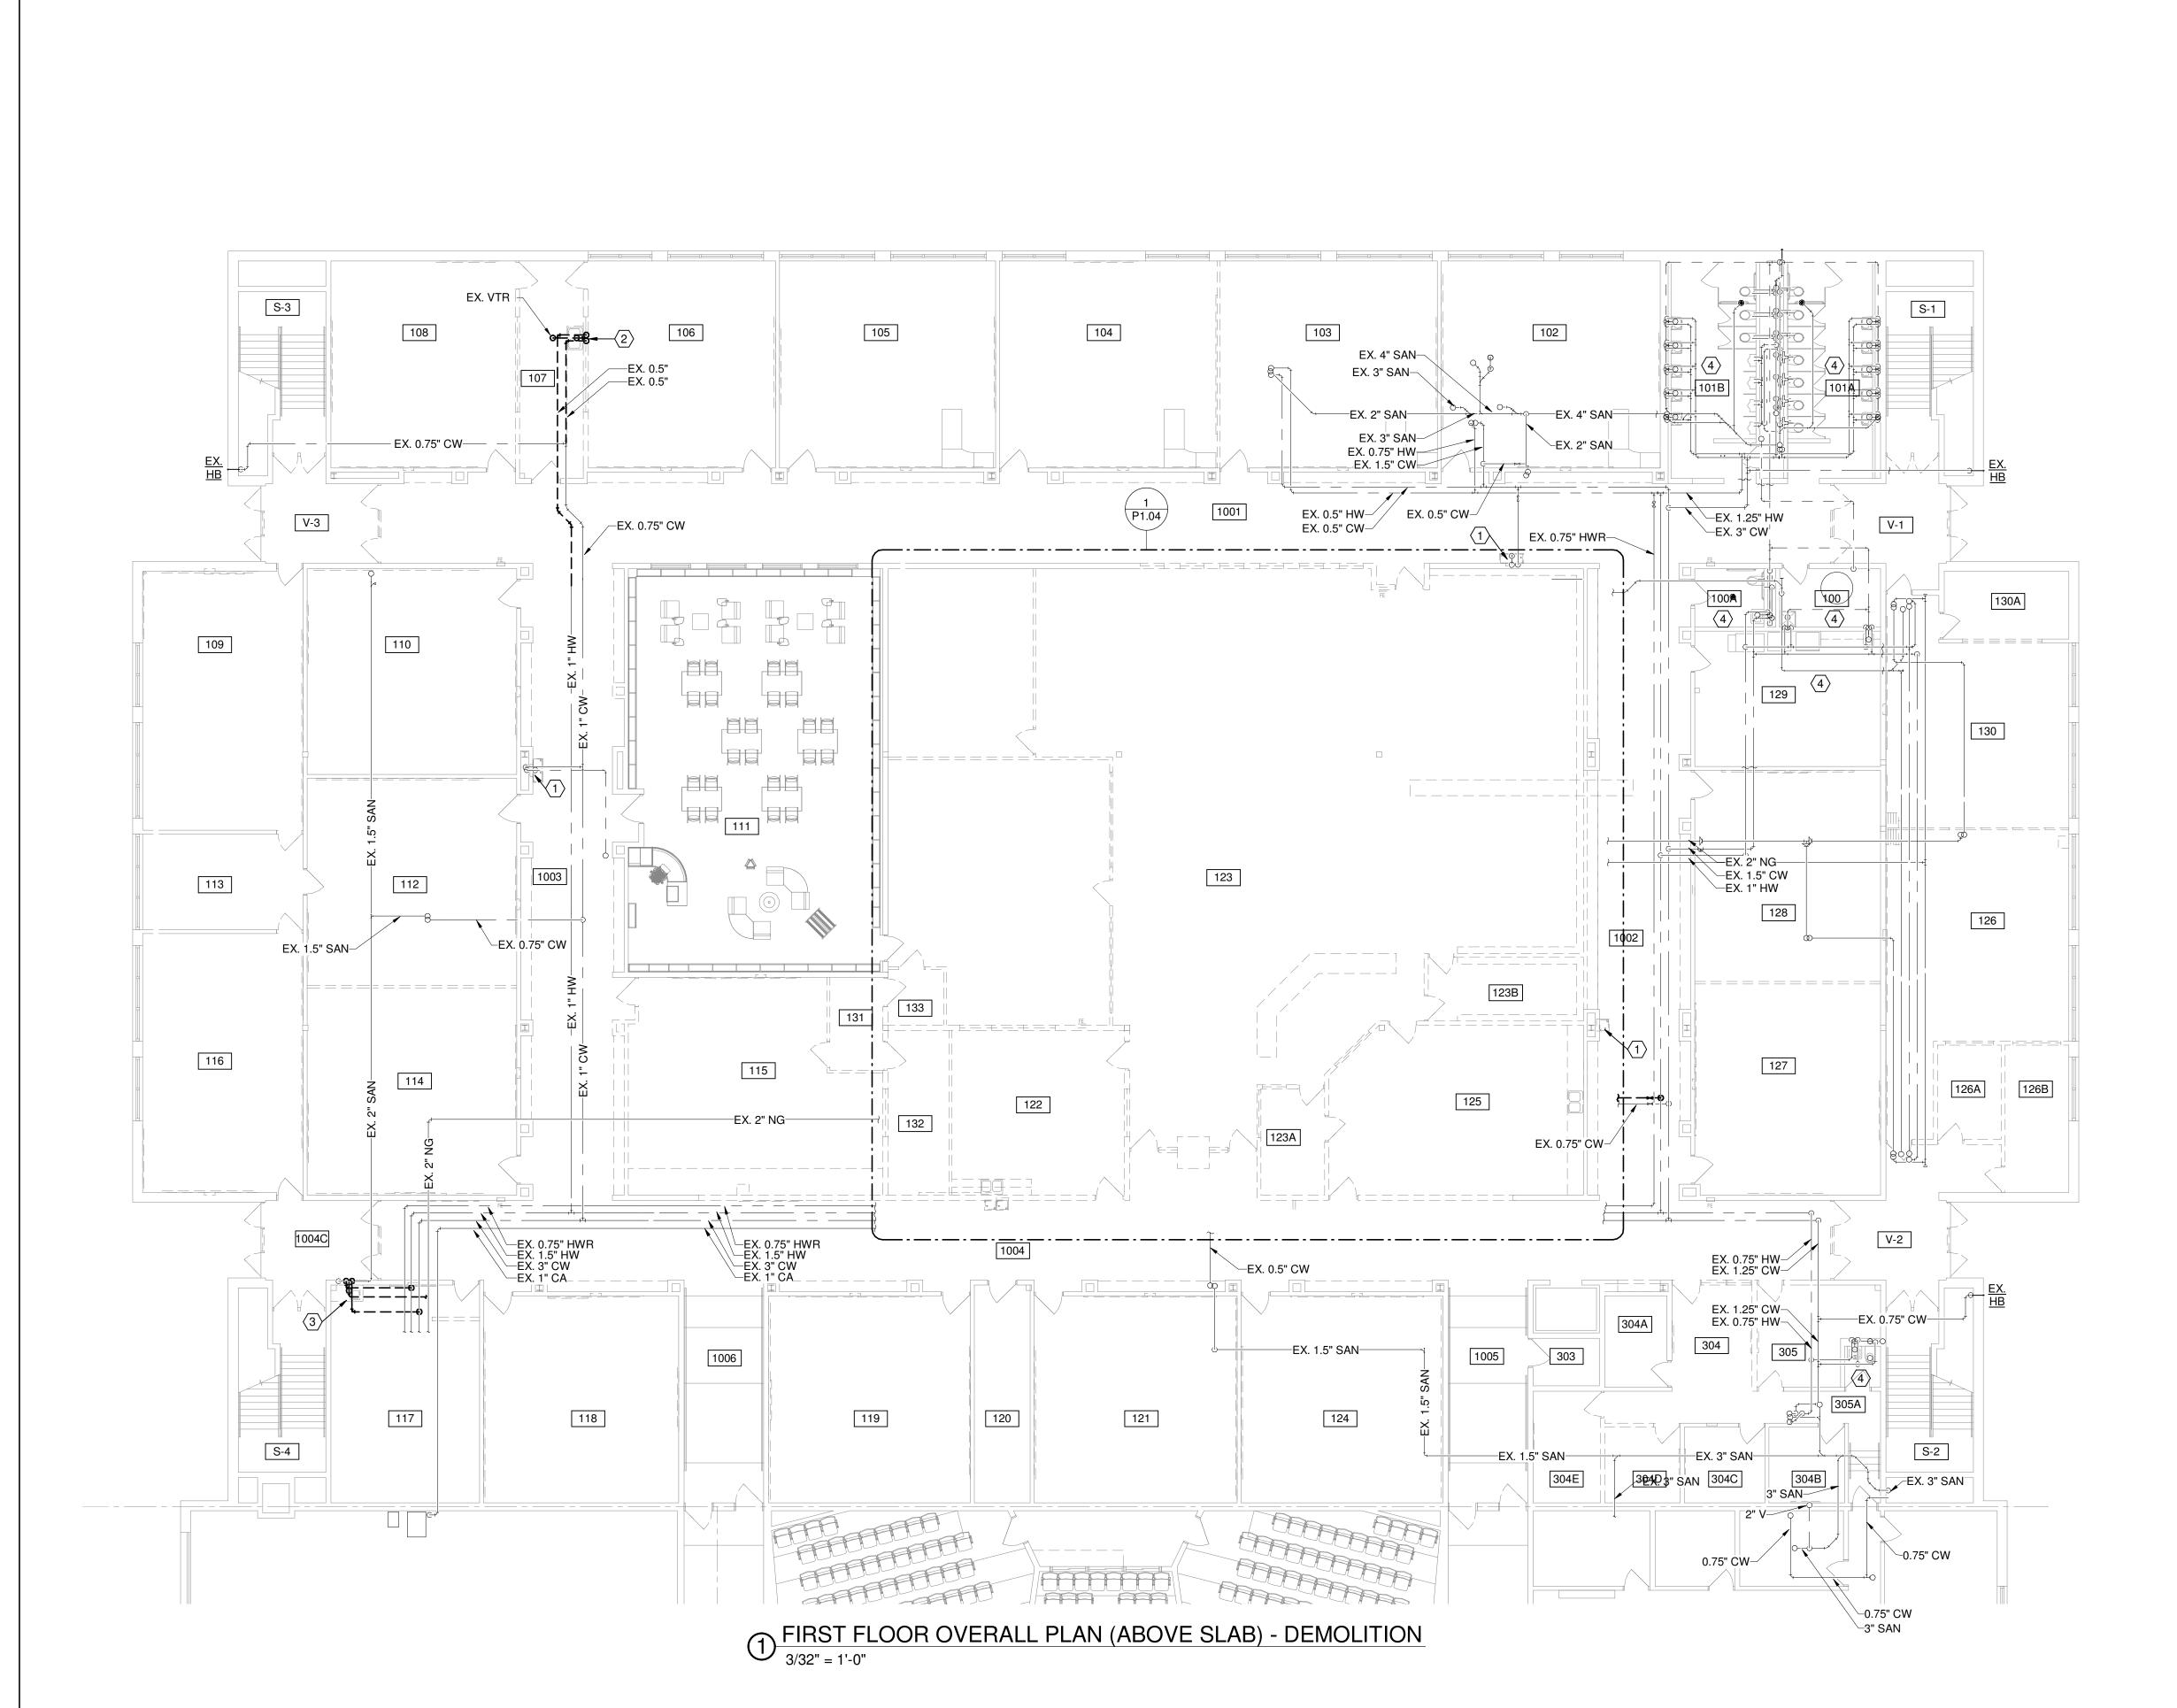
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Sheet Title

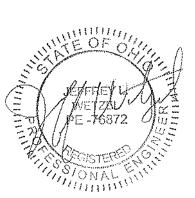PLUMBING OVERALL FIRST FLOOR PLAN DEMOLITION PART 'I' - BELOW SLAB

Sheet Number






- REMOVE EXISTING DRINKING FOUNTAIN. ASSOCIATED UTILITIES TO REMAIN.
- REMOVE EXISTING SINK. REMOVE HOT AND COLD WATER PIPING TO POINT INDICATED ON PLAN. REMOVE SANITARY PIPING TO BELOW SLAB AND CAP. REMOVE VENT PIPING. REFER TO 1/P103 FOR ADDITIONAL INFORMATION.
- REMOVE EXISTING SINK. REMOVE HOT AND COLD WATER PIPING TO POINT INDICATED ON PLAN. REMOVE SANITARY PIPING TO BELOW SLAB AND CAP. REMOVE VENT PIPING BACK TO MAIN AND CAP.
- 4. EXISTING PLUMBING FIXTURES TO REMAIN.



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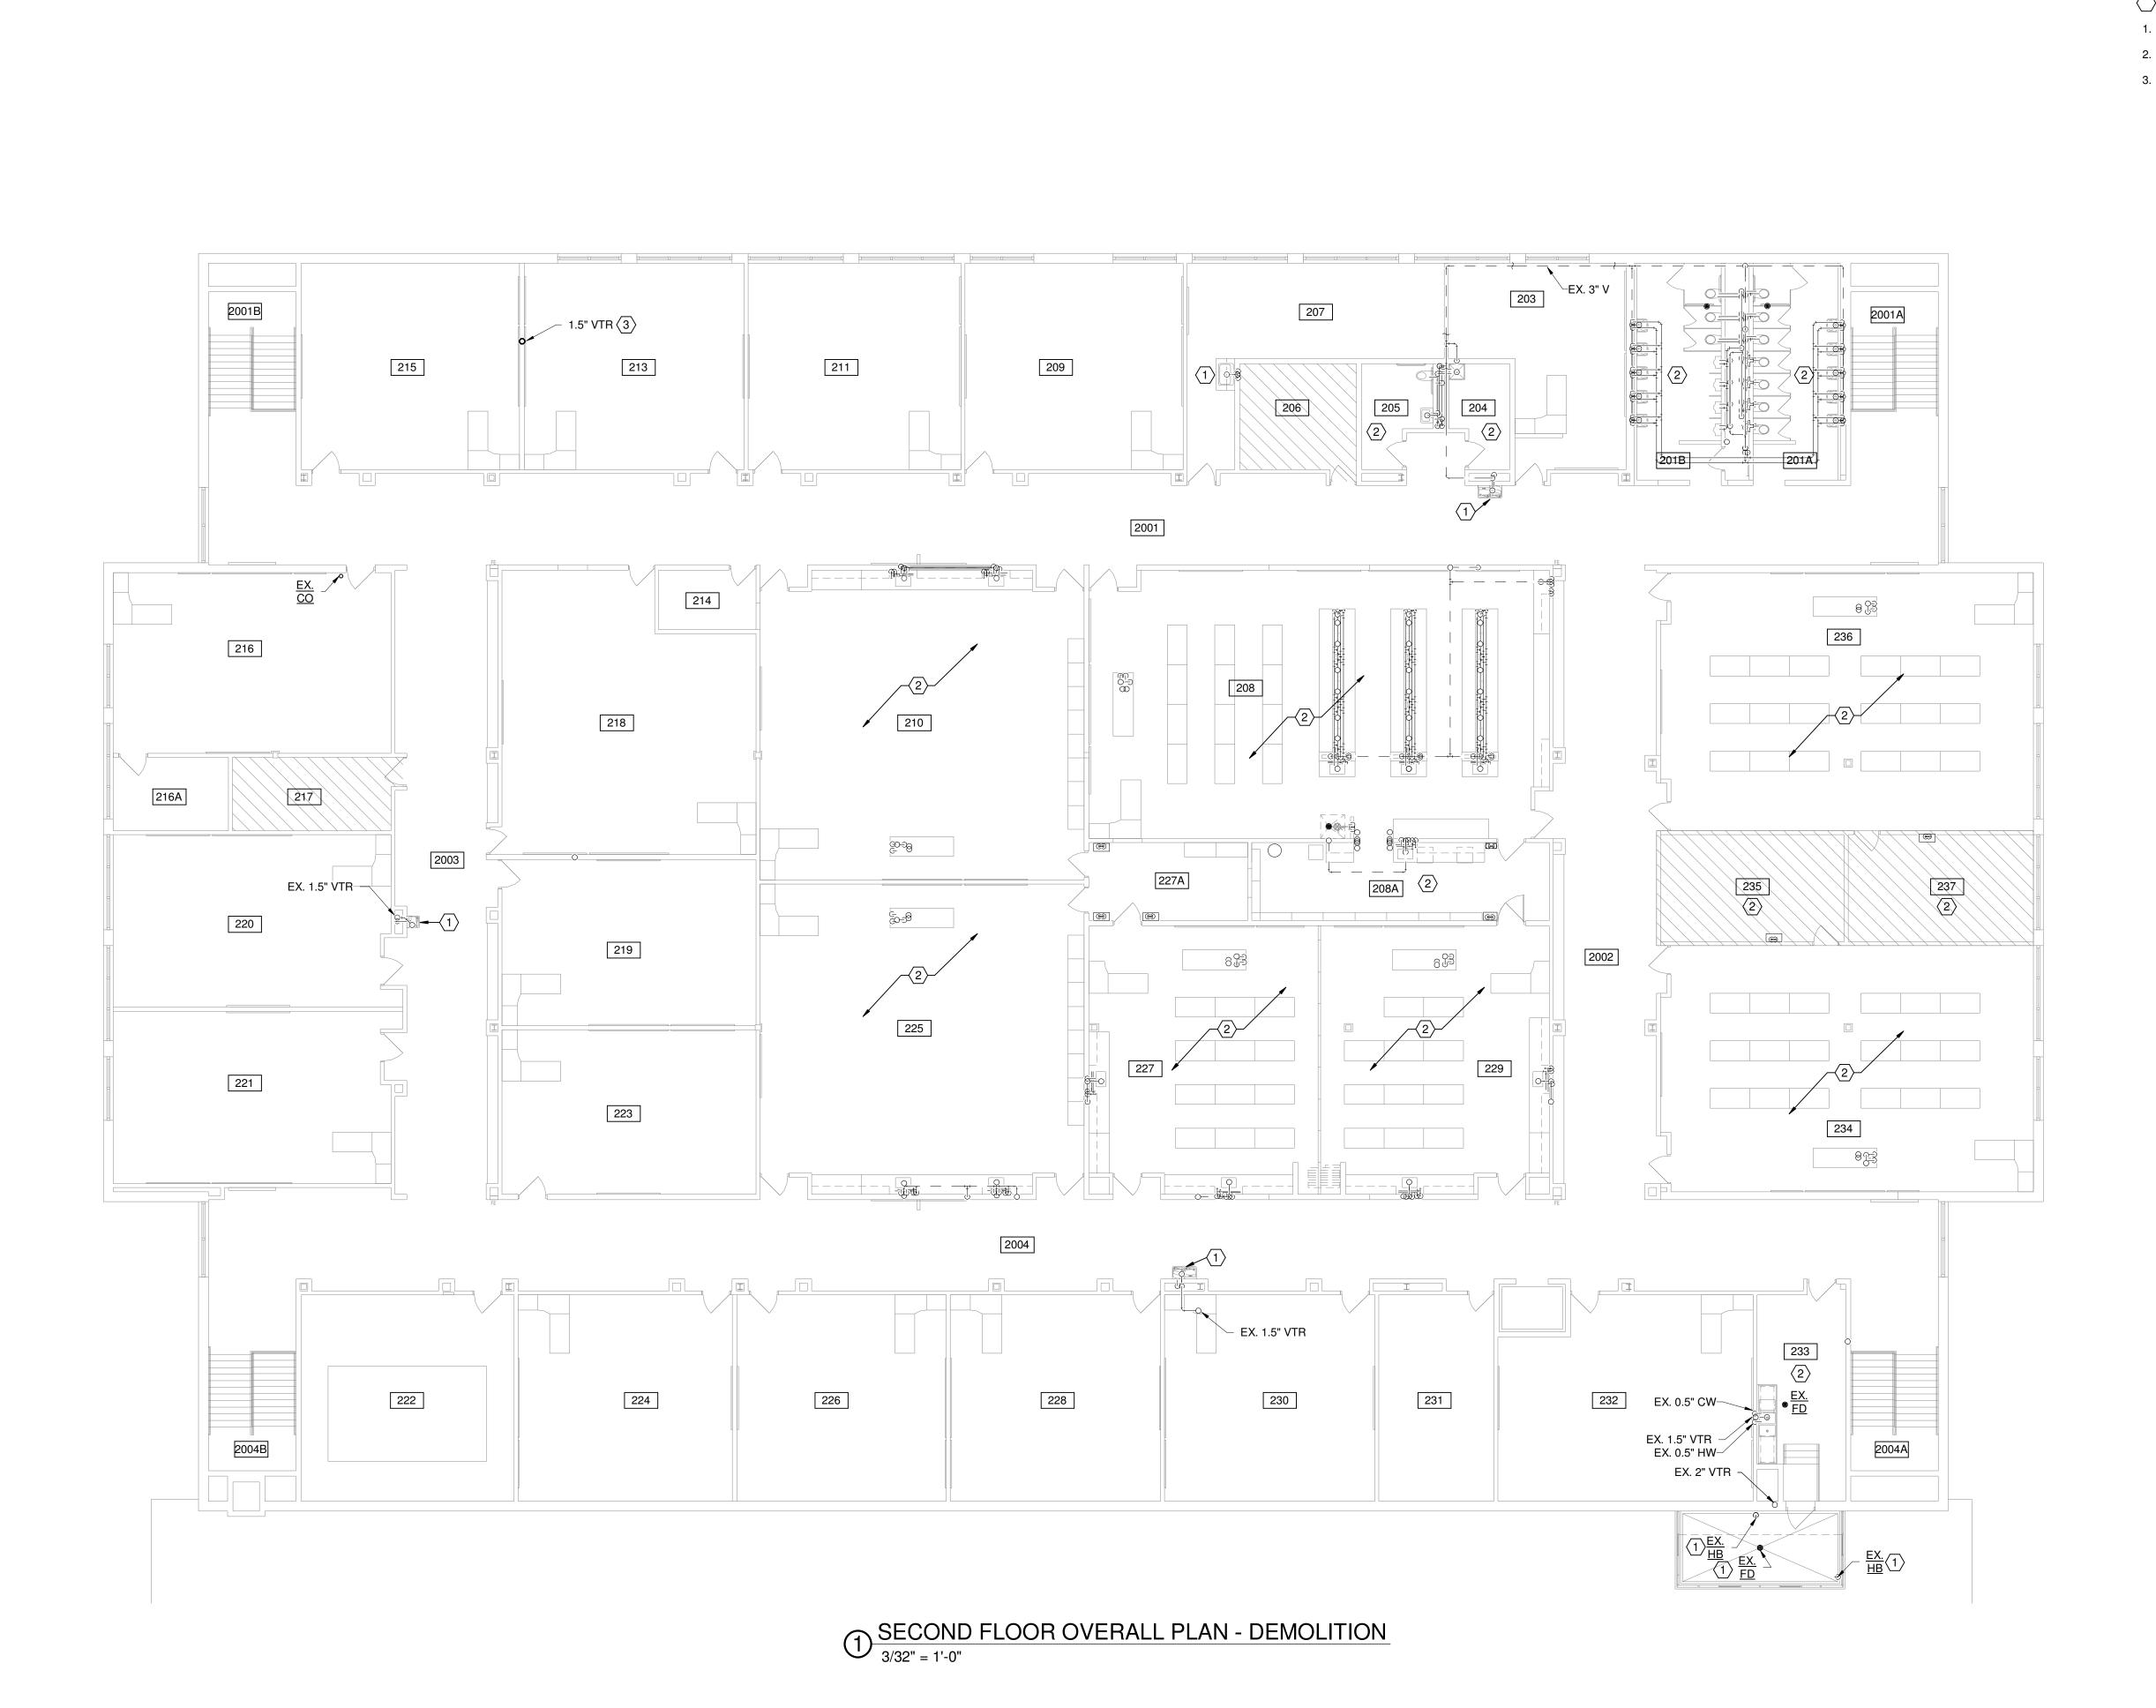
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January 24, 2022

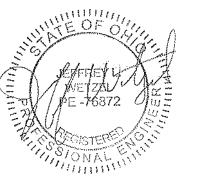Sheet Title

PLUMBING OVERALL FIRST FLOOR PLAN DEMOLITION PART 'I' - ABOVE SLAB


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- EXISTING PLUMBING FIXTURE TO REMAIN.
- NO WORK IN AREA.
- 3. REMOVE EXISTING VTR.





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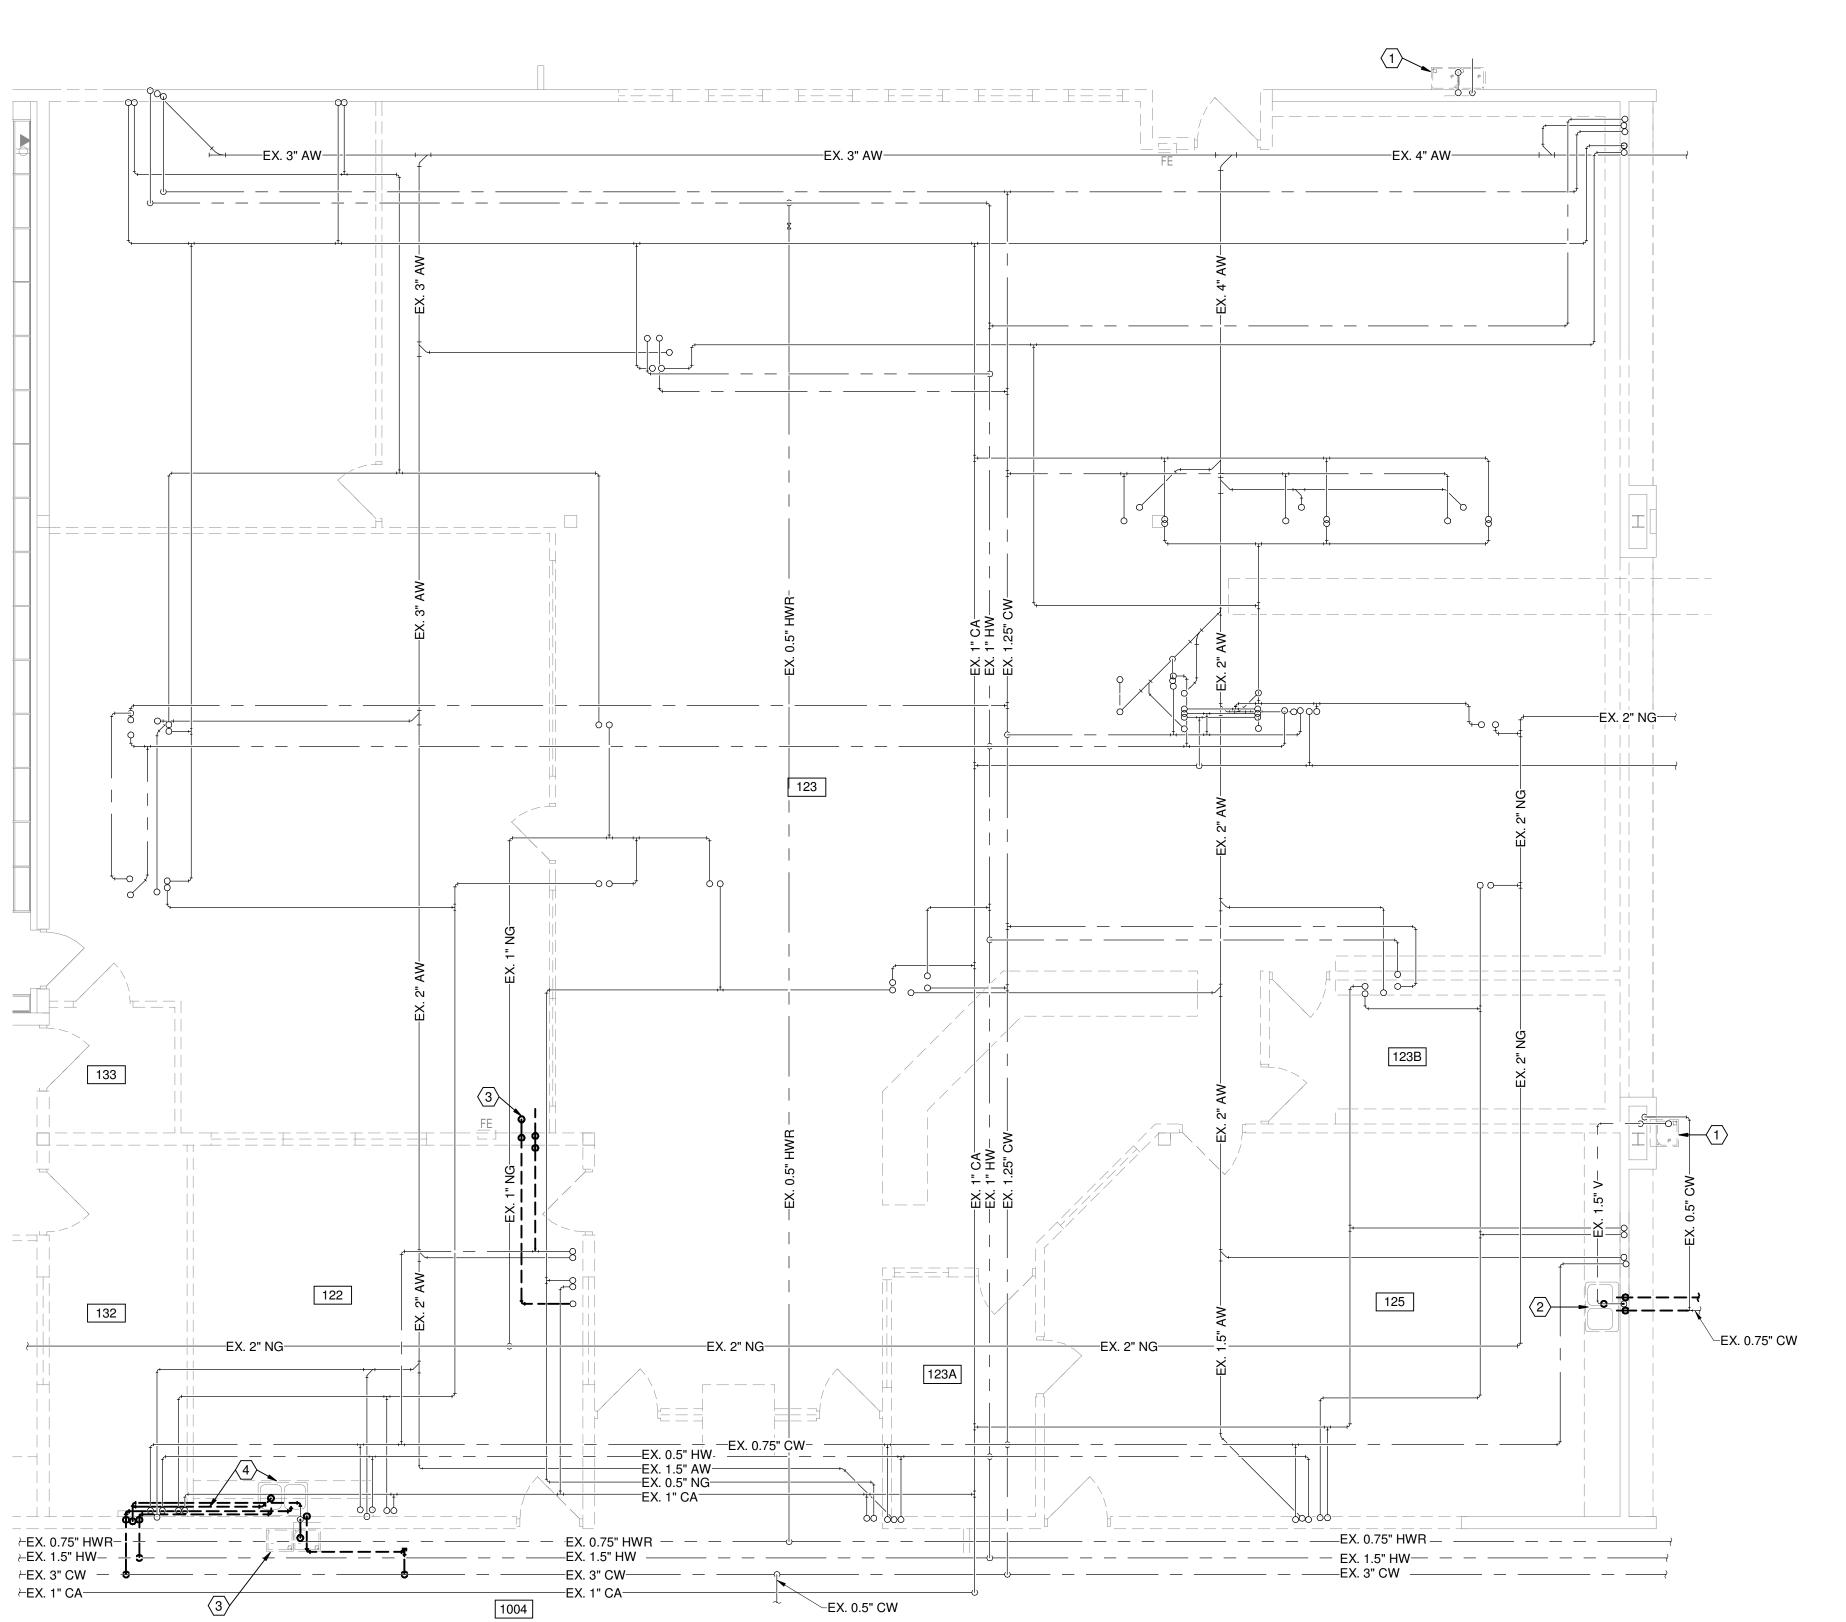
Date

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Sheet Title

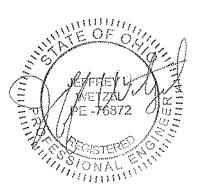PLUMBING OVERALL SECOND FLOOR PLAN DEMOLITION PART '6'

Sheet Number




 $\underbrace{1}_{3/16" = 1'-0"}$ ENLARGED FIRST FLOOR LIBRARY - DEMOLITION

DRAWING NOTES

- 1. REMOVE EXISTING DRINKING FOUNTAIN. ASSOCIATED UTILITIES TO REMAIN.
- REMOVE EXISTING SINK. REMOVE EXISTING HOT, COLD, AND VENT PIPING BACK TO MAIN AND CAP. REMOVE SANITARY PIPING TO BELOW SLAB AND CAP.
- 3. REMOVE EXISTING DRINKING FOUNTAIN. REMOVE EXISTING COLD WATER SUPPLY AND VENT PIPING BACK TO MAIN AND CAP. REMOVE SANITARY PIPING TO BELOW SLAB AND CAP.
- EXISTING SINK TO BE REMOVED. REMOVE EXISTING HOT, COLD, AND VENT PIPING BACK TO MAIN AND CAP. REMOVE SANITARY PIPING TO BELOW SLAB AND CAP.



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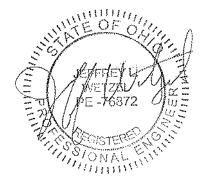
Sheet Title

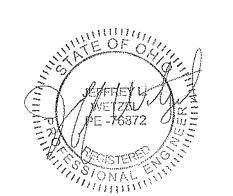PLUMBING ENLARGED LIBRARY FIRST FLOOR -DEMOLITION

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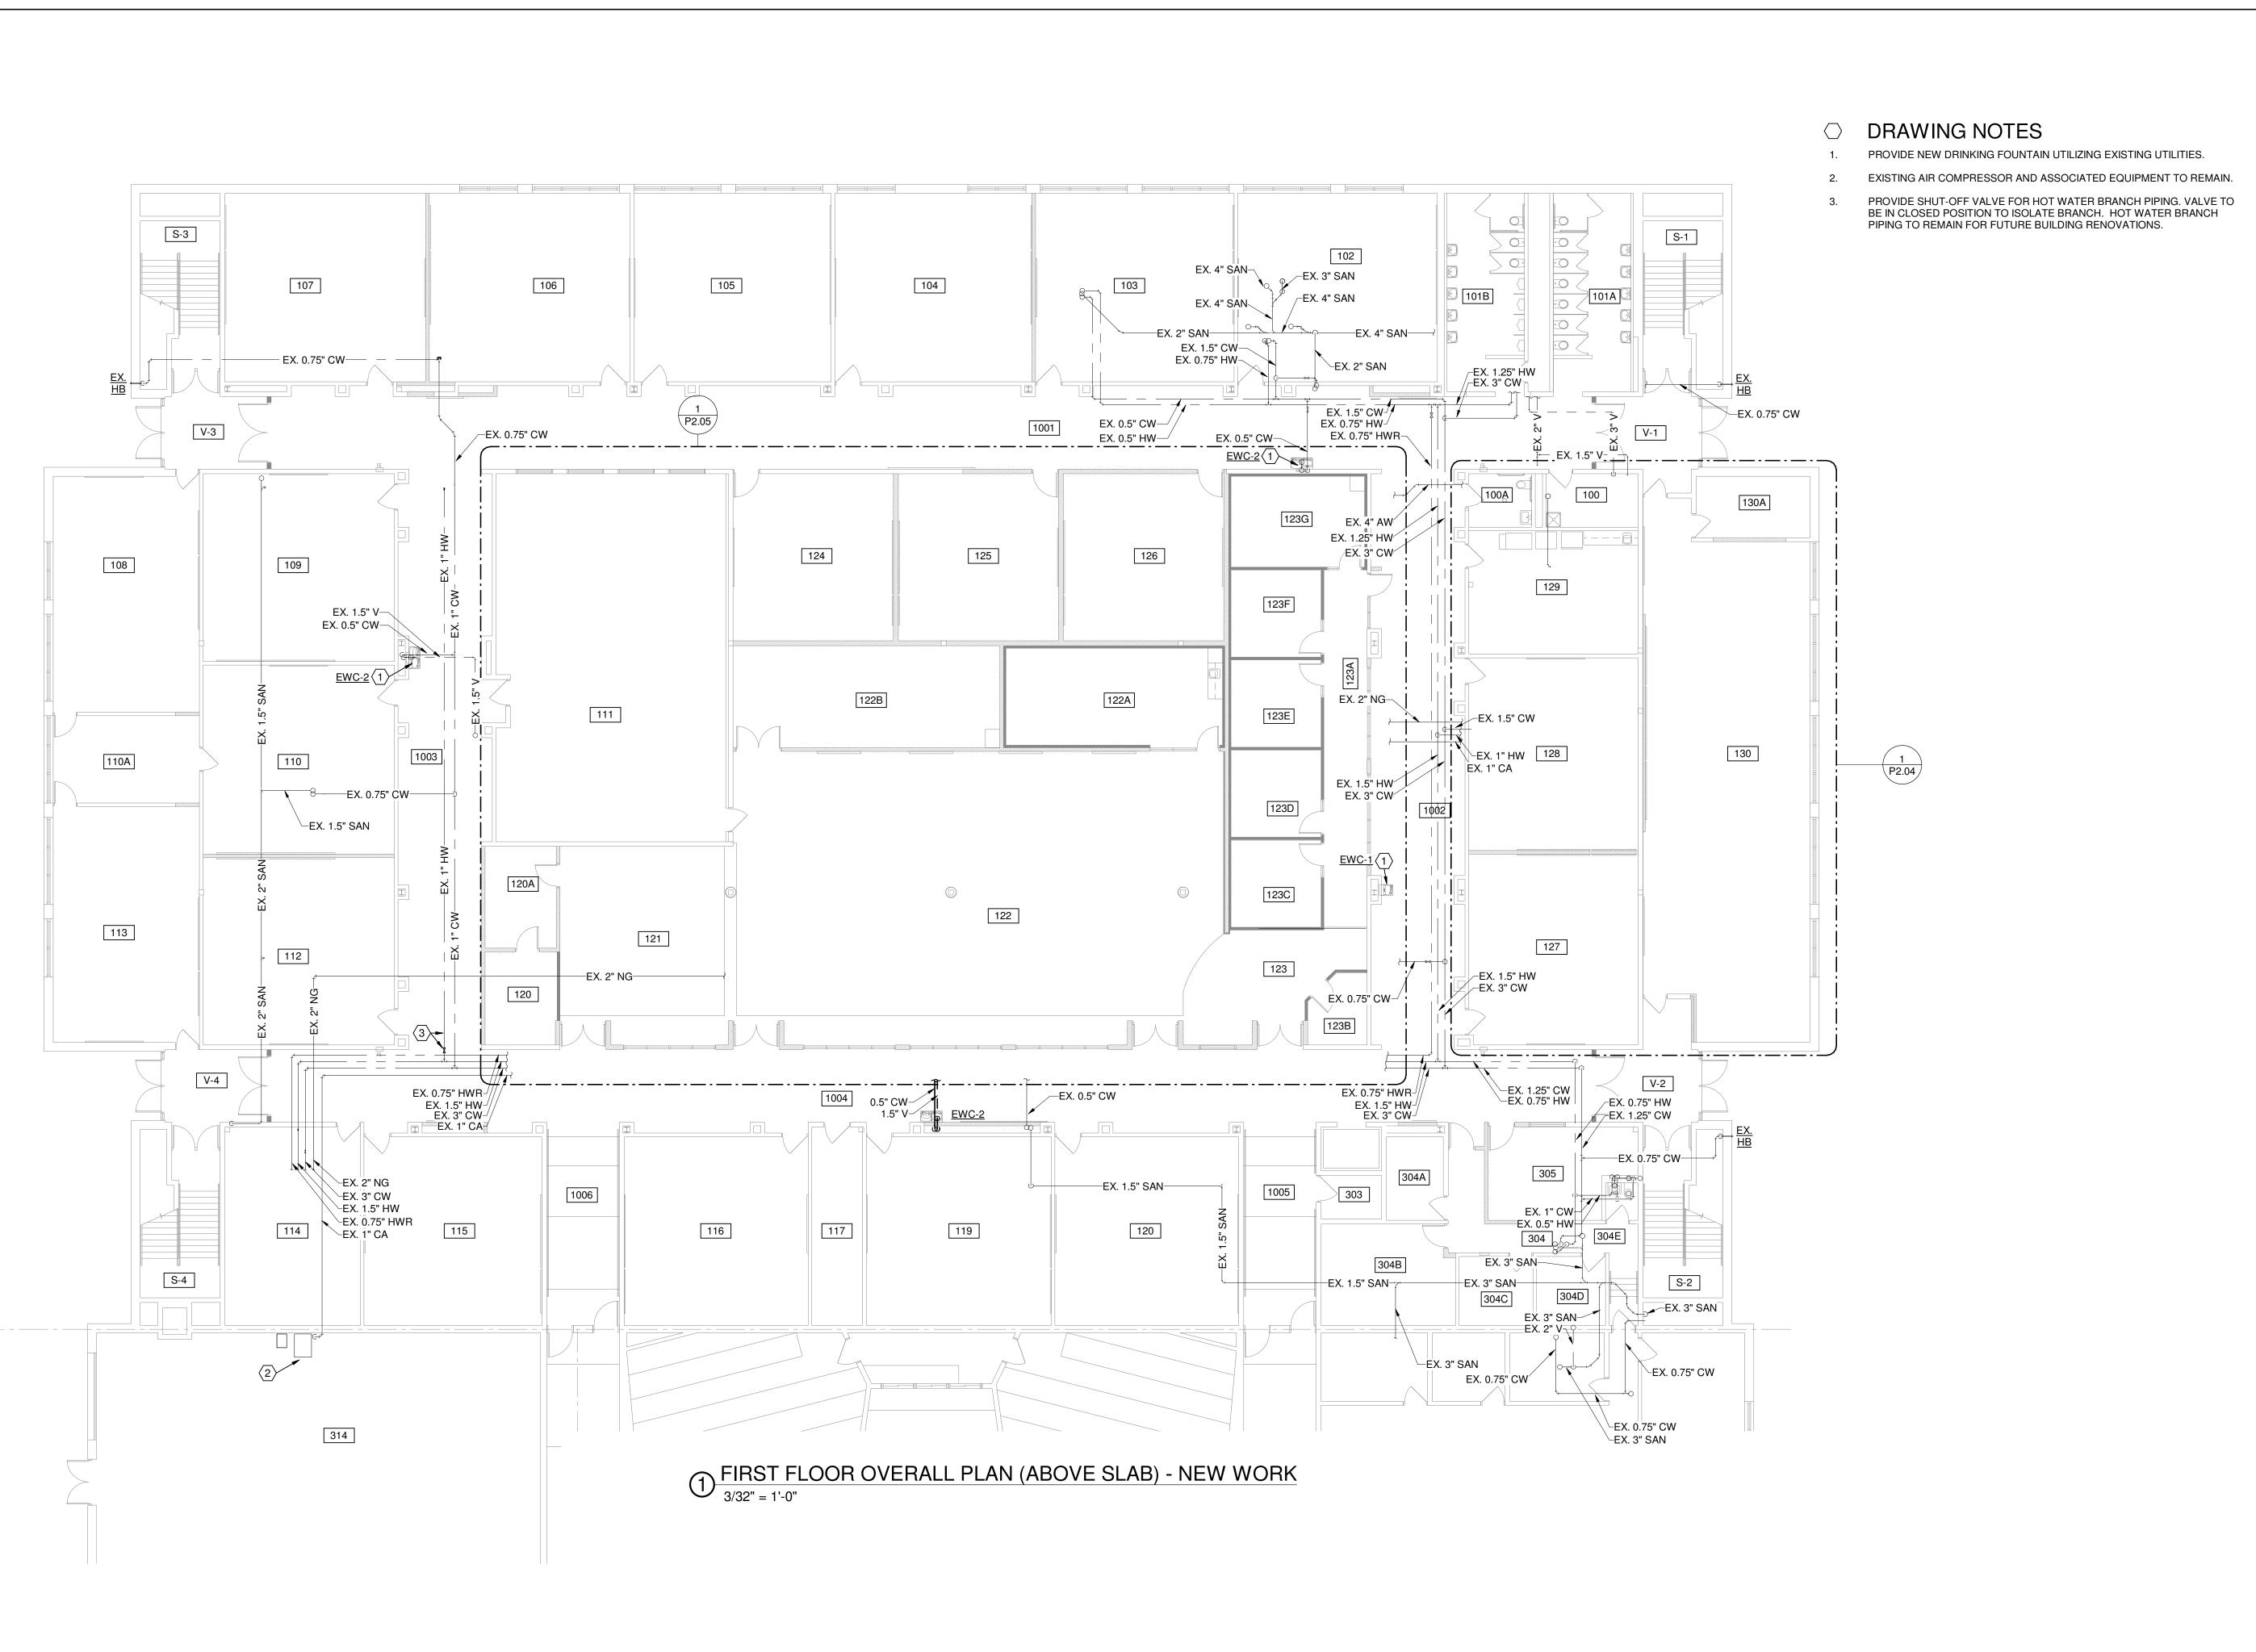
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Sheet Title

PLUMBING OVERALL FIRST FLOOR PLAN NEW WORK PART 'I' - BELOW SLAB

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PLUMBING OVERALL FIRST FLOOR PLAN NEW WORK PART 'I' - ABOVE SLAB

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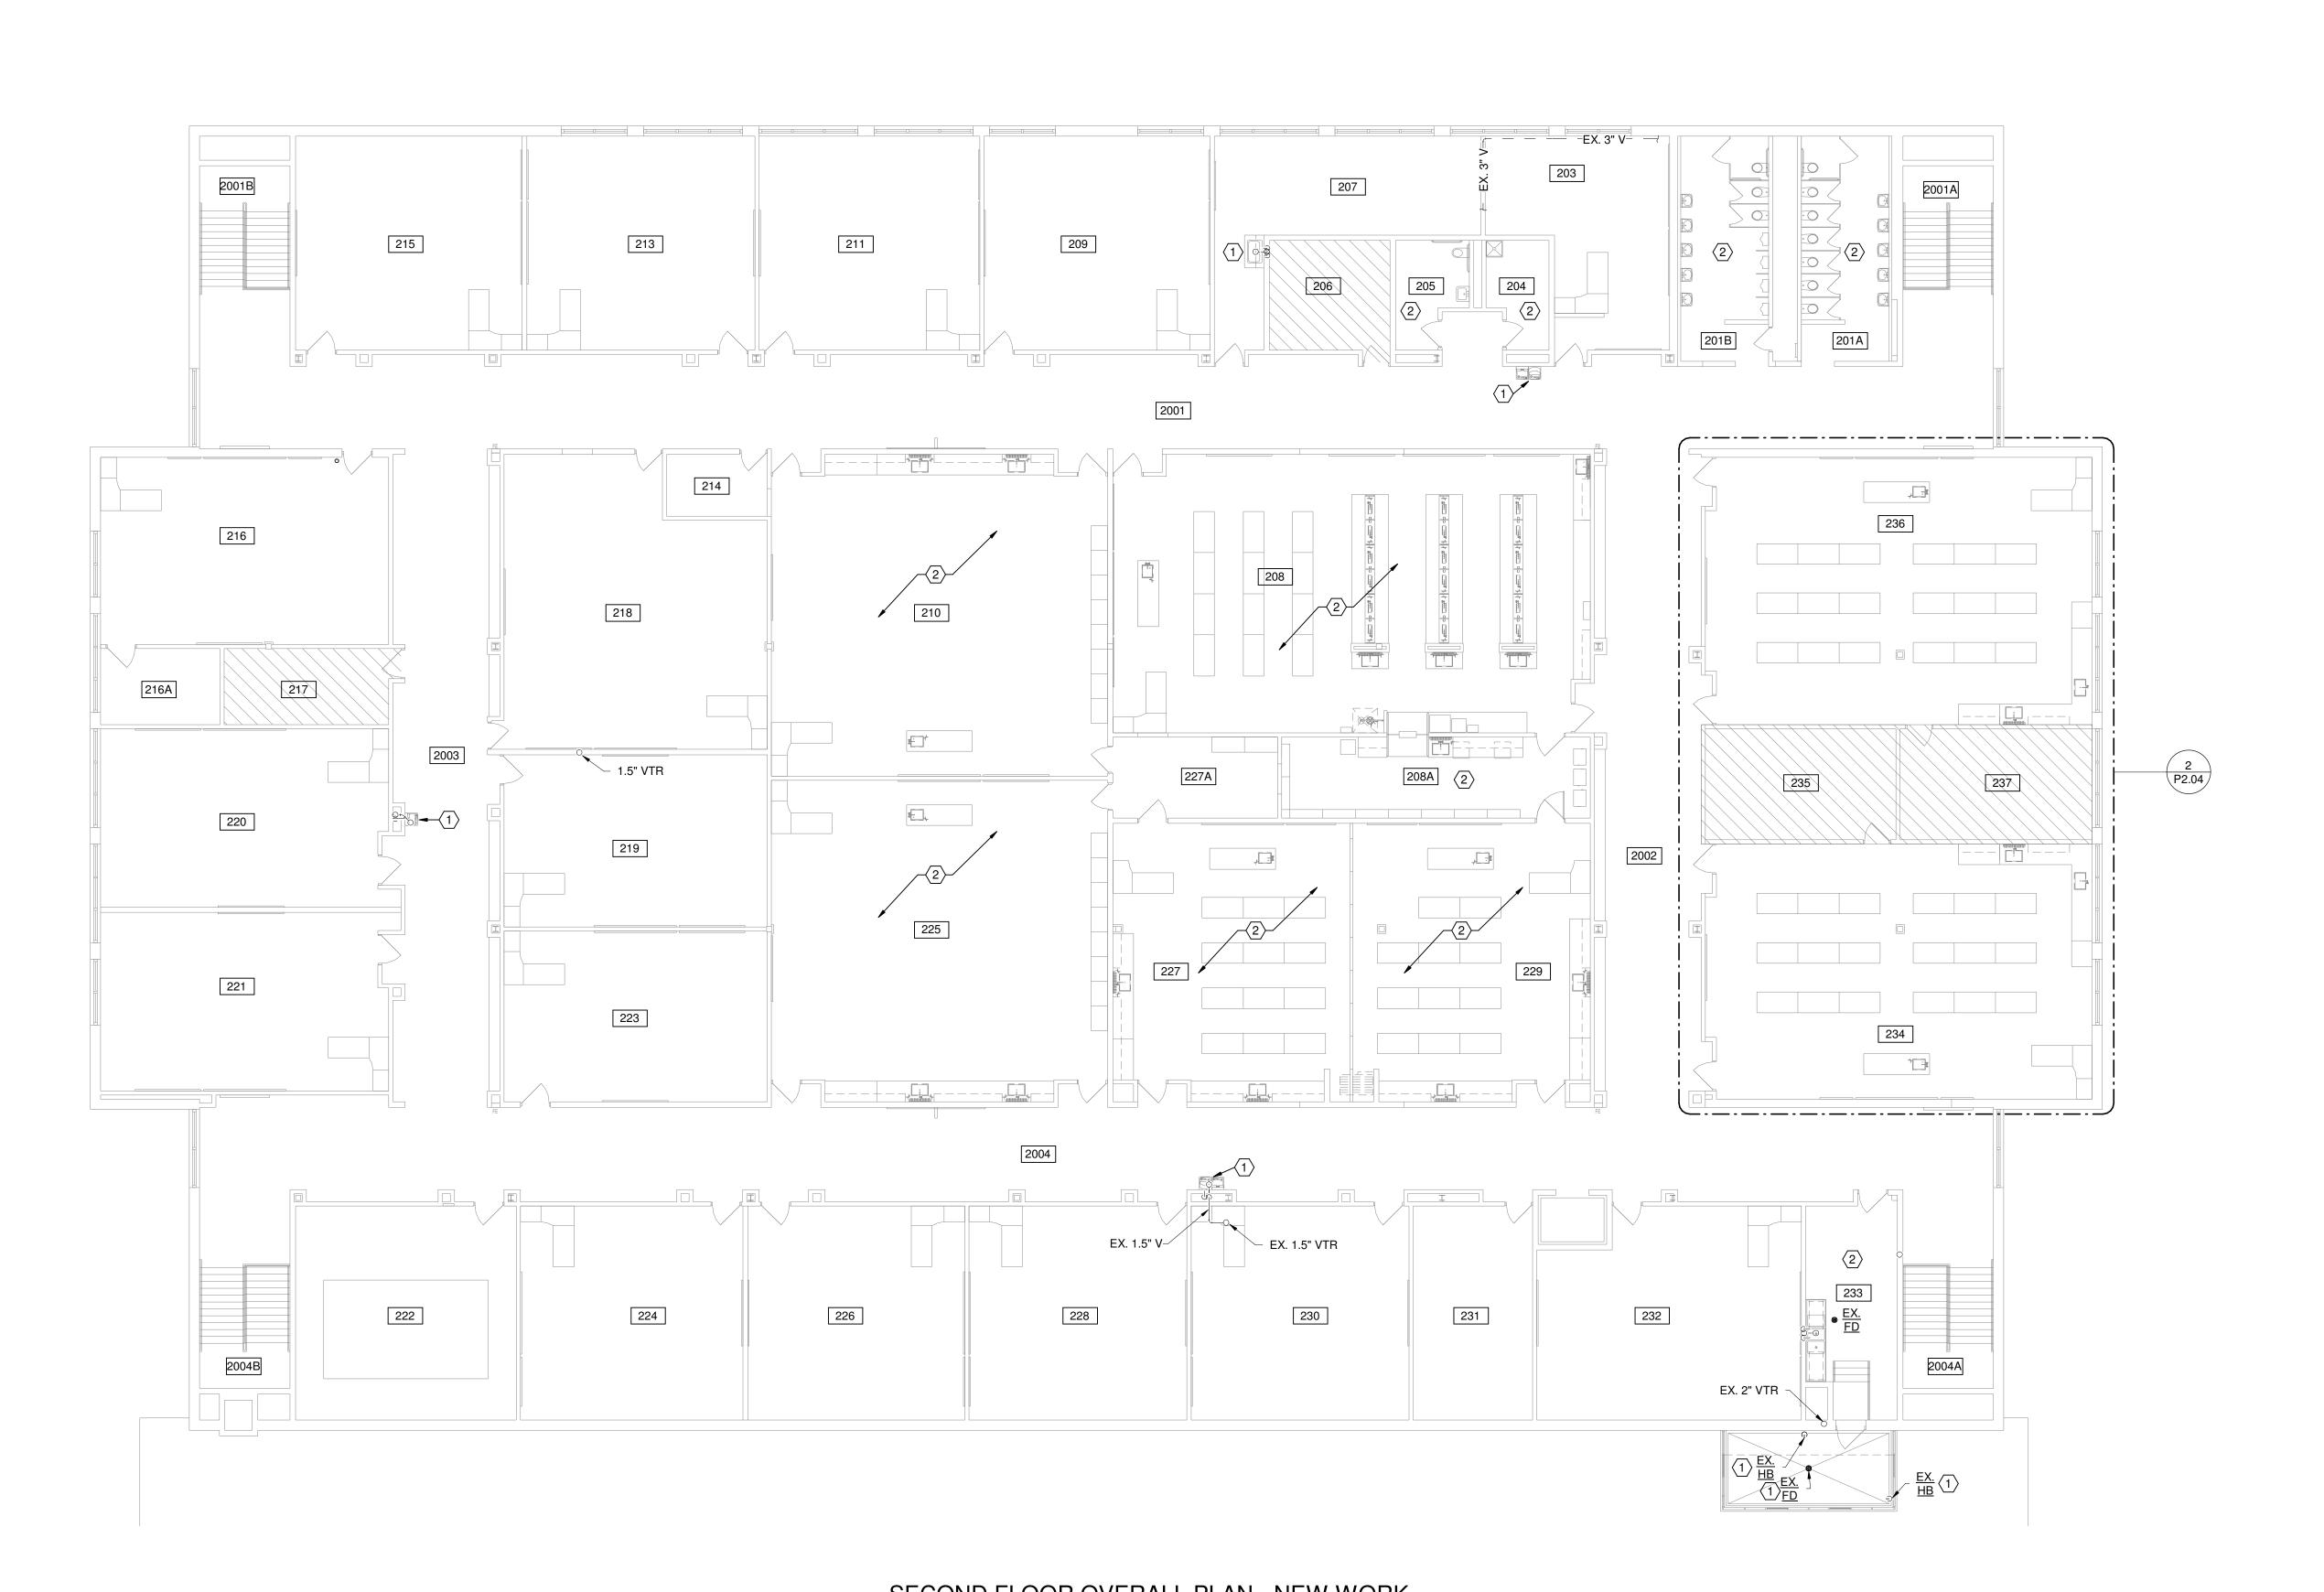
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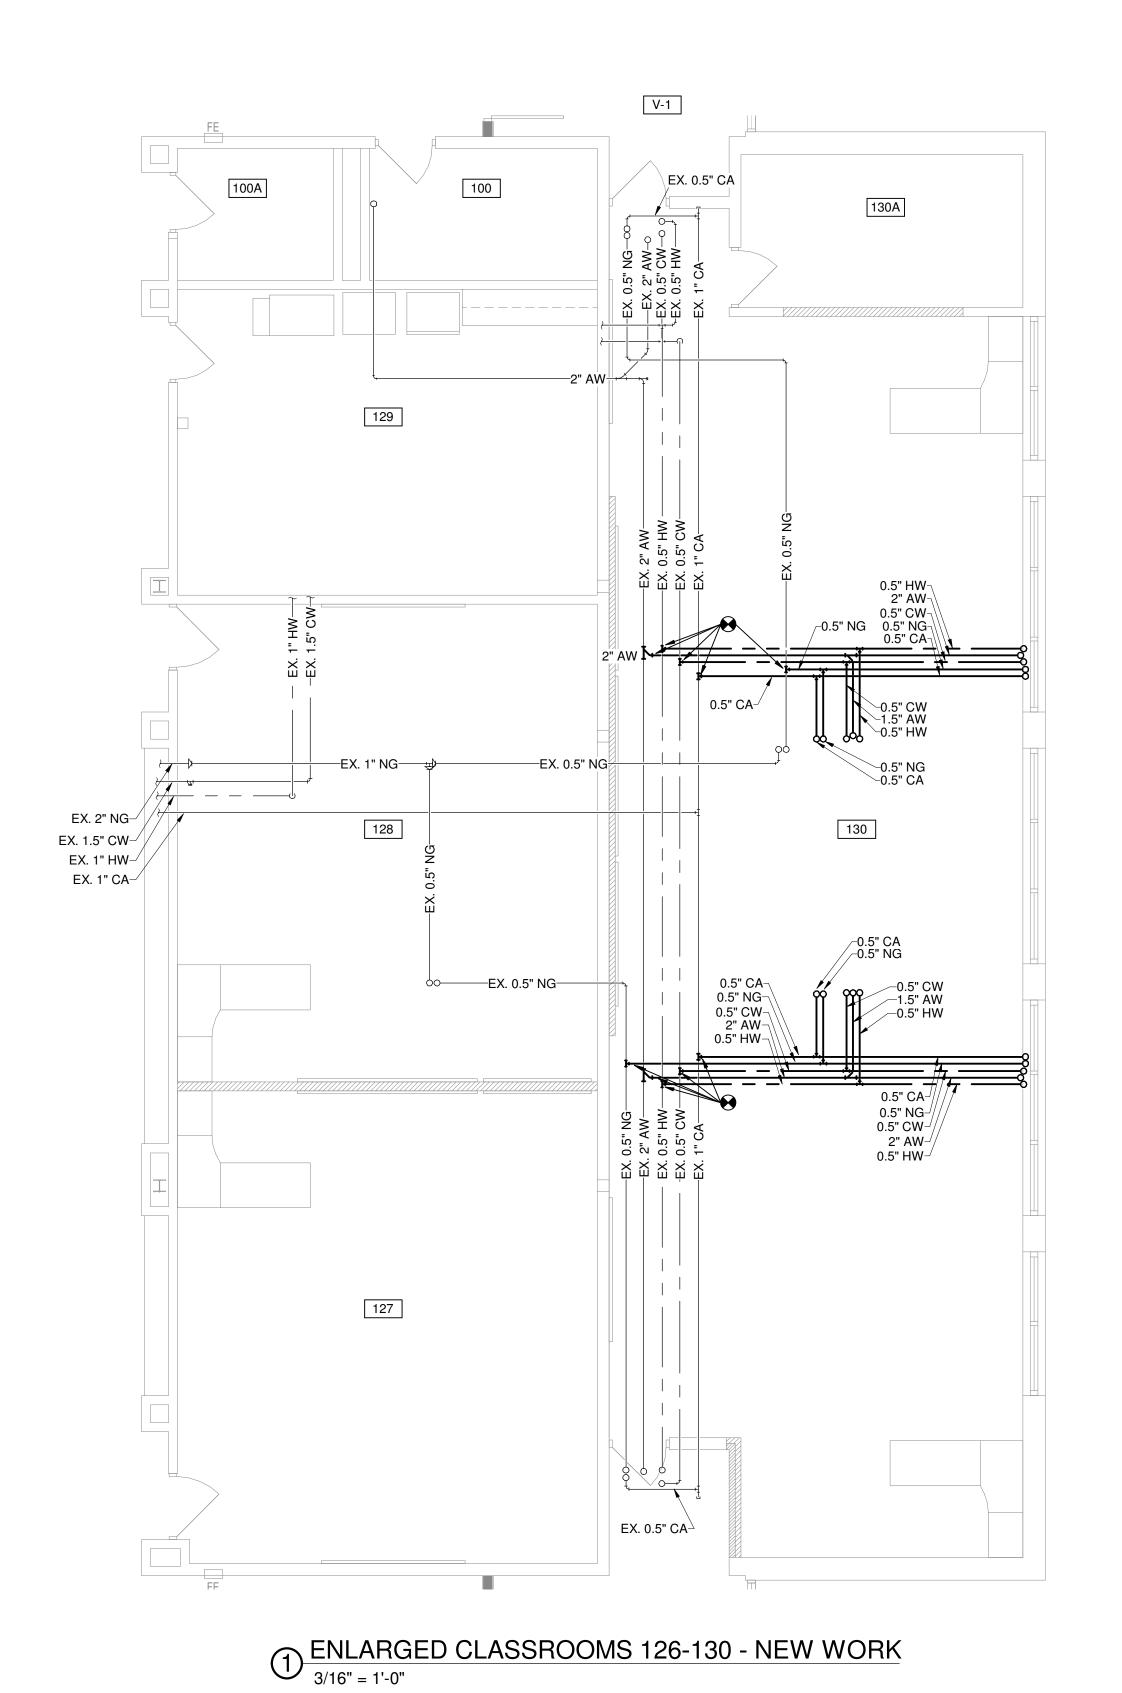
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Sheet Title

PLUMBING OVERALL SECOND FLOOR PLAN NEW WORK PART '6'


Sheet Number





DRAWING NOTES

- EXISTING NATURAL GAS CONTROL CABINET TO REMAIN.
- SINK & FAUCET PROVIDED BY LABORATORY CASEWORK SUPPLIER. PROVIDE 0.5" CW, 0.5" HW, 1.5" AW, 0.375" CA, AND 0.375" NG CONNECTIONS. FINAL LAB VALVES BY CASEWORK SUPPLIER. FIELD COORDINATE STUB LOCATIONS PRIOR TO ROUGH-IN. FINAL CONNECTIONS MADE BY P.C. COORDINATE WITH ARCHITECTURAL
- EXISTING GAS CONTROL CABINET TO CONTROL GAS VALVES IN ROOM 236 TO REMAIN.
- EXISTING GAS CONTROL CABINET TO CONTROL GAS VALVES IN ROOM 234 TO REMAIN.

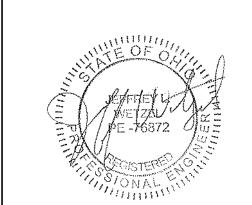

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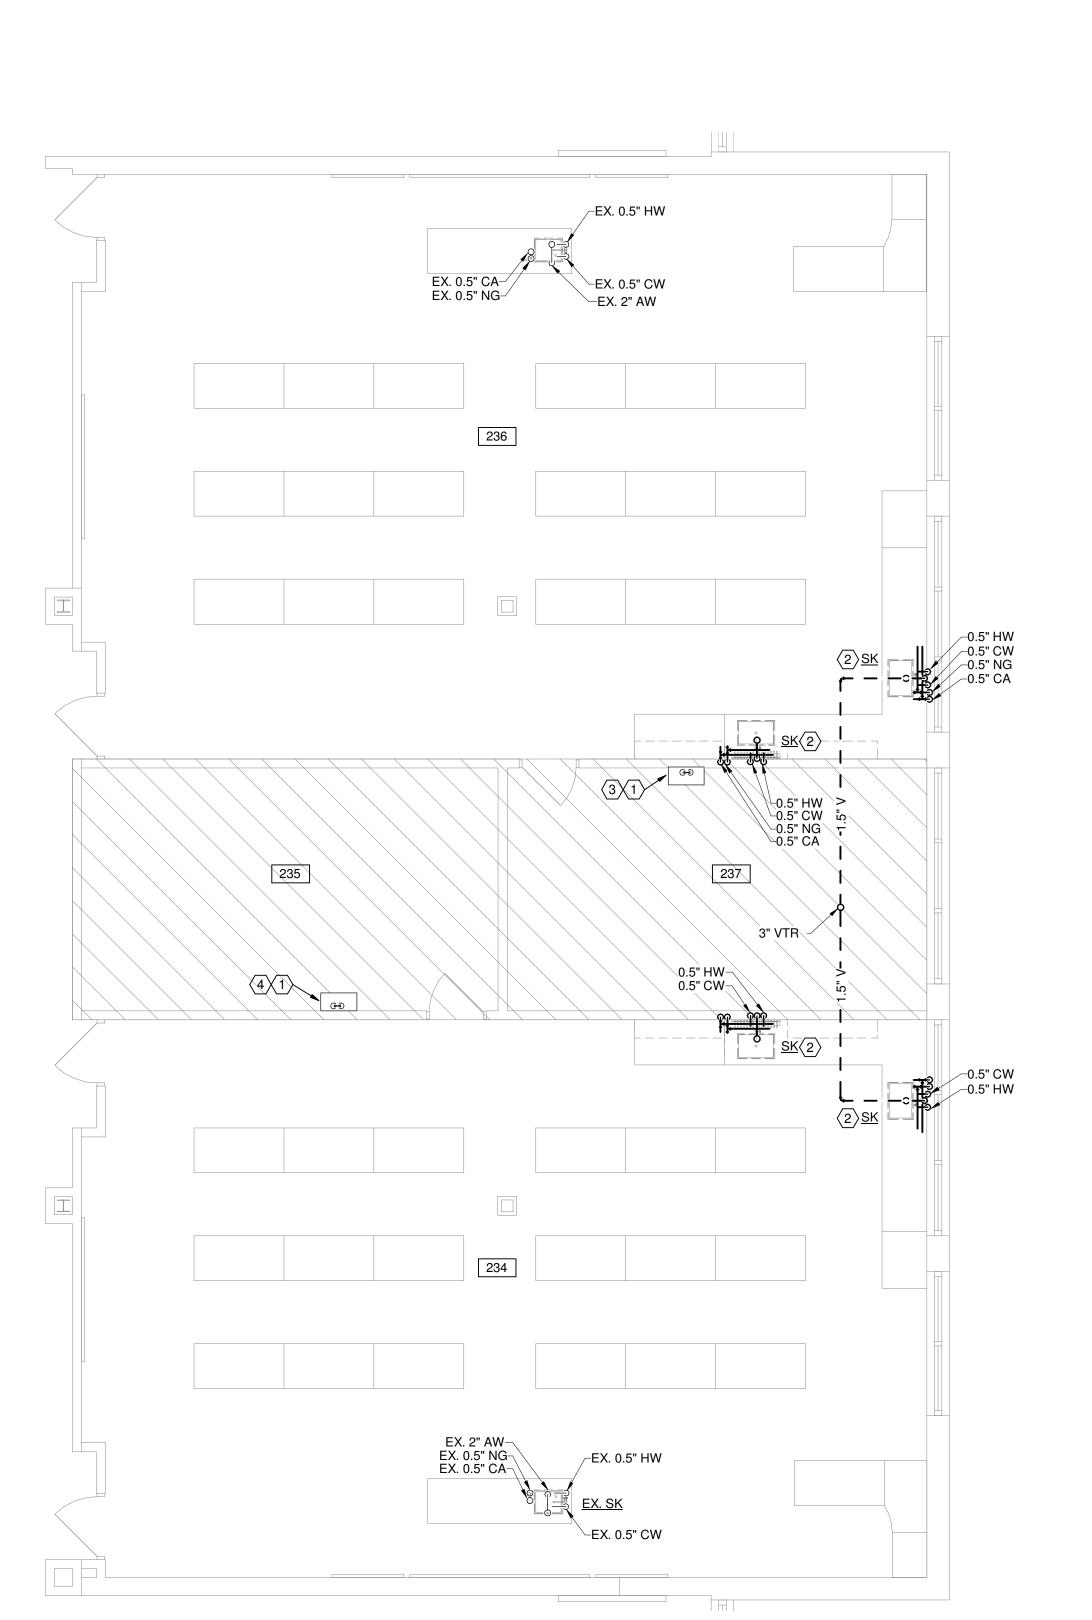
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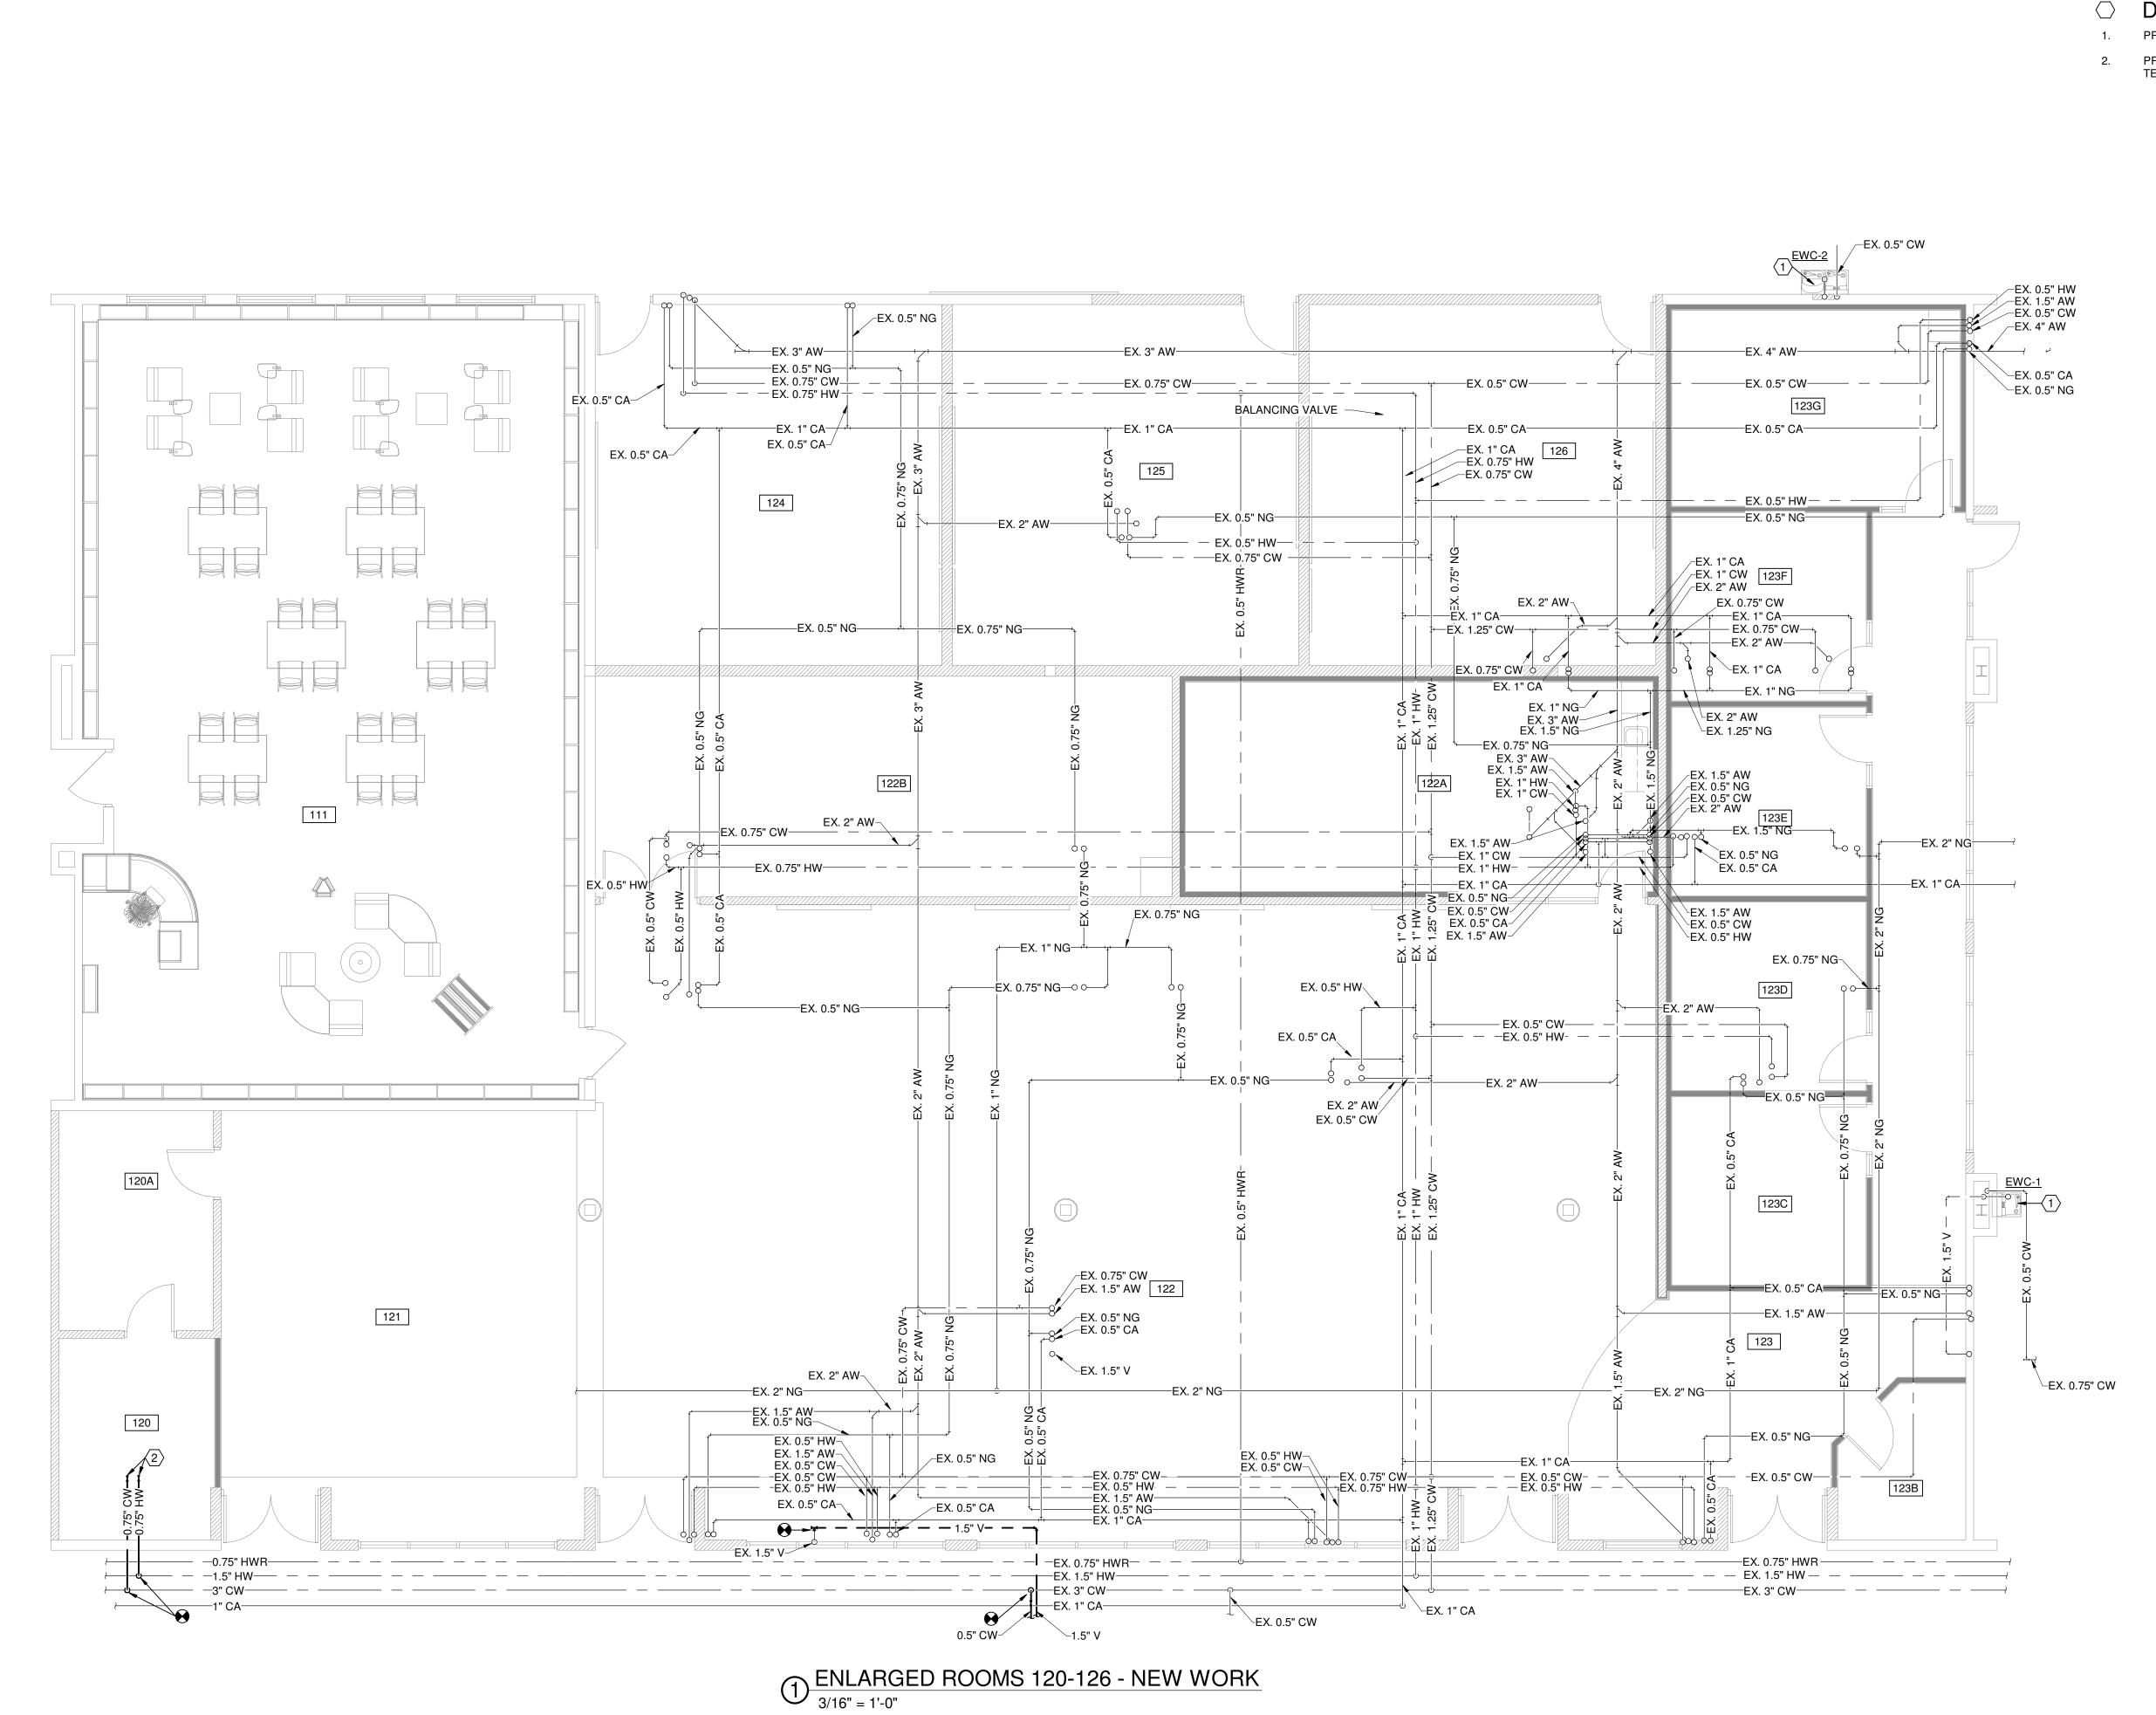
Sheet Title

PLUMBING ENLARGED CLASSROOMS | 27-| 30, 234 \$ 236 PLANS - NEW WORK

Sheet Number




2 ENLARGED CLASSROOMS 234 & 236 - NEW WORK 3/16" = 1'-0"





- PROVIDE NEW DRINKING FOUNTAIN UTILIZING EXISTING UTILITIES.
- PROVIDE 0.75" HOT & COLD WATER PIPING TO ROOM 120 AND TERMINATE WITH SHUT-OFF VALVE FOR FUTURE CONNECTION.



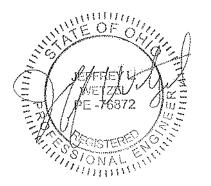

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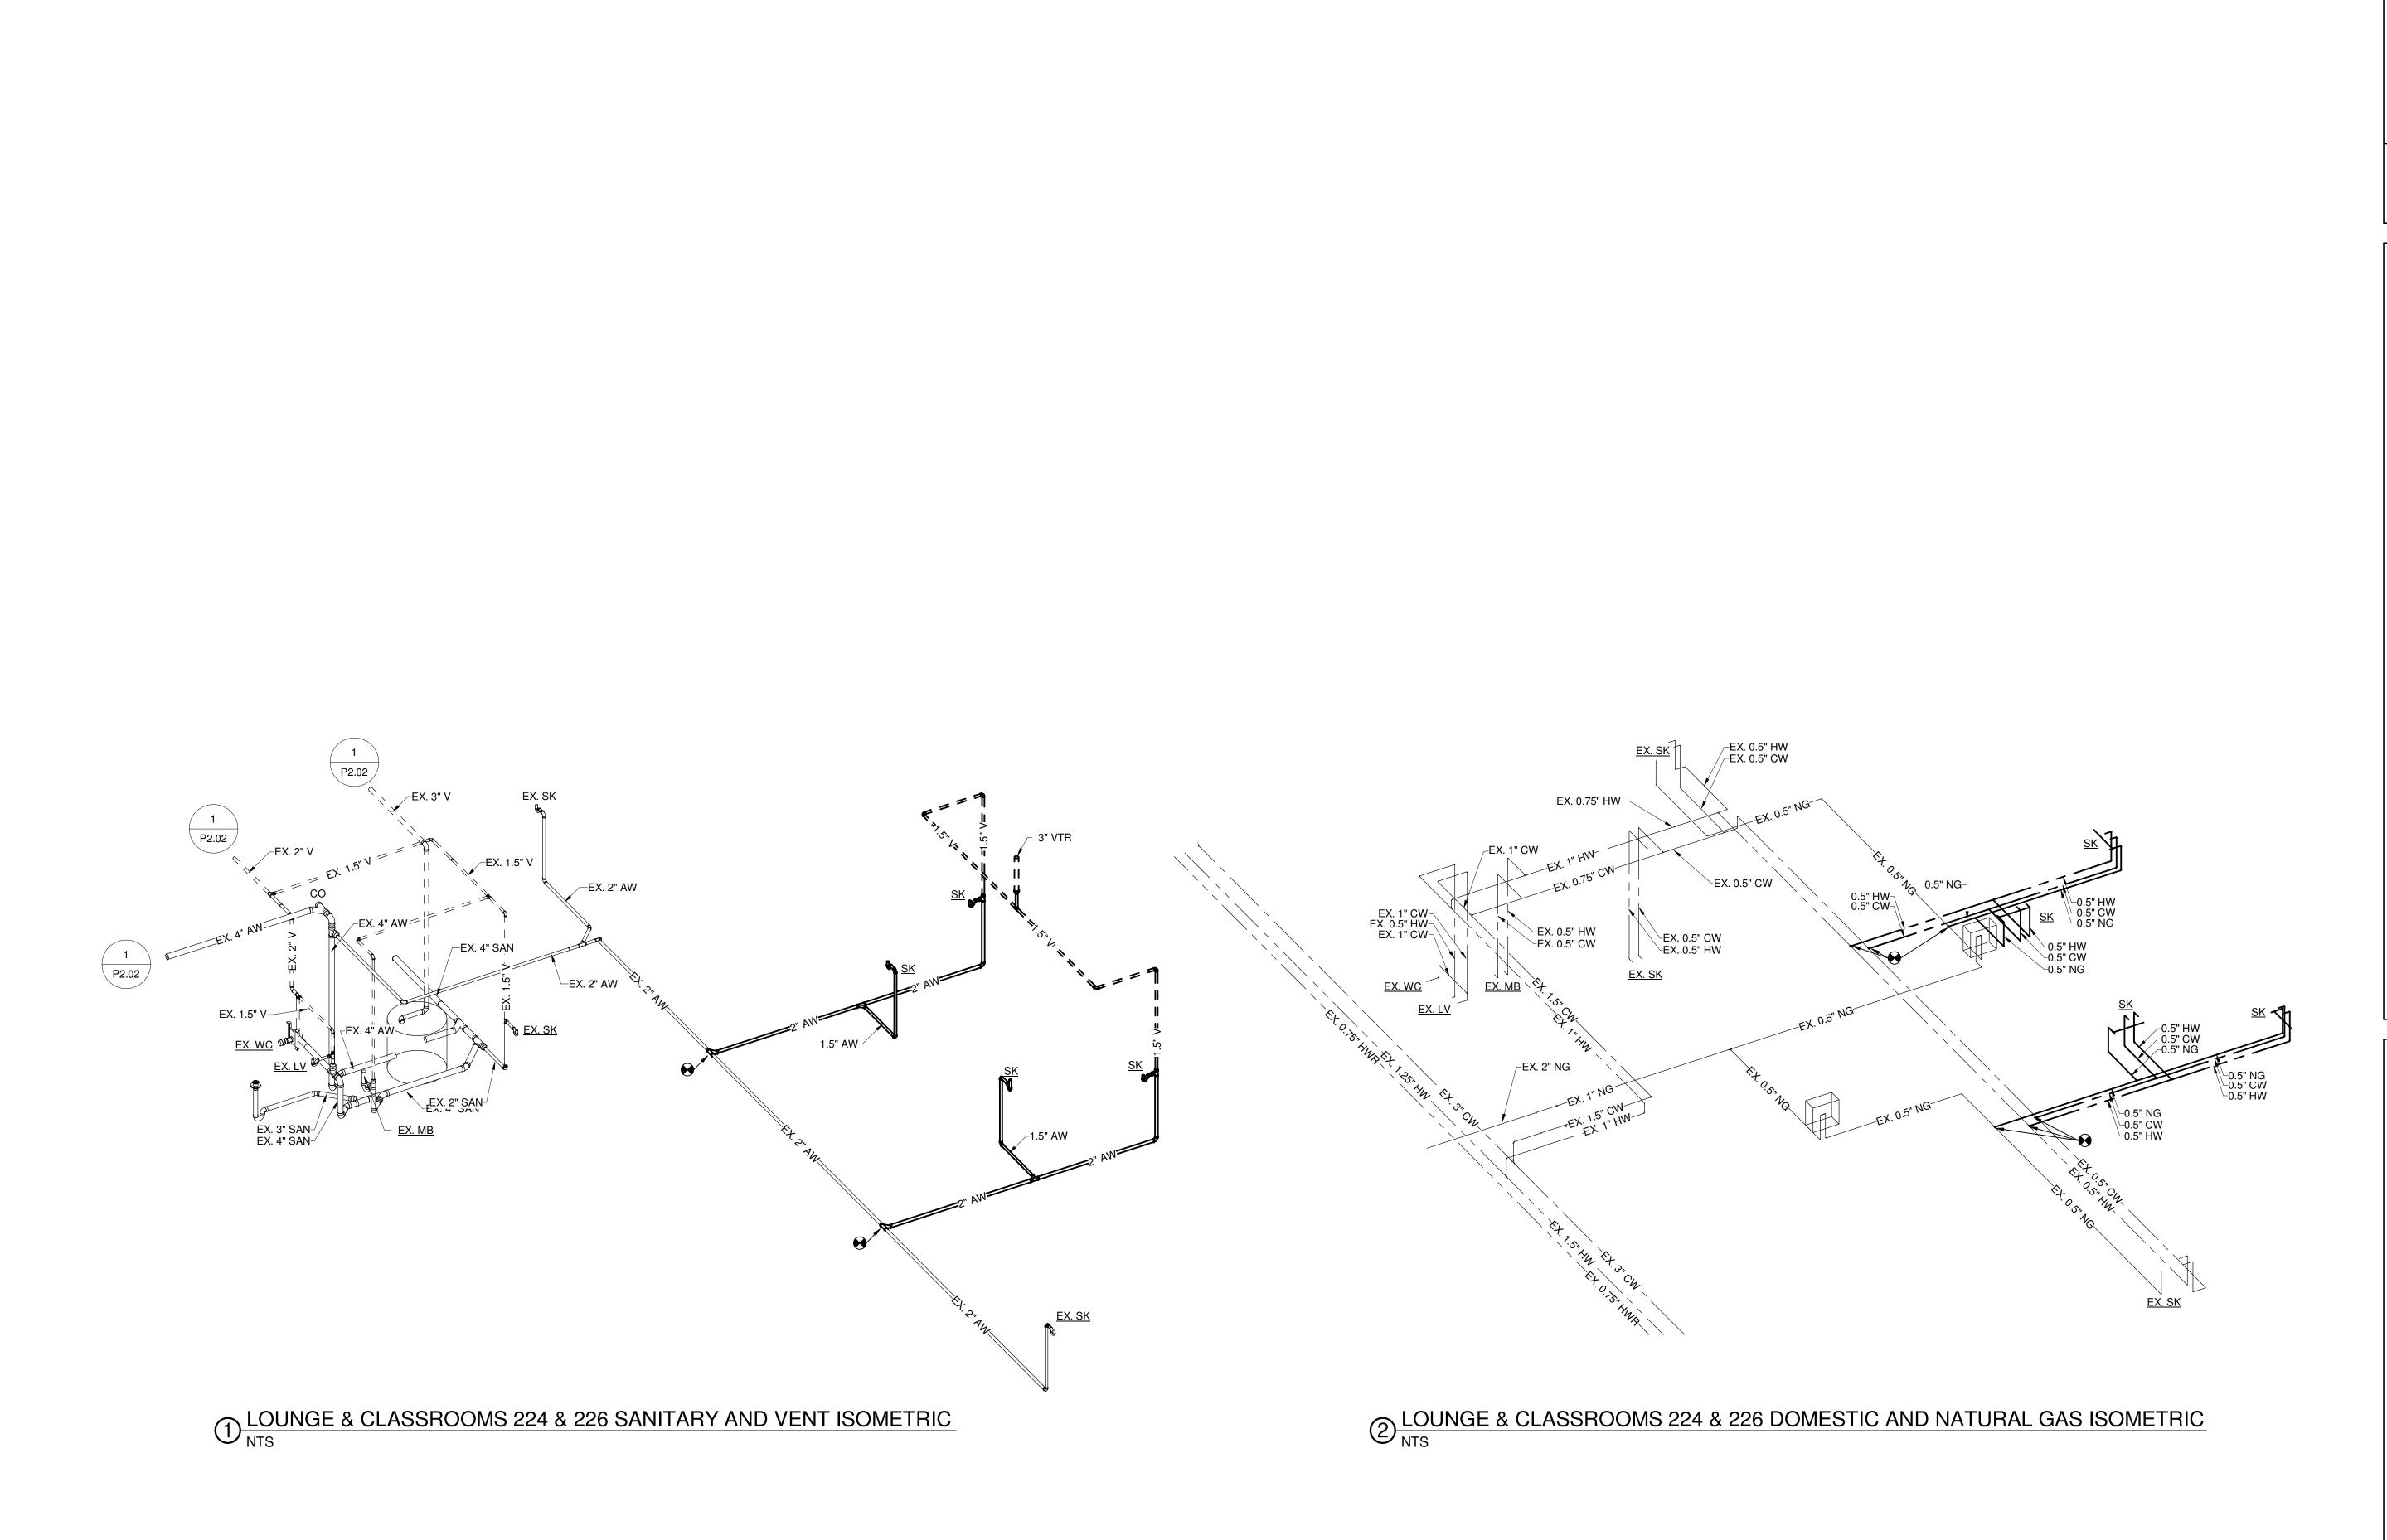
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Sheet Title

PLUMBING ENLARGED ROOMS 120-126 PLANS -NEW WORK

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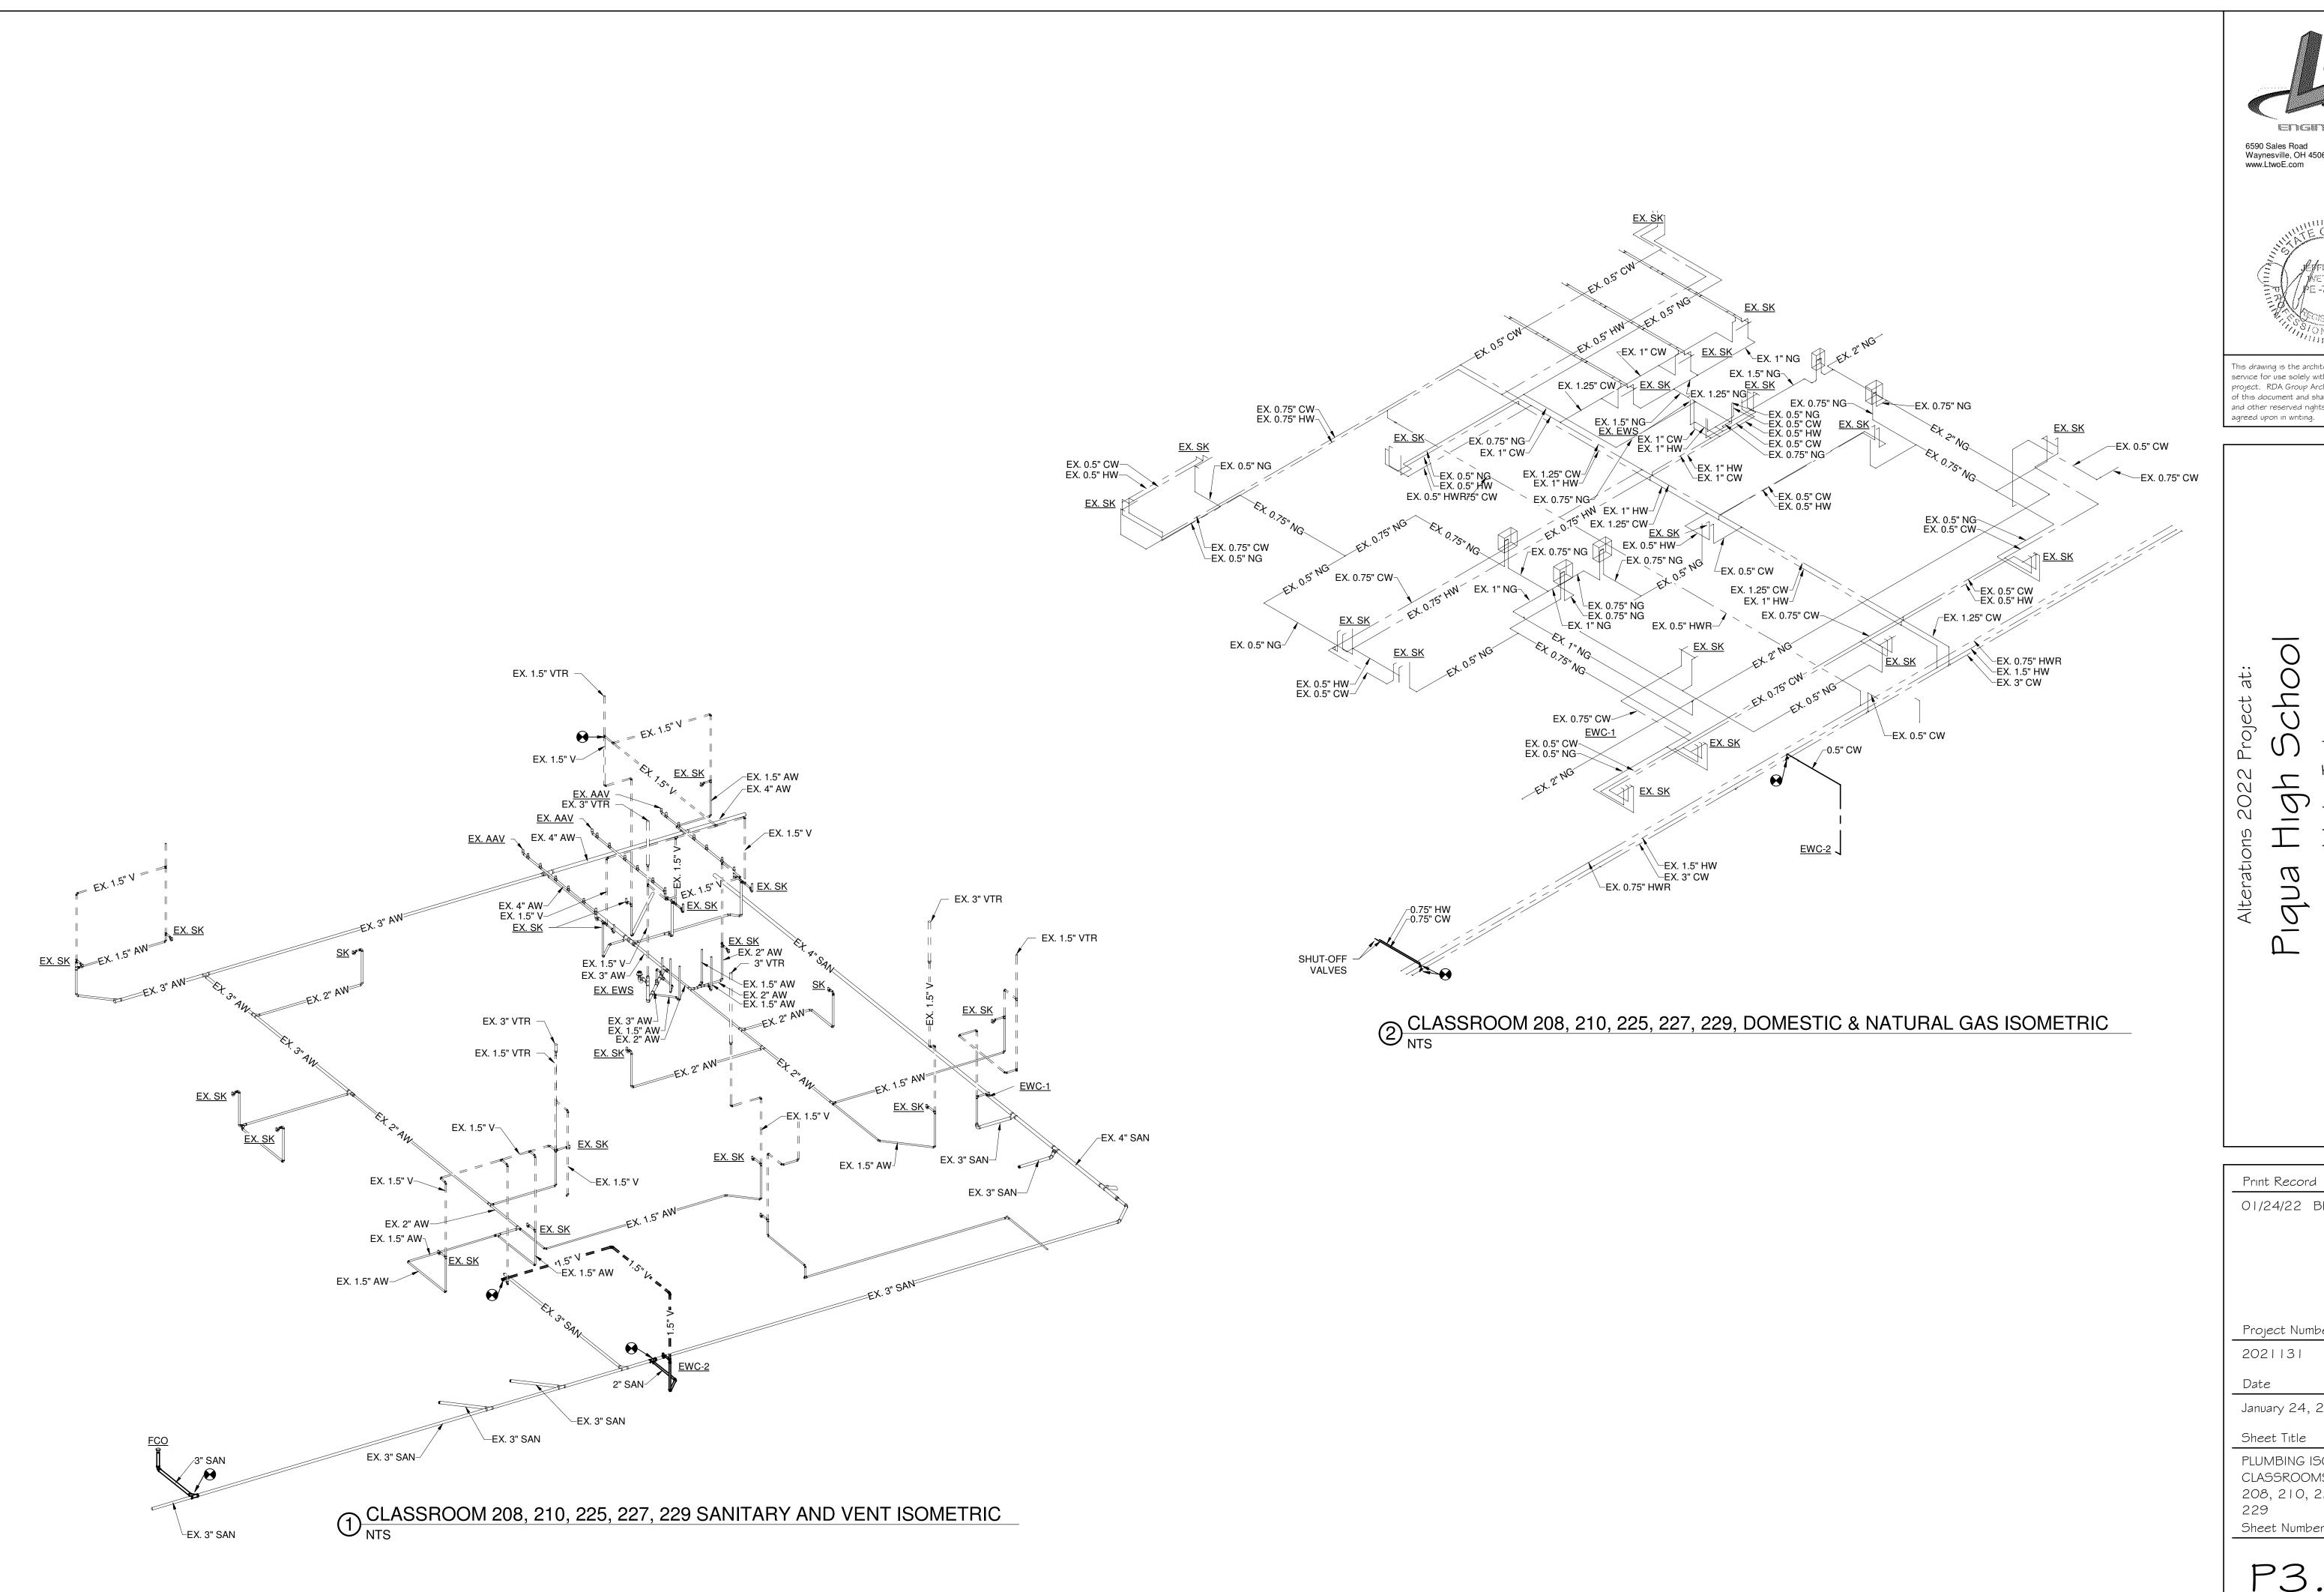
January 24, 2022

Sheet Title


PLUMBING ISOMETRICS -LOUNGE AND CLASSROOMS 224 \$ 226

Sheet Number

P3.01





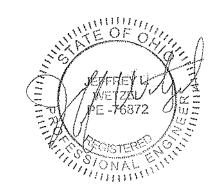

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Sheet Title

PLUMBING ISOMETRICS -CLASSROOMS 120-126, 208, 210, 225, 227,

Sheet Number

P3.02

	PLUMBING FIXTURE SCHEDULE									
PLAN	FIXTURE TYPE	DESCRIPTION	CONN	IECTION	I SIZE	(IN.)	NOTES			
MARK	FIXTURE LIPE	DESCRIPTION	SAN	VENT	CW	HW	NOTES			
EWC-1	DRINKING FOUNTAIN	ELKAY MODEL #LZSG8WSSK, SINGLE ADA COOLER WITH BOTTLE FILLER, 120V-1PH, 8 GPH	1.5	-	0.5	-	-			
EWC-2	DRINKING FOUNTAIN	ELKAY MODEL #LZSTLG8WSSK, BI-LEVEL, ADA WITH BOTTLE FILLER, 120V-1PH, 8 GPH	1.5	-	0.5	-	1			
СО	CLEANOUT	INTERIOR FLOOR CLEANOUTS SHALL HAVE GASKETED WATER-TIGHT SCORIATED ADJUSTABLE SCREW SECURED ROUND TOP; CLEANOUTS SHALL BE SMITH MODEL #4043 ASSEMBLY AND SHALL HAVE POLISHED NICKEL BRONZE TOPS. EXTERIOR CLEANOUTS SHALL BE PROVIDED WITH BROOKS MODEL #3-RT OPEN BOTTOM CONCRETE BOX WITH STEEL FRAME AND TRAFFIC COVER WITH THE WORD "SEWER" CAST IN COVER	-	-	-	-	-			





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PLUMBING SCHEDULES

Sheet Number

P4.01

	HVAC ABBREVIA	ATIOI	N LEGEND	PIPE SYMBOL LEGEND
A ACC	AMPS AIR COOLED CONDENSING UNIT	MC MCA	MECHANICAL CONTRACTOR MINIMUM CIRCUIT AMPS	← CHWS ← CHILLED WATER SUPPLY PIPE
ACR	ACR COPPER REFRIG PIPE	MD	MANUAL DAMPER	CHWR→ CHILLED WATER RETURN PIPE
AFF ALUM	ABOVE FINISHED FLOOR ALUMINUM	MFF MI	MATT FACED FIBERGLASS MALLEABLE IRON	CWS—CONDENSER WATER SUPPLY PIPE
APD	AIR PRESSURE DROP	MUA	MAKE UP AIR	CWR→ CONDENSER WATER RETURN PIPE TEE UP
ASJ B	ALL SERVICE INSULATION JACKET STEAM BOILER	NC OA	NOISE CRITERIA LEVEL OUTSIDE AIR	→ DCW → DOMESTIC COLD WATER PIPE
BAS	BUILDING AUTOMATION SYSTEM	OBD	OPPOSED BLADE DAMPER	← HHS → HEATING HOT WATER SUPPLY PIPE
BDD BHP	BACKDRAFT DAMPER BRAKE HORSE POWER	O.C.	ON CENTER OUTDOOR UNIT	←GLYS→ ICE WATER SUPPLY PIPE ← BALL VALVE
BOD	BOTTOM OF DUCT BOTTOM OF PIPE	PC PD	PLUMBING CONTRACTOR PRESSURE DROP	←GLYR → ICE WATER RETURN PIPE ← BUTTERFLY VALVE
BOP BR	BRAZED	PGGS	PAINT GRIP GALVANIZED STEEL	→ DTS → DUAL TEMPERATURE SUPPLY PIPE
C-AL CAL	CORRUGATED ALUMINUM CALCIUM SILICATE INSULATION	PP PPM	POLYPROPYLENE PARTS PER MILLION	← DTR → DUAL TEMPERATURE RETURN PIPE
CCP	CALCIUM CARBONATE POWDER	PRESS.	PRESSURE	→ DHW → DOMESTIC HOT WATER PIPE → PRESSURE REGULATING VAVLE
CF CFM	CUBIC FEET CUBIC FEET PER MINUTE	PRV PS	PRESSURE REGULATING VALVE PRESSURE SENSOR	\longleftarrow V VENT PIPE \longleftarrow GLOBE VALVE
СН	CHILLER	PVC	POLY VINYL CHLORIDE	← G → NATURAL GAS PIPE ← GATE VAVLE
CHP	CHILLED WATER PUMP CHILLED WATER	PVCGS RA	PVC COATED GALVANIZED STEEL RETURN AIR	← LPG → LIQUID PROPANE GAS PIPE ★ STRAINER WITH BLOW DOWN VALVE
CHWR	CHILLED WATER RETURN	RC	ROOM CRITERIA LEVEL	→ RL → REFRIGERANT LIQUID PIPE → STRAINER
CHWS	CHILLED WATER SUPPLY CAST IRON	RECT REFRIG.	RECTANGULAR REFRIGERANT	→ RS → REFRIGERANT SUCTION PIPE → BLIND FLANGE → MOTORIZED 2-WAY VALVE
CL CLP	CENTERLINE CENTERLINE OF PIPE	RL RF	REFRIGERANT LIQUID RETURN OR RELIEF FAN	← NIG → NETRIGERANT HOT GAS FIFE ← → WISTOTHIZED Z WITH WILLY
CMC	CEILING MOUNTED CENTRIFUGAL FAN	RMC	ROOF MOUNTED CENTRIFUGAL FAN	├── LPS ── LOW PRESSURE STEAM PIPE
CONC.	CONCRETE CHLORINATED PVC	RMP RTU	ROOF MOUNTED PROPELLER FAN ROOF TOP UNIT	> UDS -> HIGH DRESSLIDE STEAM DIDE
CR	STEAM CONDENSATE RETURN	RV	RELIEF VALVE	PRESSURE RELIEF VALVE CONDENSATE RETURN PIPE
CRP CS	CONDENSATE RETURN PIPE CARBON STEEL	S SA	SWITCH SUPPLY AIR	→ FW FEED WATER PIPE PRESSURE On the state of the stat
СТ	COOLING TOWER	SC	SENSIBLE CAPACITY	GAGE THERMOMETER
CW	COPPER CONDENSER WATER	SCH SCR	SCHEDULE SCREWED (THREADED)	
CWP	CONDENSER WATER PUMP	SF	SUPPLY FAN	DUCTWORK SYMBOL LEGEND
D DB	DRAIN DECIBELS	SO SQ	SHUT OFF VALVE TERMINAL SQUARE	SUPPLY OR OUTSIDE AIR DUCT UP RADIUS RECTANGULAR ELBOW
DCW DDC	DOMESTIC COLD WATER DIRECT DIGITAL CONTROLS	SS SW	STAINLESS STEEL SWEAT CONNECTION	
DHW	DOMESTIC HOT WATER	SWLD	SOLVENT WELD	RETURN OR EXHAUST AIR DUCT UP SUPPLY OR OUTSIDE AIR ROUND DUCT UP
DMPR DS	DAMPER DUCT SILENCER (SOUND ATTENUATOR)	T TC	THERMOSTAT TOTAL CAPACITY	
DT	DUAL TEMPERATURE	TEMP.	TEMPERATURE	SUPPLY OR OUTSIDE AIR DUCT DOWN RETURN OR EXHAUST AIR ROUND DUCT UP
DTP DTR	DUAL TEMPERATURE PUMP DUAL TEMPERATURE RETURN	TH THRD	THICKNESS THREADED	
DTS	DUAL TEMPERATURE SUPPLY	TOD	TOP OF DUCT	RETURN OR EXHAUST AIR DUCT DOWN ROUND DUCT DOWN
E-AL EAT	EMBOSSED ALUMINUM ENTERING AIR TEMPERATURE	TOJ TOS	TOP OF JOIST TOP OF STEEL	
EC	ELECTRICAL CONTRACTOR ENTERING DRY BULB TEMPERATURE	TS T/S	TEMPERATURE SENSOR PIPE TYPE OR SCHEDULE	SUPPLY OR OUTSIDE AIR DUCT OFFSET ROUND OFFSET
EDB EF	EXHAUST FAN	UBC	UPBLAST CENTRIFUGAL FAN	RETURN AIR DUCT OFFSET ROUND ELBOW
EH EWB	ELECTRIC HEATER ENTERING WET BULB TEMPERATURE	UC	FLEXIBLE UNICELLULAR UNIT HEATER	RETURN AIR DUCT OFFSET
EWT	ENTERING WATER TEMPERATURE	UV	UNIT VENTILATOR	MANUAL BALANCING DAMPER ROUND WYE
EXH F	EXHAUST FURNACE	V VAV	VOLTS VARIABLE AIR FLOW	
FCU	FANCOIL UNIT	VC	VENTILATING CONTRACTOR	MOTORIZED DAMPER RECTANGULAR BRANCH TAKEOFF
FD FFJ	FIRE DAMPER FOIL FACED JACKET	WCS WCU	WROUGHT CARBON STEEL WROUGHT COPPER	
FG FGB	FIBERGLASS FIBERGLASS BOARD INSULATION	WLD WMP	WELDED CONNECTION WALL MOUNTED PROPELLER FAN	FIREDAMPER RECTANGULAR DUCT TERMINATION
FGW	FIBERGLASS WRAP	WPD	WATER PRESSURE DROP	
FLA FLG	FULL LOAD AMPS FLANGE	WT	WEIGHT (OR DENSITY)	RECTANGULAR TO ROUND TRANSITION ROUND DUCT TERMINATION
FLGD	FLANGED			
FMG FPM	FOAM GLASS FEET PER MINUTE			RECTANGULAR TRANSITION
FPP	FAN POWERED PARALLEL VAV			STANDARD RECTANGULAR ELBOW
FPS FS	FAN POWERED SERIES VAV FLOW SWITCH			STANDARD RECTANGULAR ELBOW
FW	FEED WATER			ANNOTATION SYMBOL LEGEND
G GA	NATURAL GAS GAGE (GAUGE)			ANNOTATION OTNIBOL LEGEND
GALV GC	GALVANIZED GENERAL CONTRACTOR			THERMOSTAT OR TEMP. SENSOR
GPH	GALLONS PER HOUR			H HUMIDISTAT H-100 SECTION SYMBOL
GPM GRV	GALLONS PER MINUTE GROOVED PIPE			S SWITCH √10 KEYED NOTE SYMBOL RTII
GS	GALVANIZED STEEL			CONNECT TO EXISTING RTU 12 EQUIPMENT PLAN MARK
H HC	HUMIDIFIER (HUMIDITY) HEATING CONTRACTOR			1-01 VAV TERMINAL UNIT MARK
HF	HEAT FUSION			AHIL-1 FOLUPMENT MARK 4 DETAIL SYMBOL
HG HP	HOT GAS (REFRIGERANT) HORSE POWER			A-8"ø A-24x12 AIR DEVICE MARK - NECK SIZE H-100 H-100
HPS HRC	HIGH PRESSURE STEAM HEAT RECLAIM WATER			250 250 AIRFLOW 8"ø ROUND DUCT SIZE
HS	HUMIDITY SENSOR			24x12 RECTANGULAR DUCT SIZE
HV HW	HEATING/VENTILATING UNIT HEATING HOT WATER			24/12 OV OVAL DUCT SIZE
HWB	HOT WATER BOILER			AIR DEVICE AND DUCT ACCESS. LEGEND
HWP HWR	HOT WATER PUMP HOT WATER RETURN			,
HWS	HOT WATER SUPPLY			RETURN AIR GRILLE SUPPLY AIR DIFFUSER (HARD CONNECTION)
ILC LAT	INLINE CENTRIFUGAL FAN LEAVING AIR TEMPERATURE			
LDB LP	LEAVING DRY BULB TEMPERATURE LIQUID PROPANE			SUPPLY AIR DIFFUSER WITH FLEXIBLE RETURN OR EXH. GRILLE (HARD CONNECTION)
LPS	LOW PRESSURE STEAM			
LVR LWB	LOUVER LEAVING WET BULB TEMPERATURE			SIDEWALL DIFFUSER ————————————————————————————————————
LWT	LEAVING WATER TEMPERATURE			SUPPLY AIR DIFFUSER (HARD TRANSFER ORENING IN WALL
M MAT.	MOTORIZED MATERIAL			CONNECTION) TRANSFER OPENING IN WALL
MBH	1000 BTUH			RETURN OR EXH. GRILLE (HARD CONNECTION)
				CONNECTION)

GENERAL NOTES

- A. DO NOT SCALE DRAWINGS. IF DIMENSIONS CANNOT BE DETERMINED OR DOCUMENTS ARE IN CONFLICT (WITH THEMSELVES OR FIELD CONDITIONS), THE CONTRACTOR MUST OBTAIN CLARIFICATION FROM THE ARCHITECT PRIOR TO CONTINUATION OF WORK.
- B. CONTRACTOR(S) SHALL VISIT THE SITE TO ACQUAINT THEMSELVES WITH THE EXISTING OR NEWLY INSTALLED CONDITIONS. CONTRACTOR(S) SHALL FIELD VERIFY ALL DIMENSIONS, ELEVATIONS, UTILITIES, AND EXISTING OR NEWLY INSTALLED CONDITIONS PRIOR TO CONSTRUCTION.
- C. THE CONSTRUCTION DOCUMENTS AND DRAWING NOTES / SPECIFICATIONS ARE INTENDED TO DESCRIBE AND PROVIDE FOR A FINISHED PIECE OF WORK. THE WORK SHALL BE COMPLETED IN EVERY DETAIL EVEN THOUGH EVERY ITEM NECESSARILY INVOLVED IS NOT PARTICULARLY MENTIONED OR SPECIFIED. ALL WORK SHALL BE INSTALLED AS SHOWN ON THE DRAWINGS AND / OR MANUFACTURER'S SPECIFICATIONS AND INSTALLATION INSTRUCTIONS. IF ANY CONTRACTOR IS IN DOUBT AS TO THE TRUE MEANING OF ANY PART OF THE DOCUMENTS, OR FINDS DISCREPANCIES IN OR OMISSIONS FROM ANY PART OF THE DOCUMENTS, HE MUST CONTACT THE ARCHITECT FOR CLARIFICATION.
- ALL DIMENSIONS ARE TO FACE OF STUD, CONCRETE, MASONRY, OR CENTERLINE OF COLUMN, UNLESS NOTED OTHERWISE. WHEN EXISTING CONDITIONS ARE SHOWN, DIMENSIONS ARE TO FACE OF EXISTING FINISH, UNLESS NOTED OTHERWISE
- FINISH FLOOR ELEVATIONS ARE FOR GENERAL REFERENCE. REFER TO CIVIL SHEETS FOR ACTUAL FINISH FLOOR ELEVATIONS.
- F. EQUIPMENT AND FURNITURE SHOWN IS FOR REFERENCE ONLY, EQUIPMENT AND FURNITURE PROVIDED BY OWNER (UNLESS NOTED OTHERWISE). COORDINATE EQUIPMENT AND FURNITURE INSTALLATION AND UTILITY CONNECTIONS WITH OWNER AND OWNER'S SUPPLIER.
- G. DEFINITIONS:
 NECESSARY: WORK NEEDED TO COMPLETE THE WORK TO "MAKE IT OPERATIONAL".

REQUIRED: WORK NEEDED TO BE IN COMPLIANCE WITH BUILDING CODE, GOVERNING CODE, OR JURISDICTION HAVING AUTHORITY.

PROVIDE: RESPONSIBLE FOR PURCHASE, DELIVERY, RECEIVING, INSPECTION, STORAGE, PREPARATION, AND INSTALLATION OF ITEM(S).

FURNION DECRONORIE FOR RUPOLIAGE AND RELIVERY OF ITEMAN

FURNISH: RESPONSIBLE FOR PURCHASE AND DELIVERY OF ITEM(S).

INSTALL: RESPONSIBLE FOR RECEIVING, INSPECTION, STORAGE, PREPARATION, AND INSTALLATION OF ITEM(S).

BASIS OF DESIGN: AN ACCEPTABLE MANUFACTURER OR PRODUCT, DESIGNATED BY THE DESIGN PROFESSIONAL, WHICH EXHIBITS THE INTENDED STANDARDS AND DESIGN CRITERIA THAT MUST BE MET FOR PERFORMANCE. THE ITEM(S) INDICATED MAY BE PROVIDED OR AN ITEM OF EQUIVALENT APPEARANCE, AESTHETIC, QUALITY, MATERIAL, CONSTRUCTION, AND PERFORMANCE MAY BE SUBSTITUTED SUBJECT TO THE ARCHITECT'S OR DESIGN PROFESSIONAL'S APPROVAL. (REFER TO THE "SUBSTITUTIONS" SPECIFICATION FOR ADDITIONAL INFORMATION)

OR EQUAL: MAY FOLLOW A "BASIS OF DESIGN" OR OTHER SPECIFIED MANUFACTURER OR PRODUCT AND INDICATES THAT AN ITEM OF EQUIVALENT APPEARANCE, AESTHETIC, QUALITY, MATERIAL, CONSTRUCTION, AND PERFORMANCE MAY BE SUBSTITUTED SUBJECT TO THE ARCHITECT'S OR DESIGN PROFESSIONAL'S APPROVAL. (REFER TO THE "SUBSTITUTIONS" SPECIFICATION FOR ADDITIONAL INFORMATION)

HVAC INDEX OF DRAWINGS

H1.01 HVAC OVERALL FIRST FLOOR PLAN DEMOLITION PART '1'

H1.03 HVAC ENLARGED LIBRARY PLAN - DEMOLITION
H1.04 HVAC ENLARGED OFFICE AREA - DEMOLITION

H2.03 HVAC ENLARGED LIBRARY PLAN - NEW WORK
H2.04 HVAC ENLARGED OFFICE AREA - NEW WORK

H1.02 HVAC OVERALL FIRST FLOOR PLAN DEMOLITION PART '4'

HVAC OVERALL FIRST FLOOR PLAN NEW WORK PART '1'

H2.02 HVAC OVERALL SECOND FLOOR PLAN NEW WORK PART '6'

H2.05 ENLARGED CLASSROOMS 210, 225, 234 & 236 - NEW WORK
H2.06 ENLARGED CLASSROOMS 208, 227 & 229 - NEW WORK

H0.01 HVAC LEGEND AND GENERAL NOTES

H3.01 HVAC SCHEDULES & DETAILS

SHEET NAME

SHEET

NUMBER



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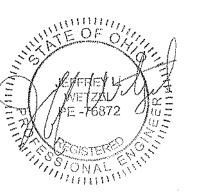
HVAC LEGEND AND GENERAL NOTES

Sheet Number

HO.01

GENERAL NOTES





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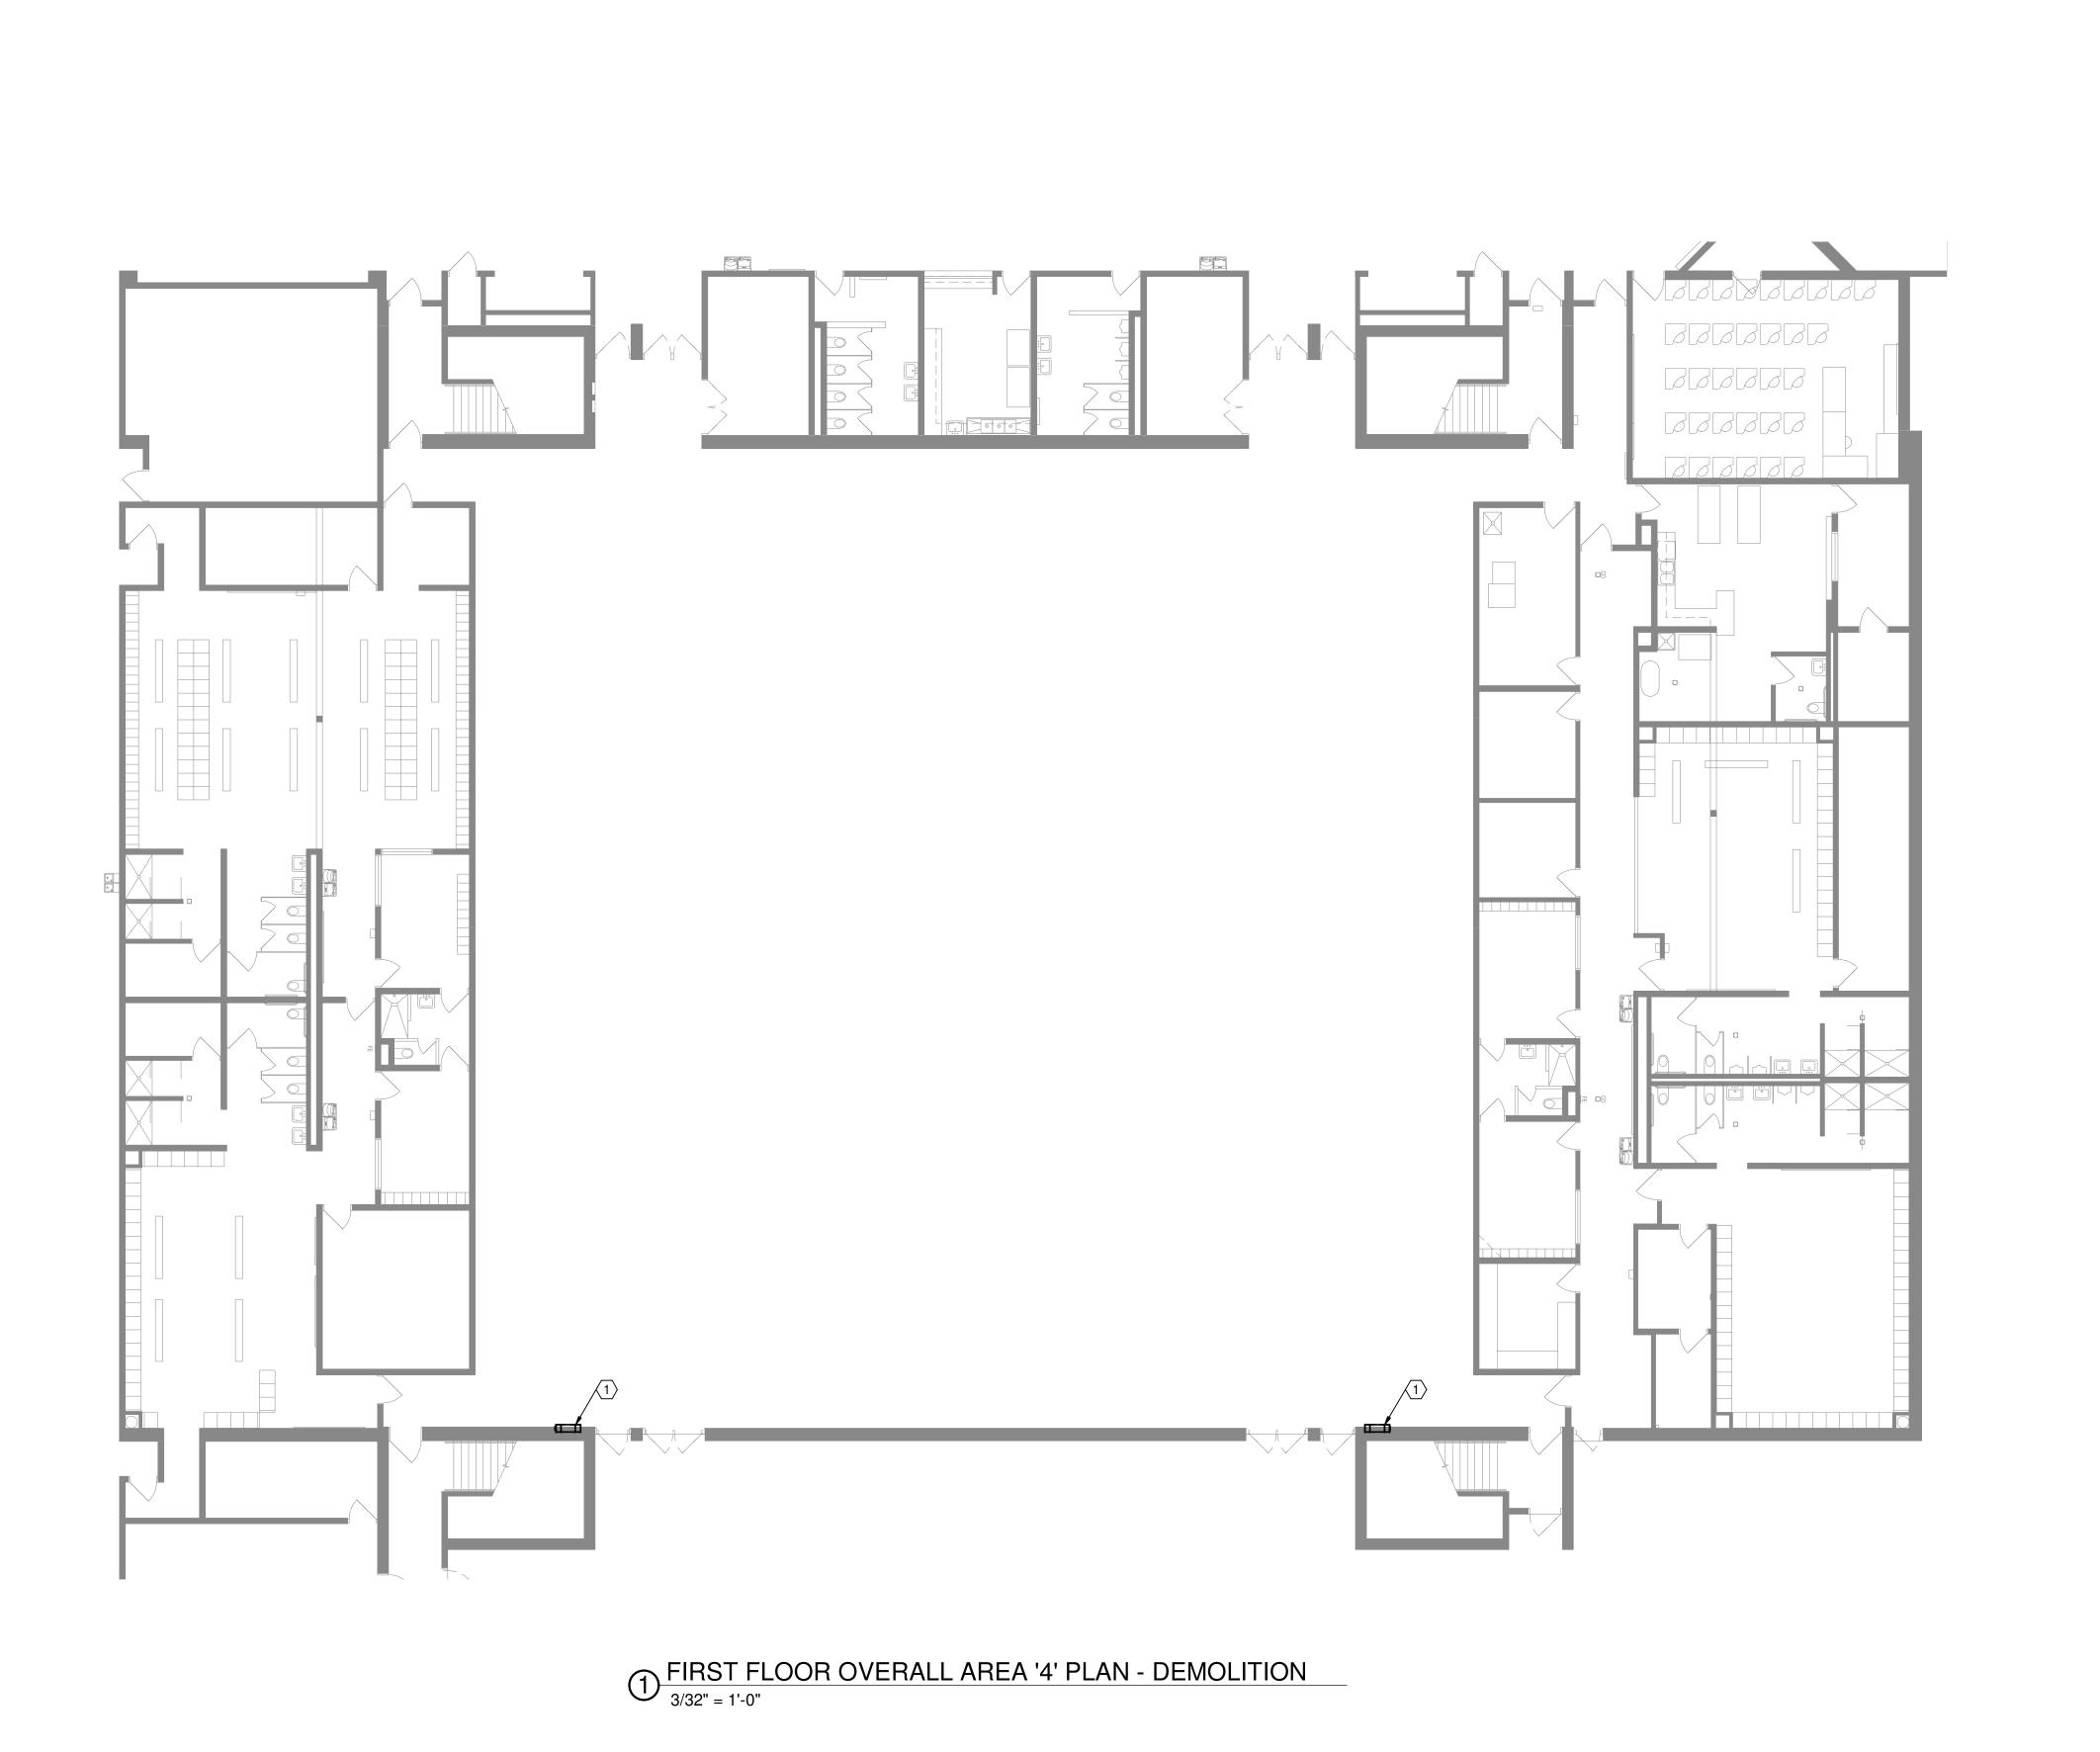
Sheet Title HVAC OVERALL FIRST FLOOR PLAN DEMOLITION PART 'I'

Sheet Number

KEY PLAN


NTS

H1.01



O DRAWING NOTES

EXISTING HOT WATER CABINET HEATER AND ASSOCIATED CONTROL WIRING, THERMOSTAT, POWER WIRING, PIPING, ETC. TO BE REMOVED. EXISTING OPENING SHALL BE PATCHED AND PAINTED CONSISTENT WITH EXISTING CONSTRUCTION. EXISTING HOT WATER PIPING SHALL BE CAPPED WITHIN THE WALL CAVITY

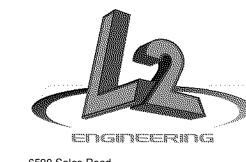

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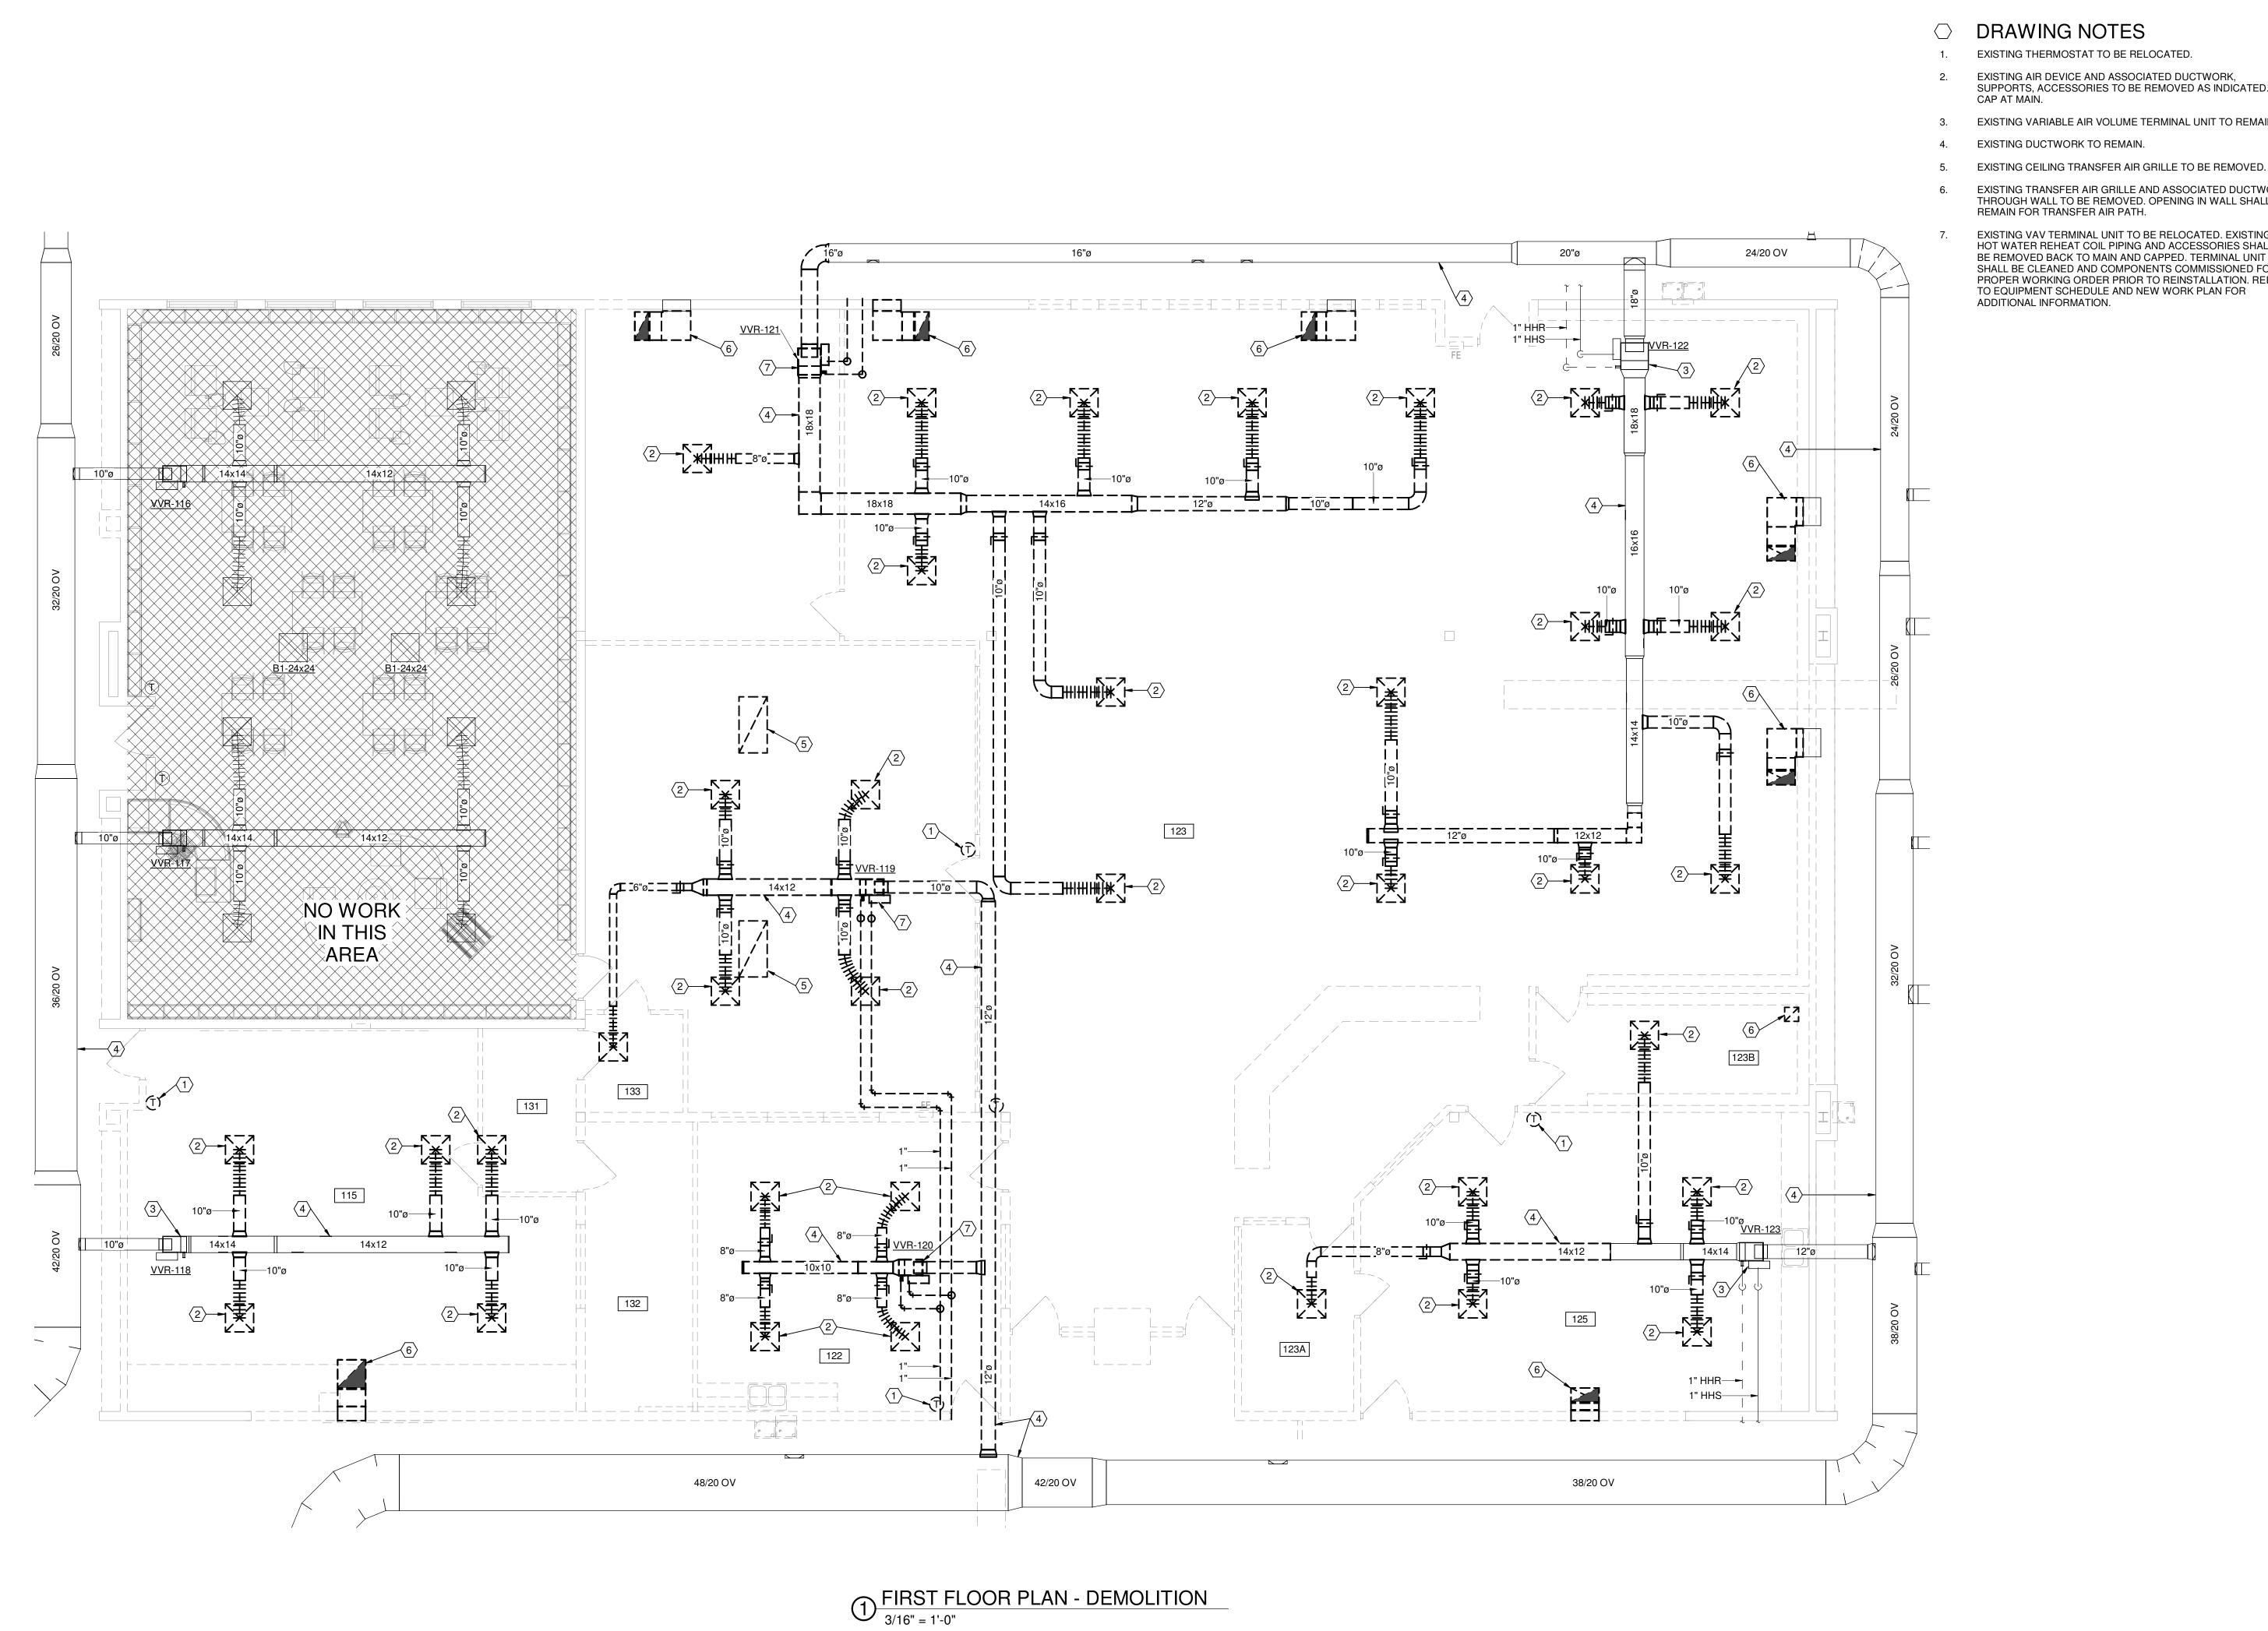
HVAC OVERALL FIRST FLOOR PLAN DEMOLITION PART '4'

Sheet Number

KEY PLAN

NTS

H1.02



- EXISTING THERMOSTAT TO BE RELOCATED.
- EXISTING AIR DEVICE AND ASSOCIATED DUCTWORK, SUPPORTS, ACCESSORIES TO BE REMOVED AS INDICATED.
- EXISTING VARIABLE AIR VOLUME TERMINAL UNIT TO REMAIN.
- EXISTING DUCTWORK TO REMAIN.
- EXISTING TRANSFER AIR GRILLE AND ASSOCIATED DUCTWORK THROUGH WALL TO BE REMOVED. OPENING IN WALL SHALL REMAIN FOR TRANSFER AIR PATH.
- EXISTING VAV TERMINAL UNIT TO BE RELOCATED. EXISTING HOT WATER REHEAT COIL PIPING AND ACCESSORIES SHALL BE REMOVED BACK TO MAIN AND CAPPED. TERMINAL UNIT SHALL BE CLEANED AND COMPONENTS COMMISSIONED FOR PROPER WORKING ORDER PRIOR TO REINSTALLATION. REFER TO EQUIPMENT SCHEDULE AND NEW WORK PLAN FOR ADDITIONAL INFORMATION.



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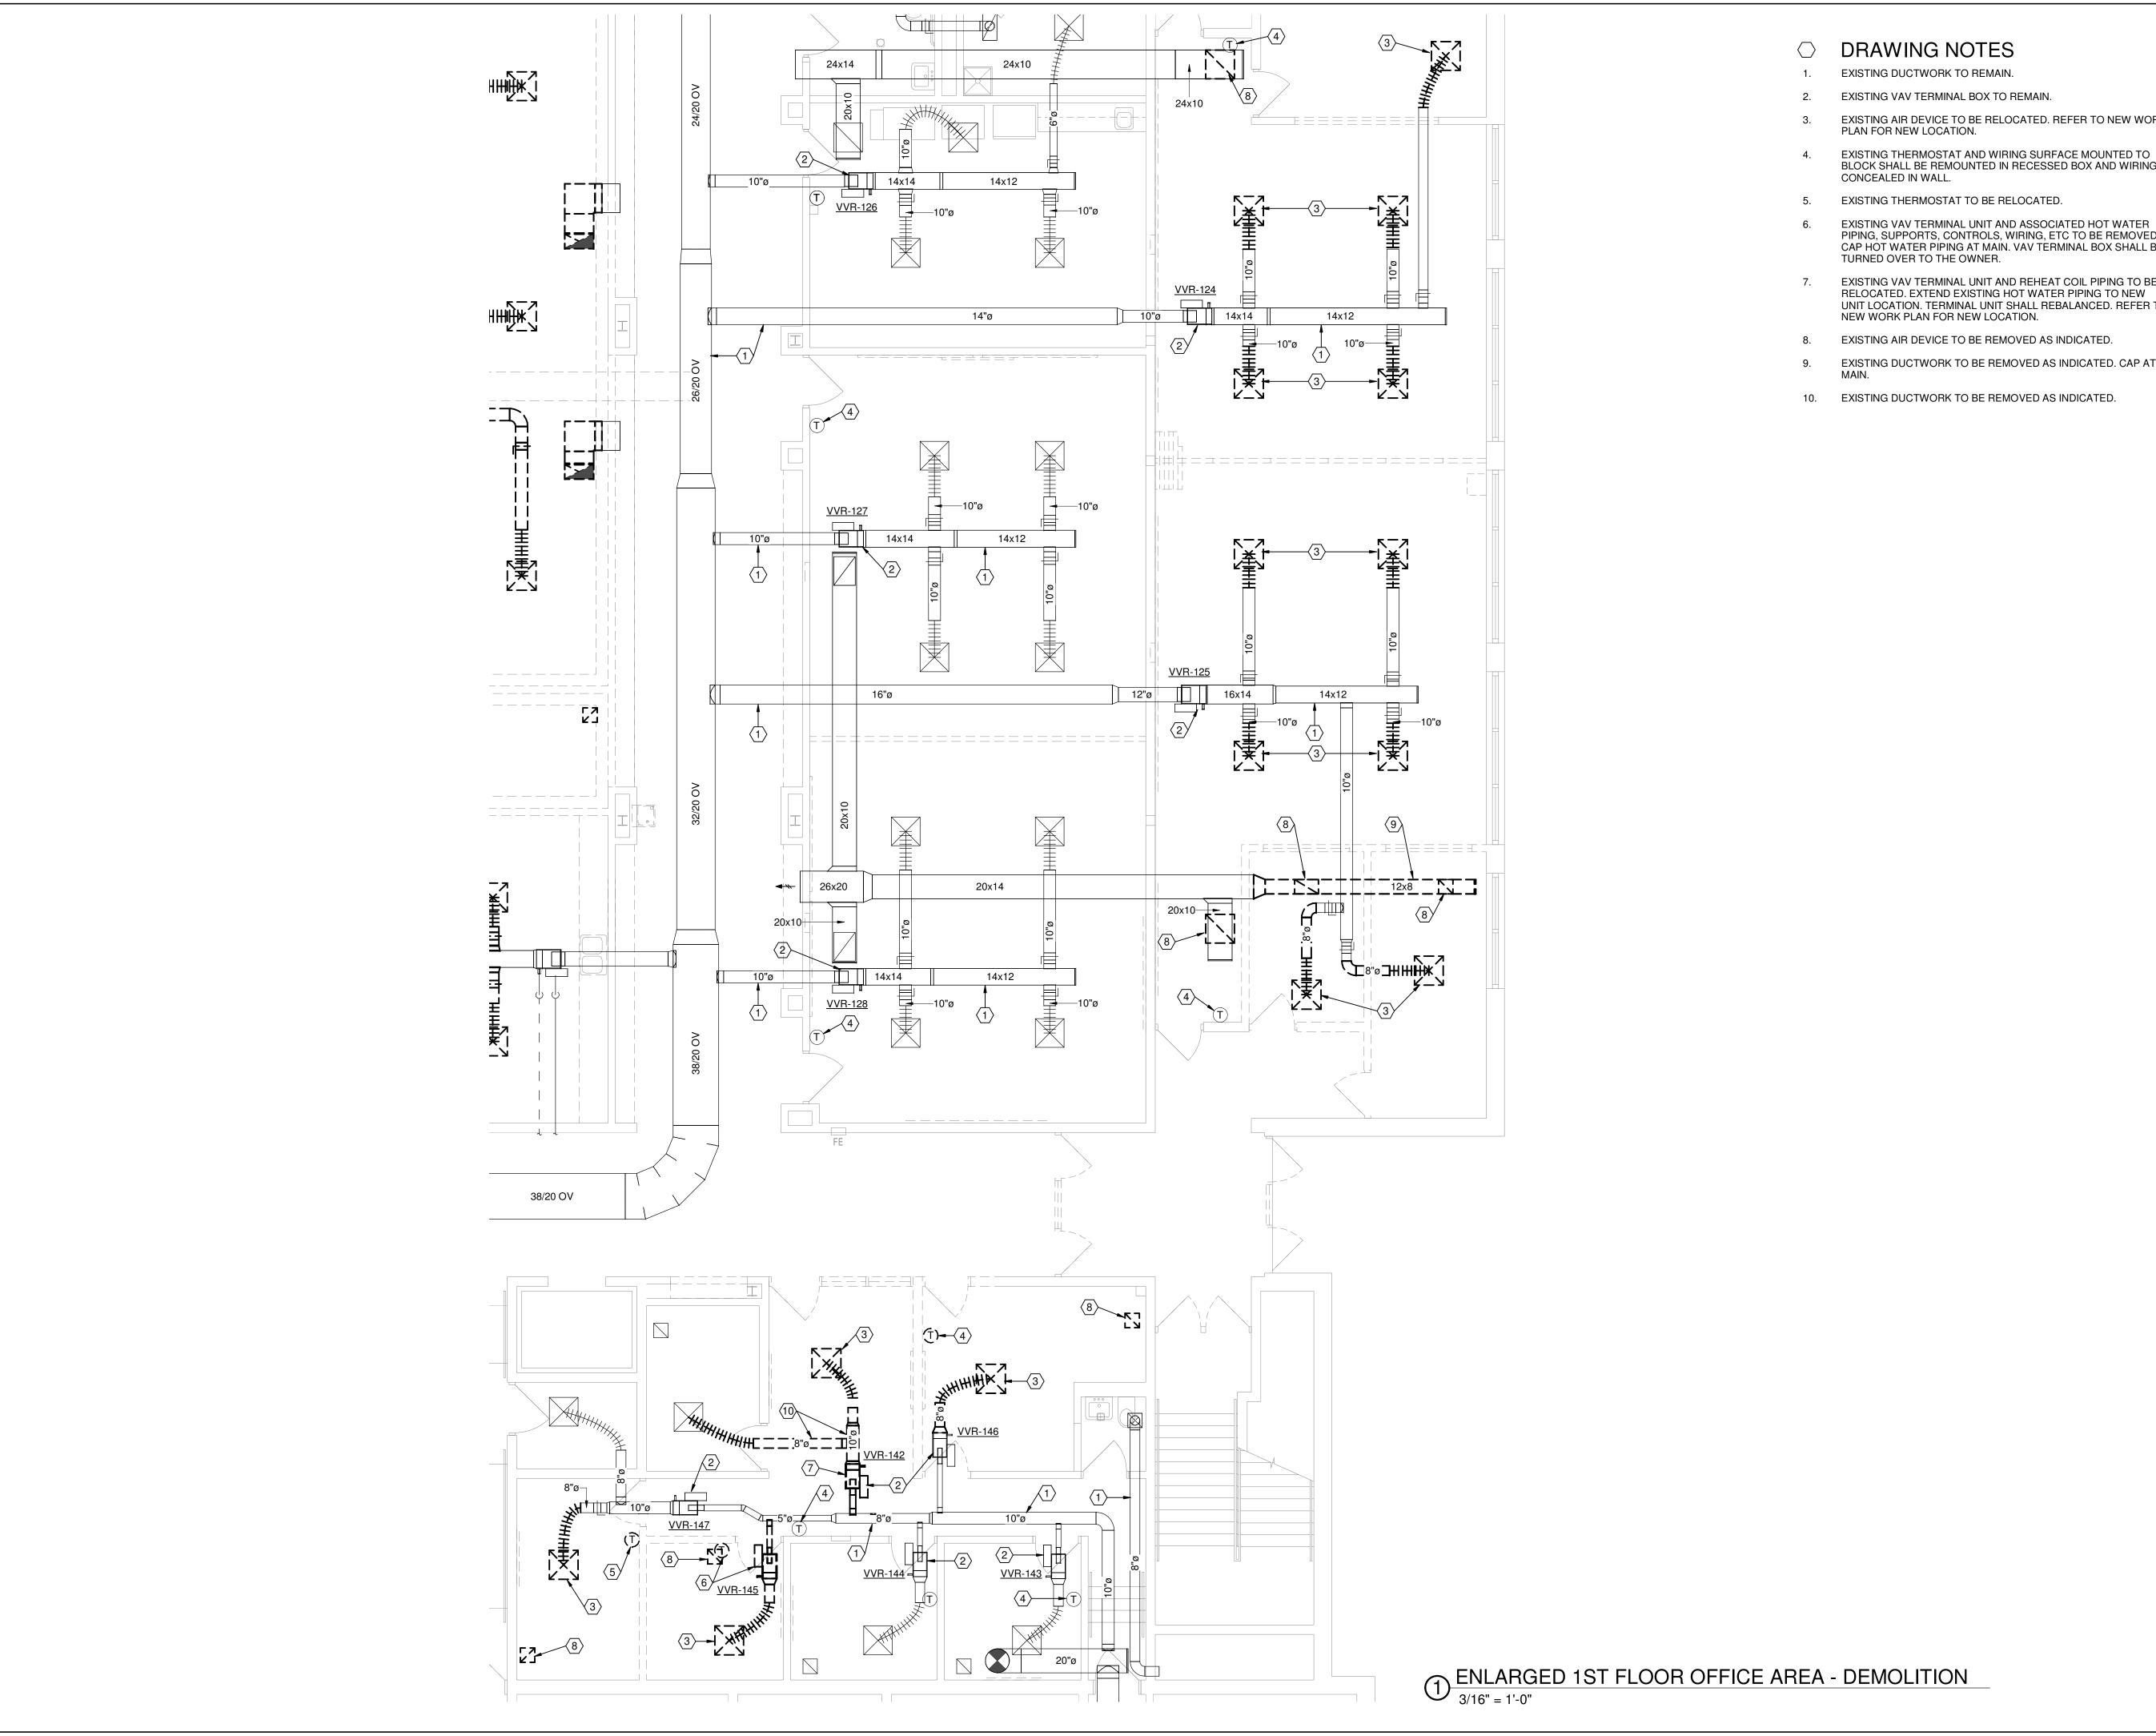
JANUARY 24, 2022

Sheet Title

HVAC ENLARGED LIBRARY PLAN - DEMOLITION

Sheet Number

H1.03



- EXISTING AIR DEVICE TO BE RELOCATED. REFER TO NEW WORK
- BLOCK SHALL BE REMOUNTED IN RECESSED BOX AND WIRING
- EXISTING VAV TERMINAL UNIT AND ASSOCIATED HOT WATER PIPING, SUPPORTS, CONTROLS, WIRING, ETC TO BE REMOVED. CAP HOT WATER PIPING AT MAIN. VAV TERMINAL BOX SHALL BE
- EXISTING VAV TERMINAL UNIT AND REHEAT COIL PIPING TO BE RELOCATED. EXTEND EXISTING HOT WATER PIPING TO NEW UNIT LOCATION. TERMINAL UNIT SHALL REBALANCED. REFER TO
- EXISTING DUCTWORK TO BE REMOVED AS INDICATED. CAP AT





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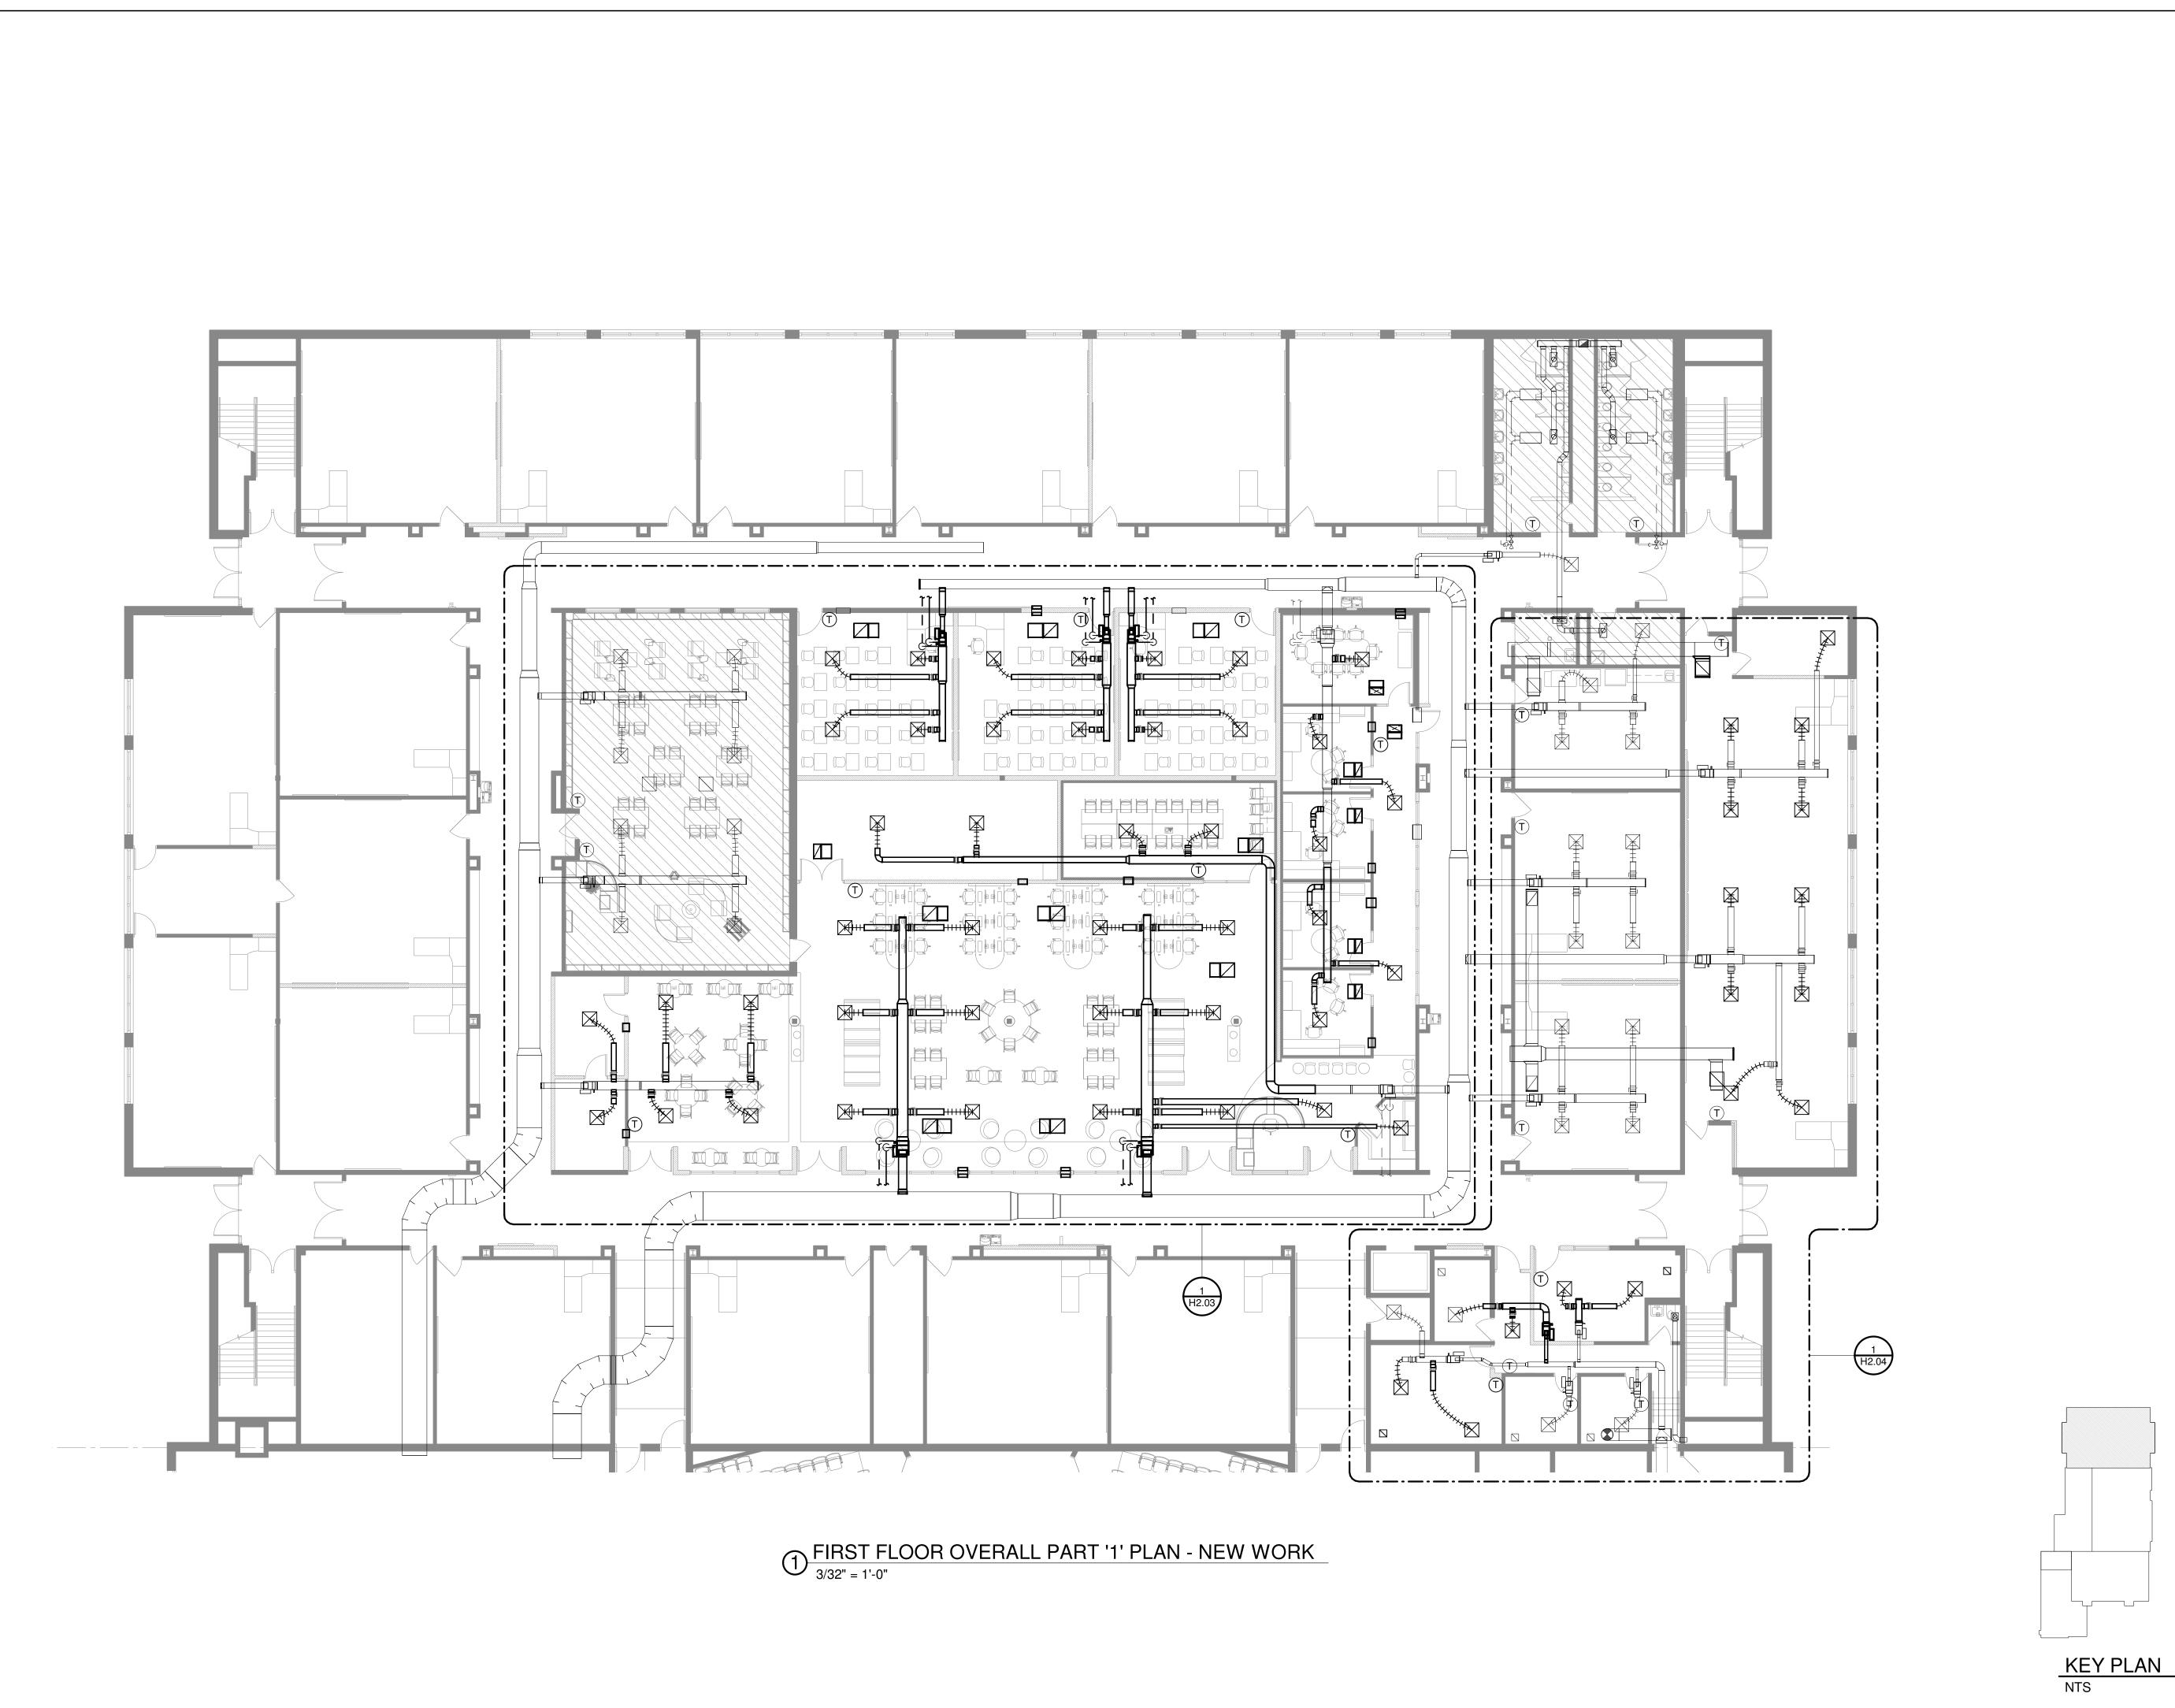
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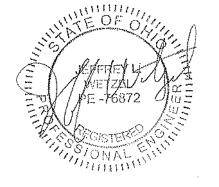
Sheet Title

HVAC ENLARGED OFFICE AREA - DEMOLITION

Sheet Number







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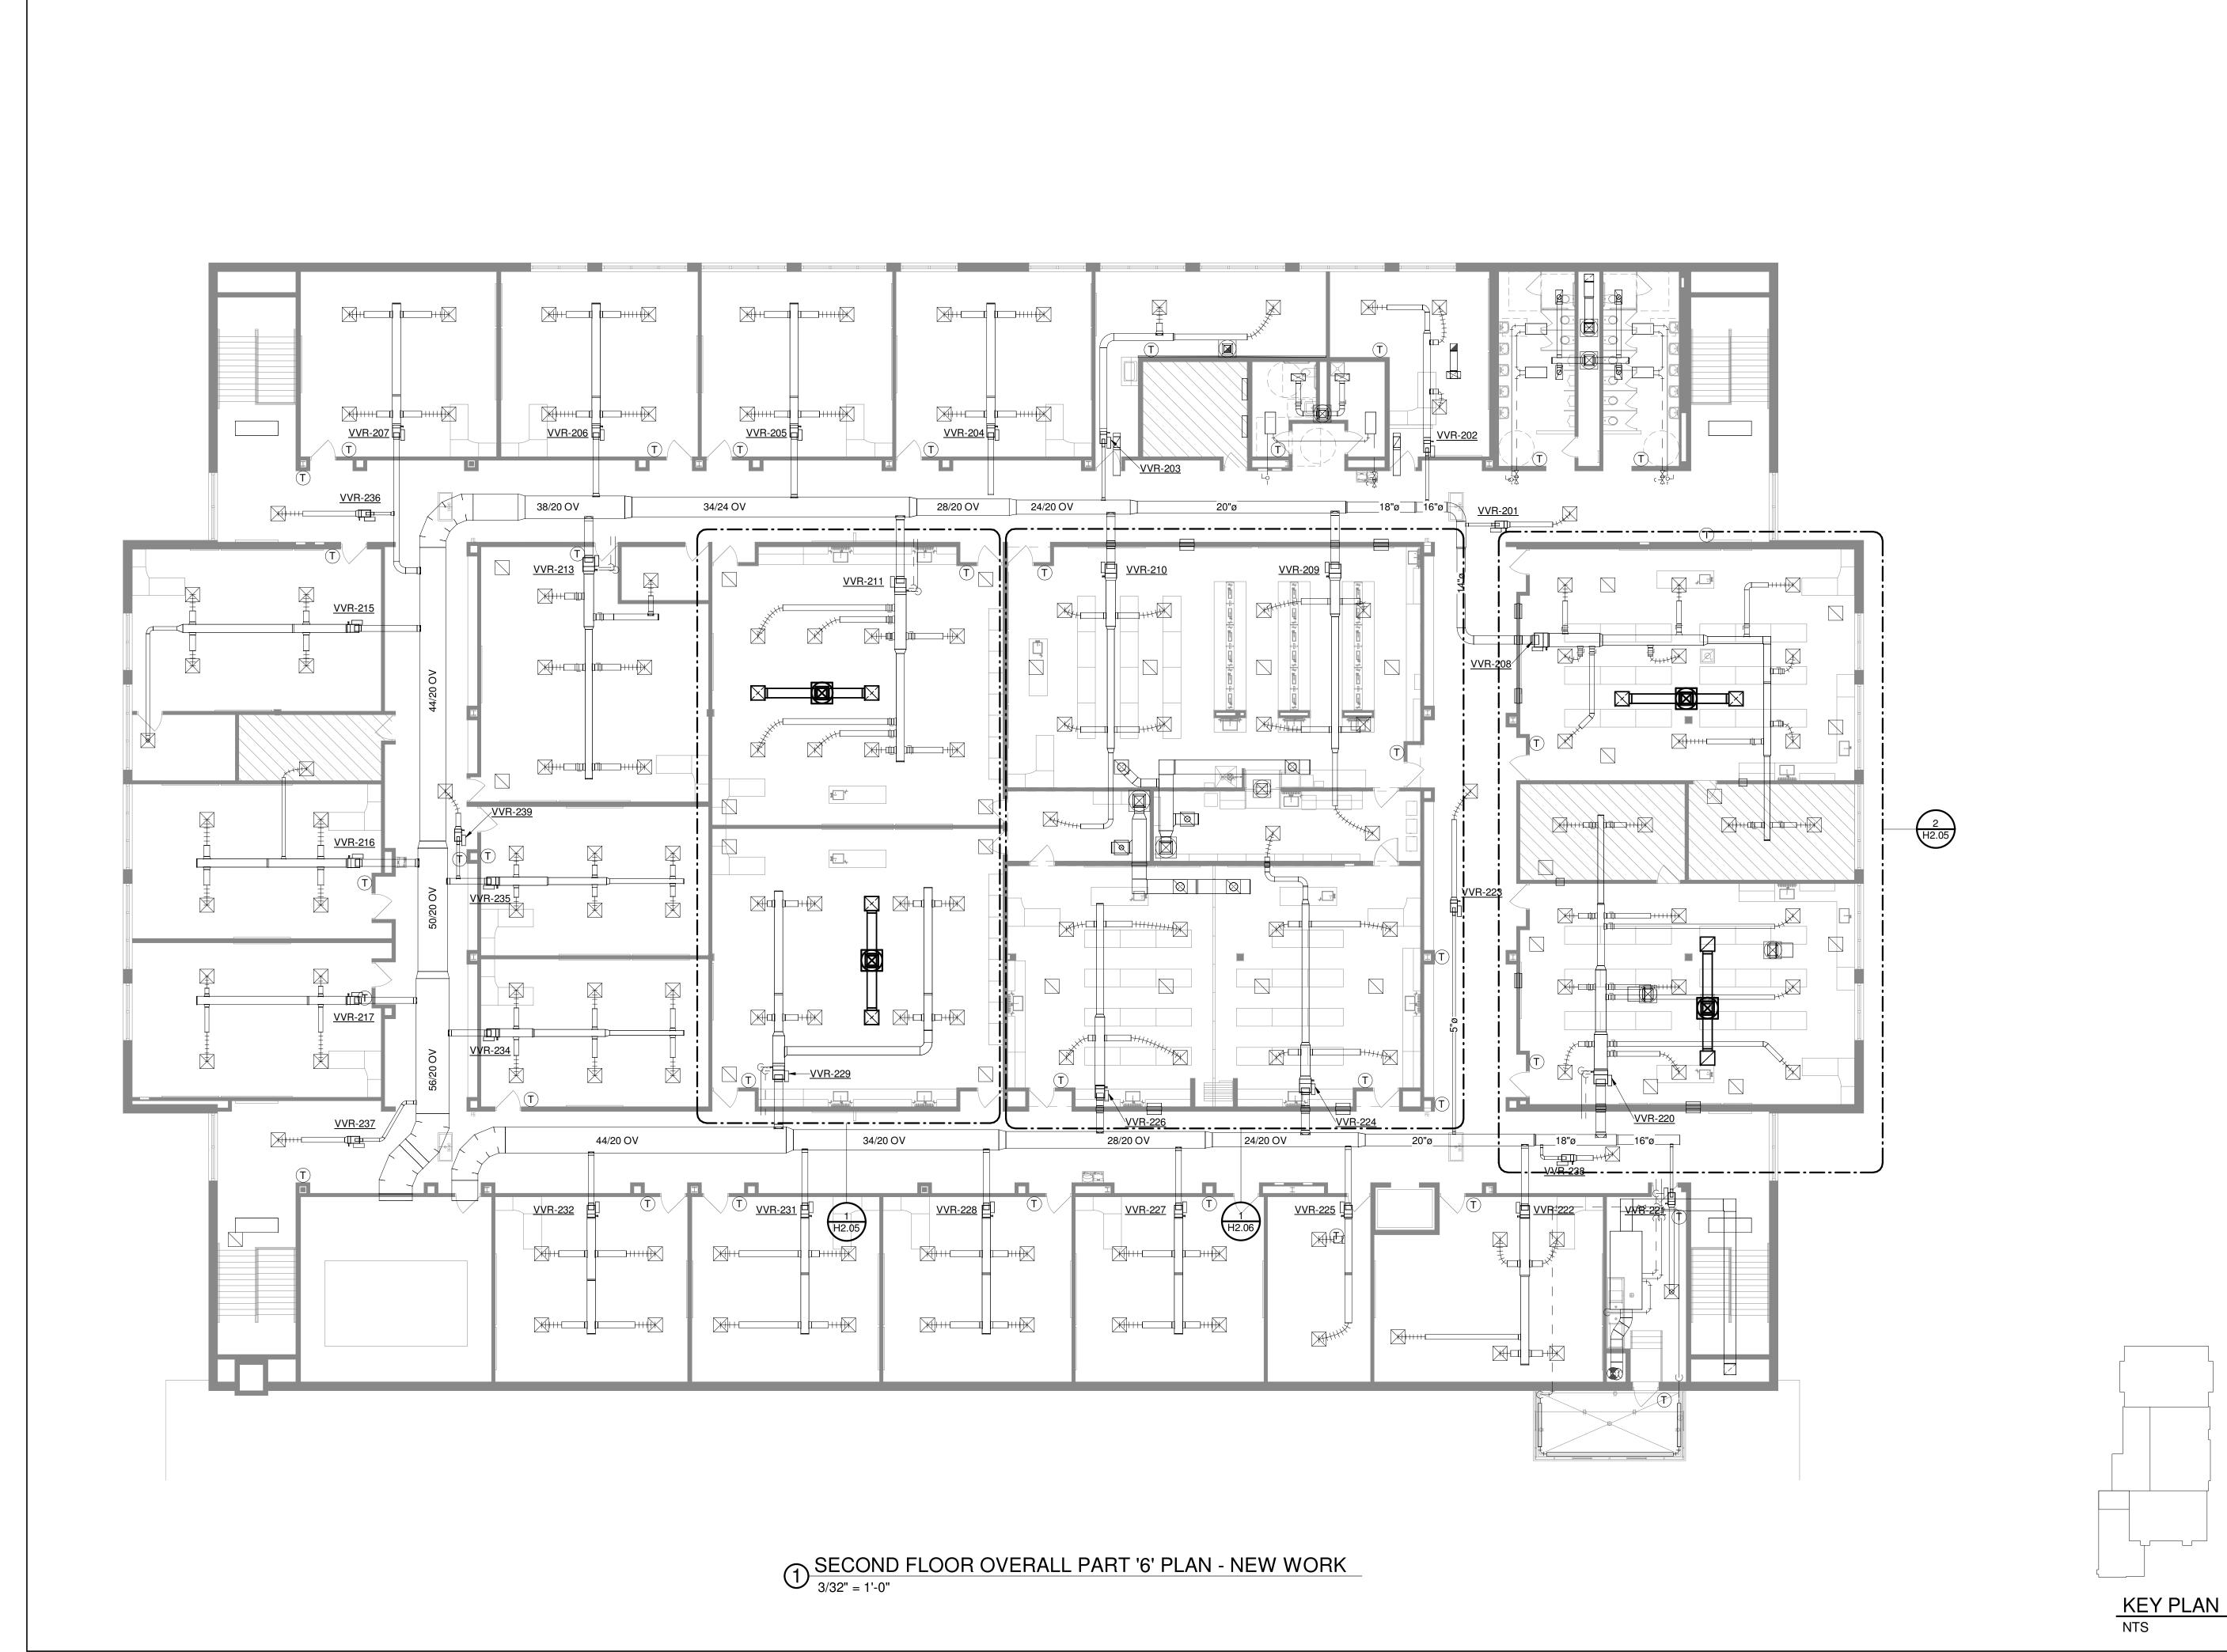
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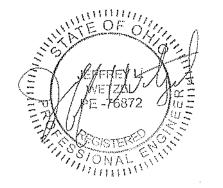
Sheet Title HVAC OVERALL FIRST

FLOOR PLAN NEW WORK PART 'I'

Sheet Number







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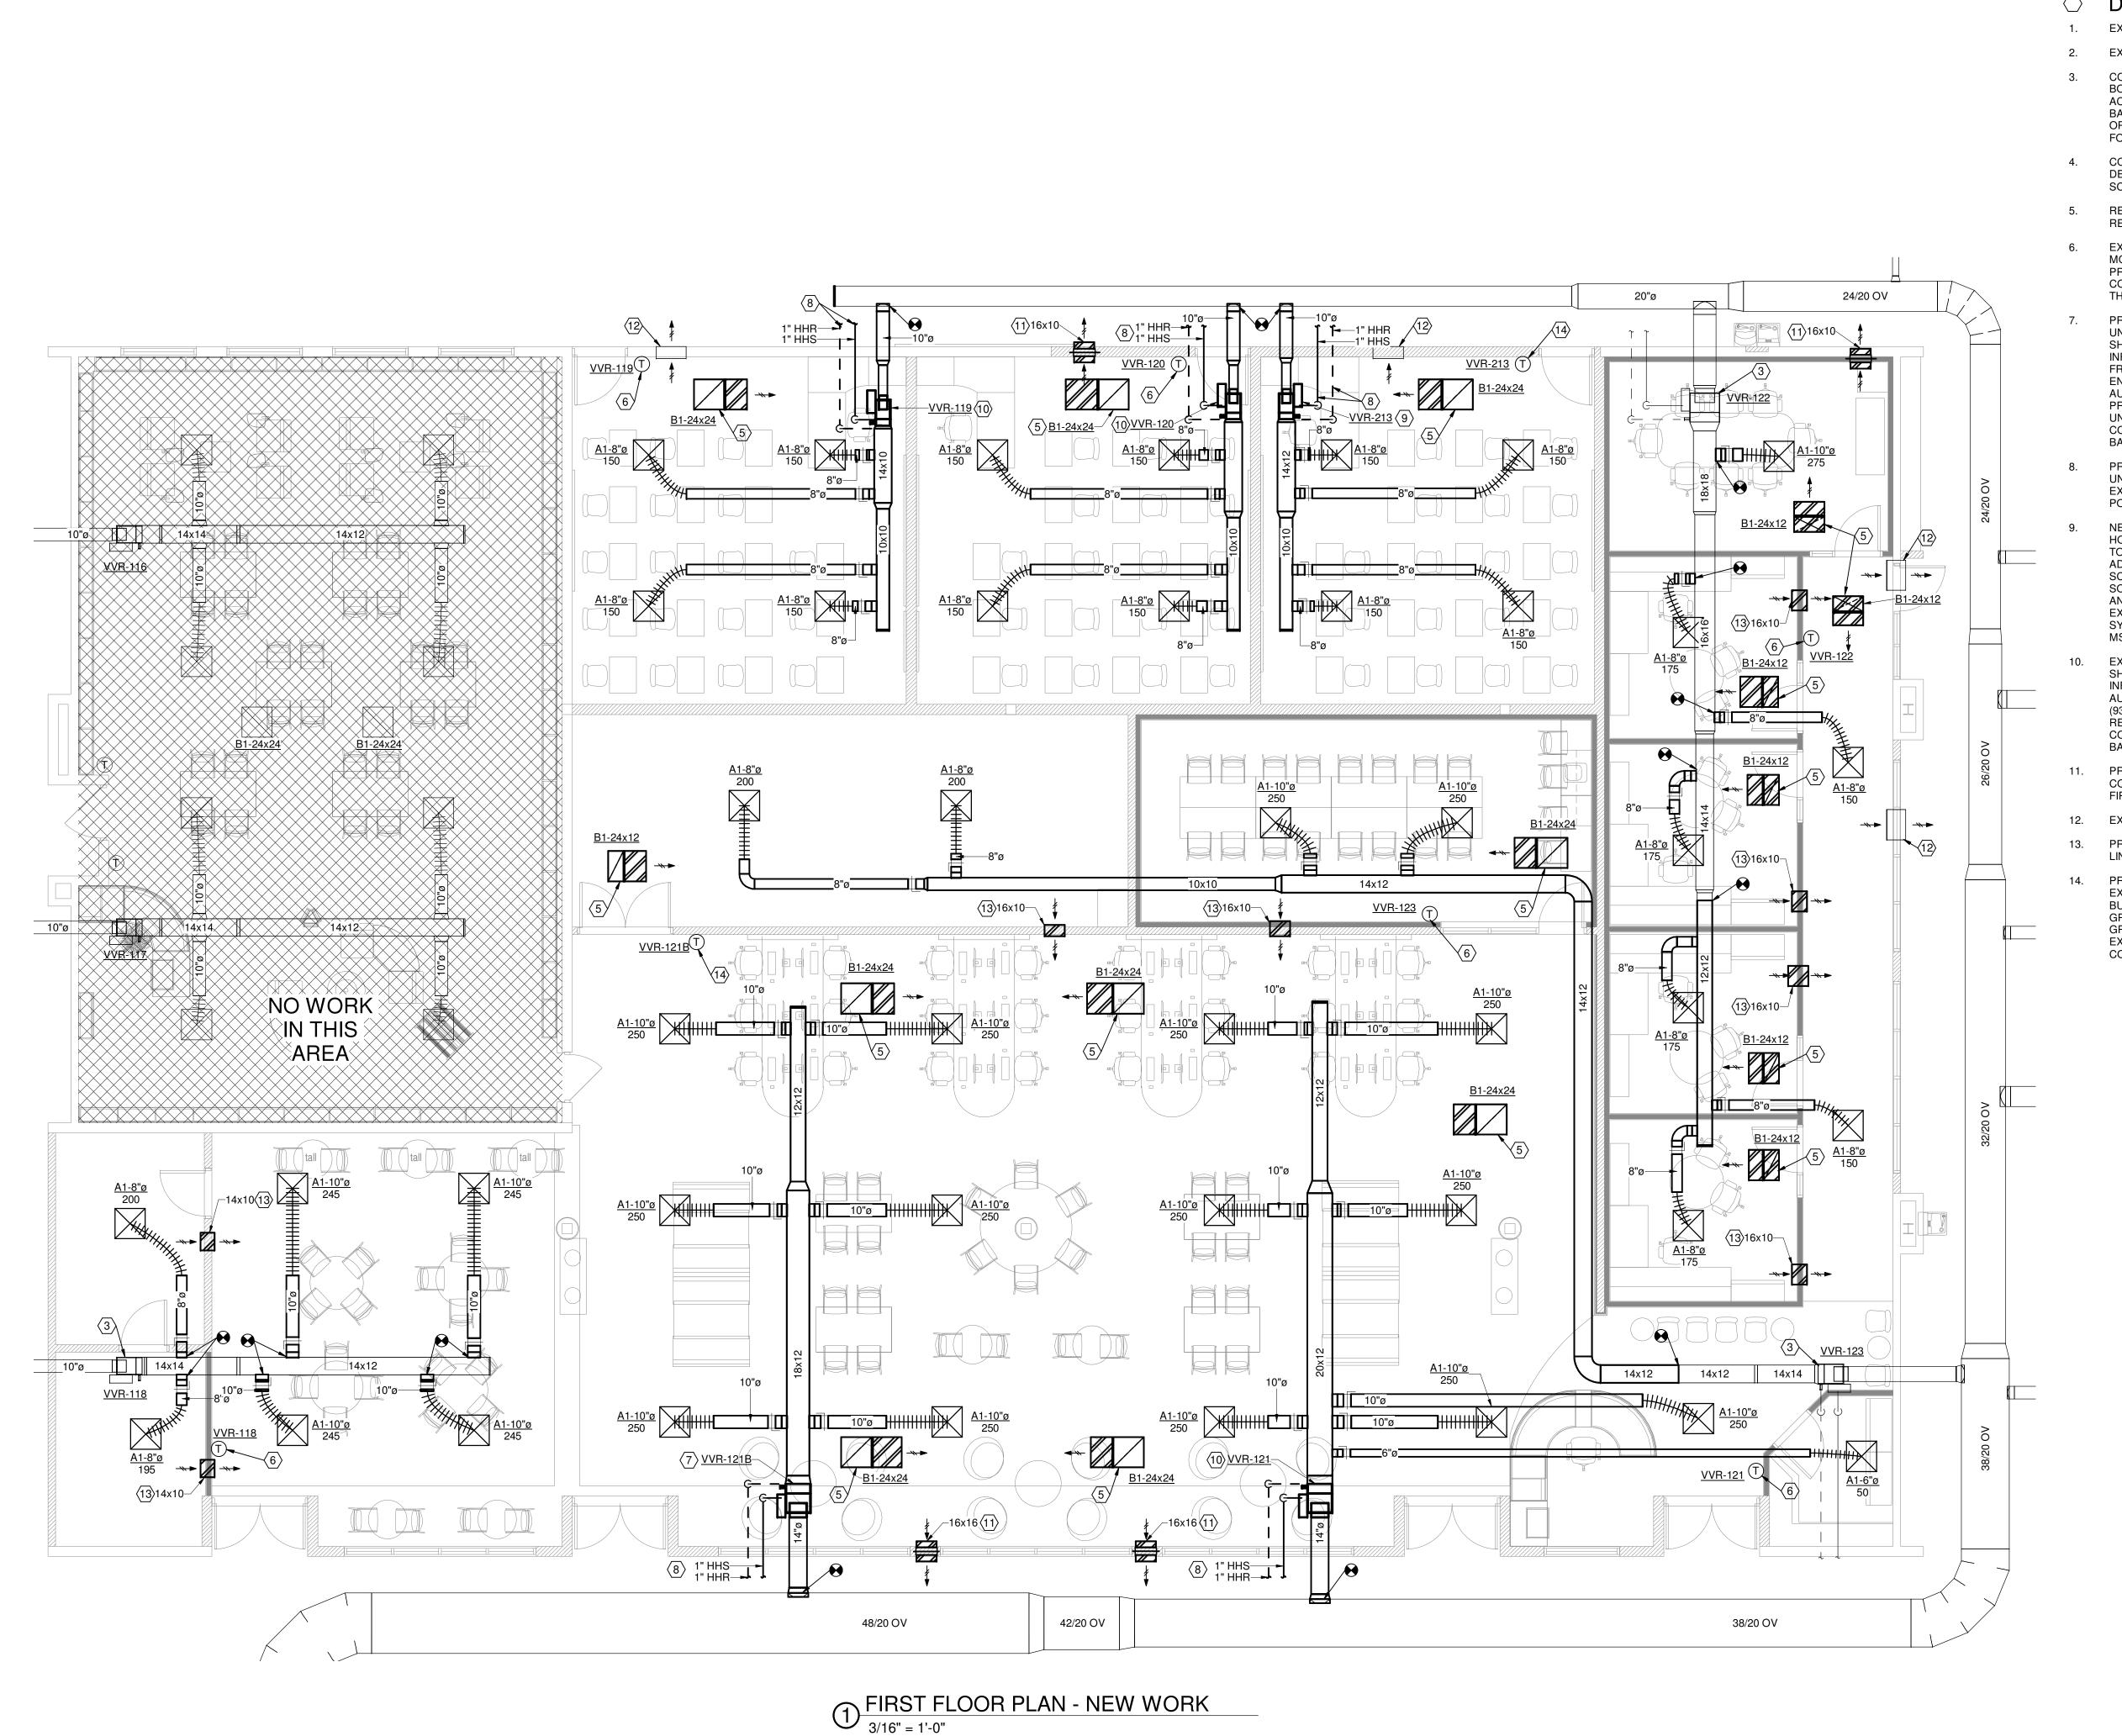
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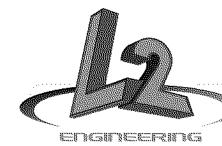
Sheet Title

HVAC OVERALL SECOND FLOOR PLAN NEW WORK PART '6'


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- EXISTING DUCTWORK TO REMAIN.
- EXISTING VAV TERMINAL UNIT TO REMAIN.
- CONTRACTOR SHALL COMMISSION EXISTING TERMINAL UNIT BOX AND ITS ASSOCIATED REHEAT COIL PIPING CONNECTION ACCESSORIES INCLUDING CONTROL VALVE, STRAINER, BALANCE VALVE AND SHUTOFF VALVES FOR PROPER OPERATION. CONTRACTOR SHALL DOCUMENT DEFICIENCIES
- CONTRACTOR SHALL REBALANCE EXISTING TERMINAL UNIT TO DESIGN MAXIMUM AIRFLOW. REFER TO TERMINAL UNIT SCHEDULE FOR PERFORMANCE INFORMATION.
- RETURN AIR TRANSFER GRILLE OPEN TO PLENUM ABOVE. REFER TO DETAIL "4", SHEET H3.01.
- EXISTING RELOCATED THERMOSTAT. THERMOSTAT SHALL BE MOUNTED TO NEW RECESSED BACKBOX AND IN-WALL CONDUIT PROVIDED BY E.C. THIS CONTRACTOR SHALL EXTEND NEW CONTROL WIRING FROM ASSOCIATED TERMINAL UNIT TO THERMOSTAT LOCATION.
- PROVIDE NEW SINGLE DUCT VARIABLE AIR VOLUME TERMINAL UNIT WITH HOT WATER REHEAT COIL. REFER TO DETAIL "4", SHEET H0.2 AND TERMINAL UNIT SCHEDULE FOR ADDITIONAL INFORMATION. EXTEND EXISTING CONTROL POWER WIRING FROM DEMOLISHED TERMINAL UNIT. CONTRACTOR SHALL ENGAGE SCHOOL BUILDING AUTOMATION CONTRACTOR AUTOMATIC SOLUTIONS GROUP, (937)313-1099 TO PROVIDE PROGRAMMING AND GRAPHICS TO INTEGRATE NEW TERMINAL UNIT INTO EXISTING BAS SYSTEM. THE EXISTING BUILDING CONTROL SYSTEM IS TRIDIUM AND THE CONTROL LANGUAGE IS BACNET MSTP.
- PROVIDE HEATING HOT WATER PIPING FROM NEW TERMINAL UNIT COIL TO EXISTING MAINS LOCATED IN CORRIDOR. UTILIZE EXISTING TAPS LEFT FROM DEMOLITION WORK WHERE
- NEW SINGLE DUCT VARIABLE AIR VOLUME TERMINAL UNIT WITH HOT WATER REHEAT COIL FURNISHED BY THE OWNER. REFER TO DETAIL "4", SHEET H0.2 AND TERMINAL UNIT SCHEDULE FOR ADDITIONAL INFORMATION. CONTRACTOR SHALL ENGAGE SCHOOL BUILDING AUTOMATION CONTRACTOR AUTOMATIC SOLUTIONS GROUP, (937)313-1099 TO PROVIDE PROGRAMMING AND GRAPHICS TO INTEGRATE NEW TERMINAL UNIT INTO EXISTING BAS SYSTEM. THE EXISTING BUILDING CONTROL SYSTEM IS TRIDIUM AND THE CONTROL LANGUAGE IS BACNET
- EXISTING RELOCATED VAV TERMINAL UNIT. REFER TO DETAIL "4", SHEET H0.2 AND TERMINAL UNIT SCHEDULE FOR ADDITIONAL INFORMATION. CONTRACTOR SHALL ENGAGE SCHOOL BUILDING AUTOMATION CONTRACTOR AUTOMATIC SOLUTIONS GROUP, (937)313-1099 TO PROVIDE PROGRAMMING AND GRAPHICS TO REVISE EXISTING BAS SYSTEM. THE EXISTING BUILDING CONTROL SYSTEM IS TRIDIUM AND THE CONTROL LANGUAGE IS BACNET MSTP.
- PROVIDE NEW TRANSFER AIR DUCT THROUGH WALL TO ABOVE CORRIDOR CEILING. PROVIDE WITH 1.5 HOUR DYNAMIC TYPE FIRE DAMPER AT TRANSFER DUCT WALL PENETRATION.
- EXISTING TRANSFER AIR OPENING TO REMAIN.
- PROVIDE TRANSFER AIR DUCT WITH 1" INTERIOR ACOUSTICAL
- LINING THROUGH WALL ABOVE CEILING. PROVIDE NEW THERMOSTAT/TEMPERATURE SENSOR EQUAL TO EXISTING SYSTEM. CONTRACTOR SHALL ENGAGE SCHOOL GROUP, (937)313-1099 TO PROVIDE PROGRAMMING AND GRAPHICS TO INTEGRATE INTO EXISTING BAS SYSTEM. THE EXISTING BUILDING CONTROL SYSTEM IS TRIDIUM AND THE CONTROL LANGUAGE IS BACNET MSTP.



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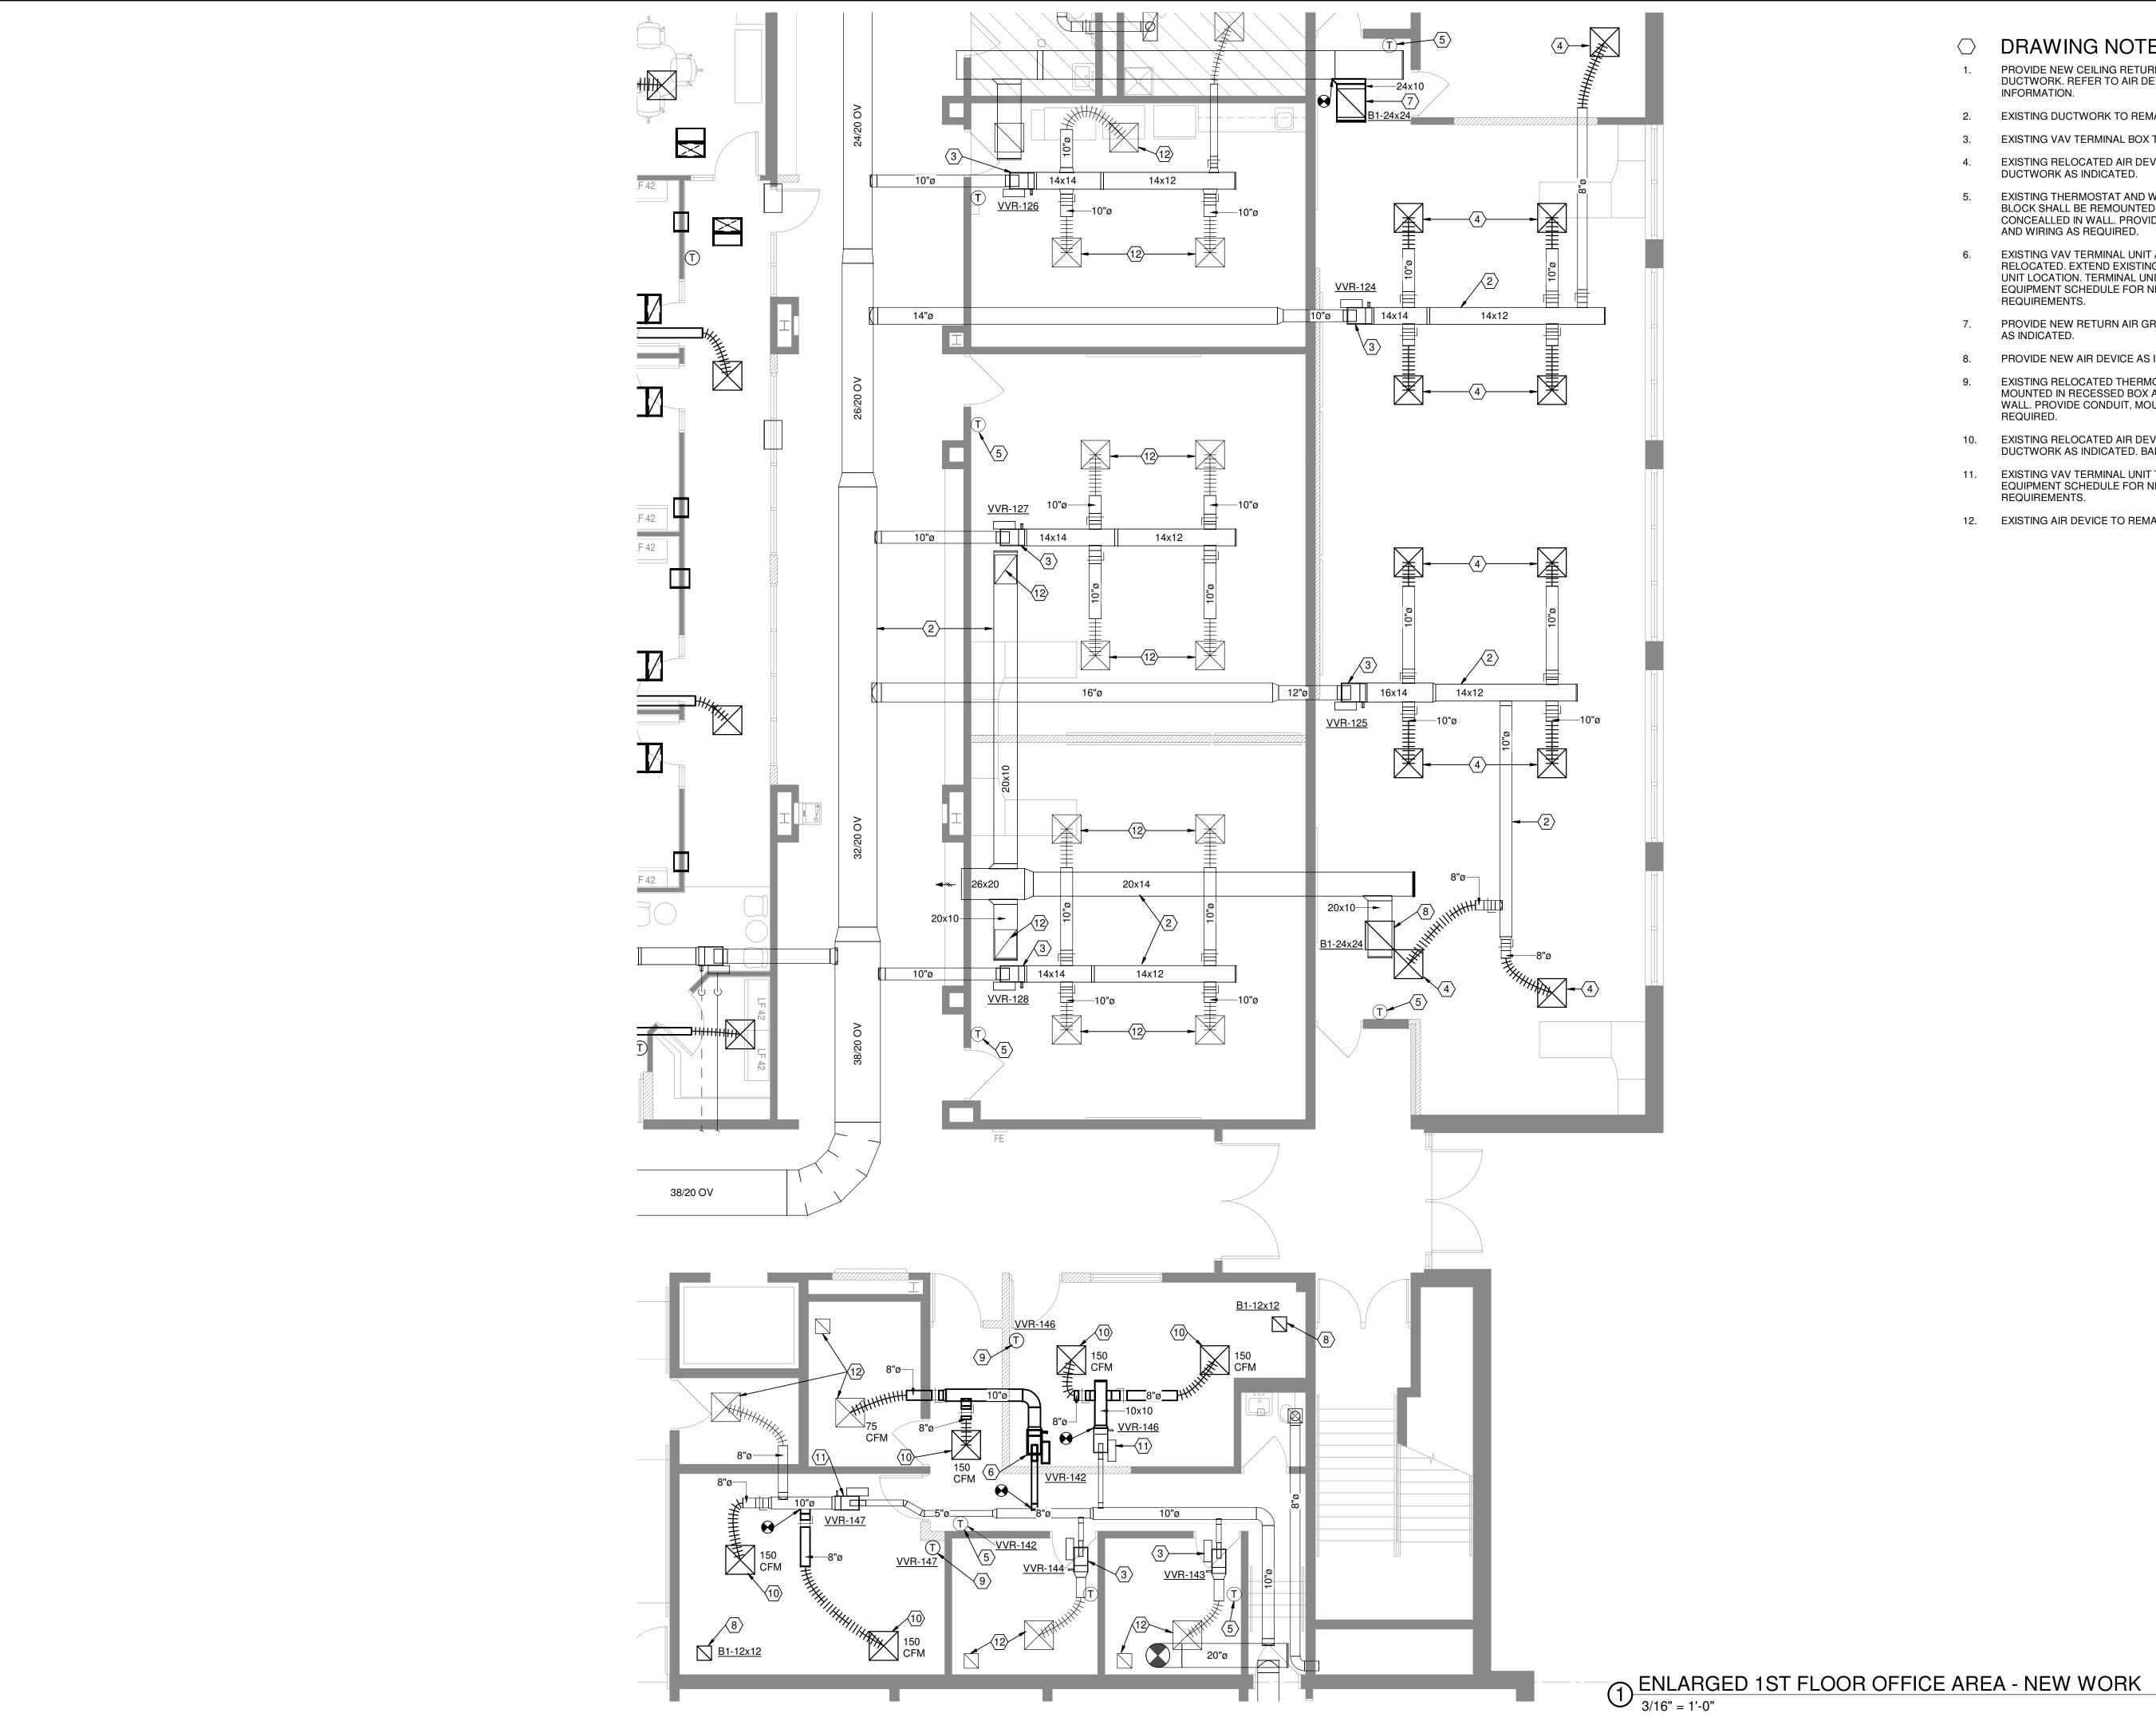
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Sheet Title

HVAC ENLARGED LIBRARY PLAN - NEW WORK


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- PROVIDE NEW CEILING RETURN GRILLE AND ASSOCIATED DUCTWORK. REFER TO AIR DEVICE SCHEDULE FOR ADDITIONAL
- EXISTING DUCTWORK TO REMAIN.
- EXISTING VAV TERMINAL BOX TO REMAIN.
- EXISTING RELOCATED AIR DEVICE. EXTEND NEW RUNOUT DUCTWORK AS INDICATED.
- EXISTING THERMOSTAT AND WIRING SURFACE MOUNTED TO BLOCK SHALL BE REMOUNTED IN RECESSED BOX AND WIRING CONCEALLED IN WALL. PROVIDE NEW CONDUIT, MOUNTING BOX AND WIRING AS REQUIRED.
- EXISTING VAV TERMINAL UNIT AND REHEAT COIL PIPING TO BE RELOCATED. EXTEND EXISTING HOT WATER PIPING TO NEW UNIT LOCATION. TERMINAL UNIT SHALL REBALANCED. REFER TO EQUIPMENT SCHEDULE FOR NEW PERFORMANCE REQUIREMENTS.
- PROVIDE NEW RETURN AIR GRILLE. PROVIDE NEW DUCTWORK
- PROVIDE NEW AIR DEVICE AS INDICATED.
- EXISTING RELOCATED THERMOSTAT. THERMOSTAT SHALL BE MOUNTED IN RECESSED BOX AND WIRING CONCEALLED IN WALL. PROVIDE CONDUIT, MOUNTING BOX AND WIRING AS REQUIRED.
- EXISTING RELOCATED AIR DEVICE. EXTEND NEW RUNOUT DUCTWORK AS INDICATED. BALANCE TO AIRFLOW INDICATED.
- 11. EXISTING VAV TERMINAL UNIT TO BE REBALANCED. REFER TO EQUIPMENT SCHEDULE FOR NEW PERFORMANCE REQUIREMENTS.
- 12. EXISTING AIR DEVICE TO REMAIN.

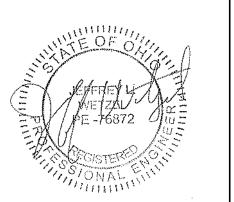

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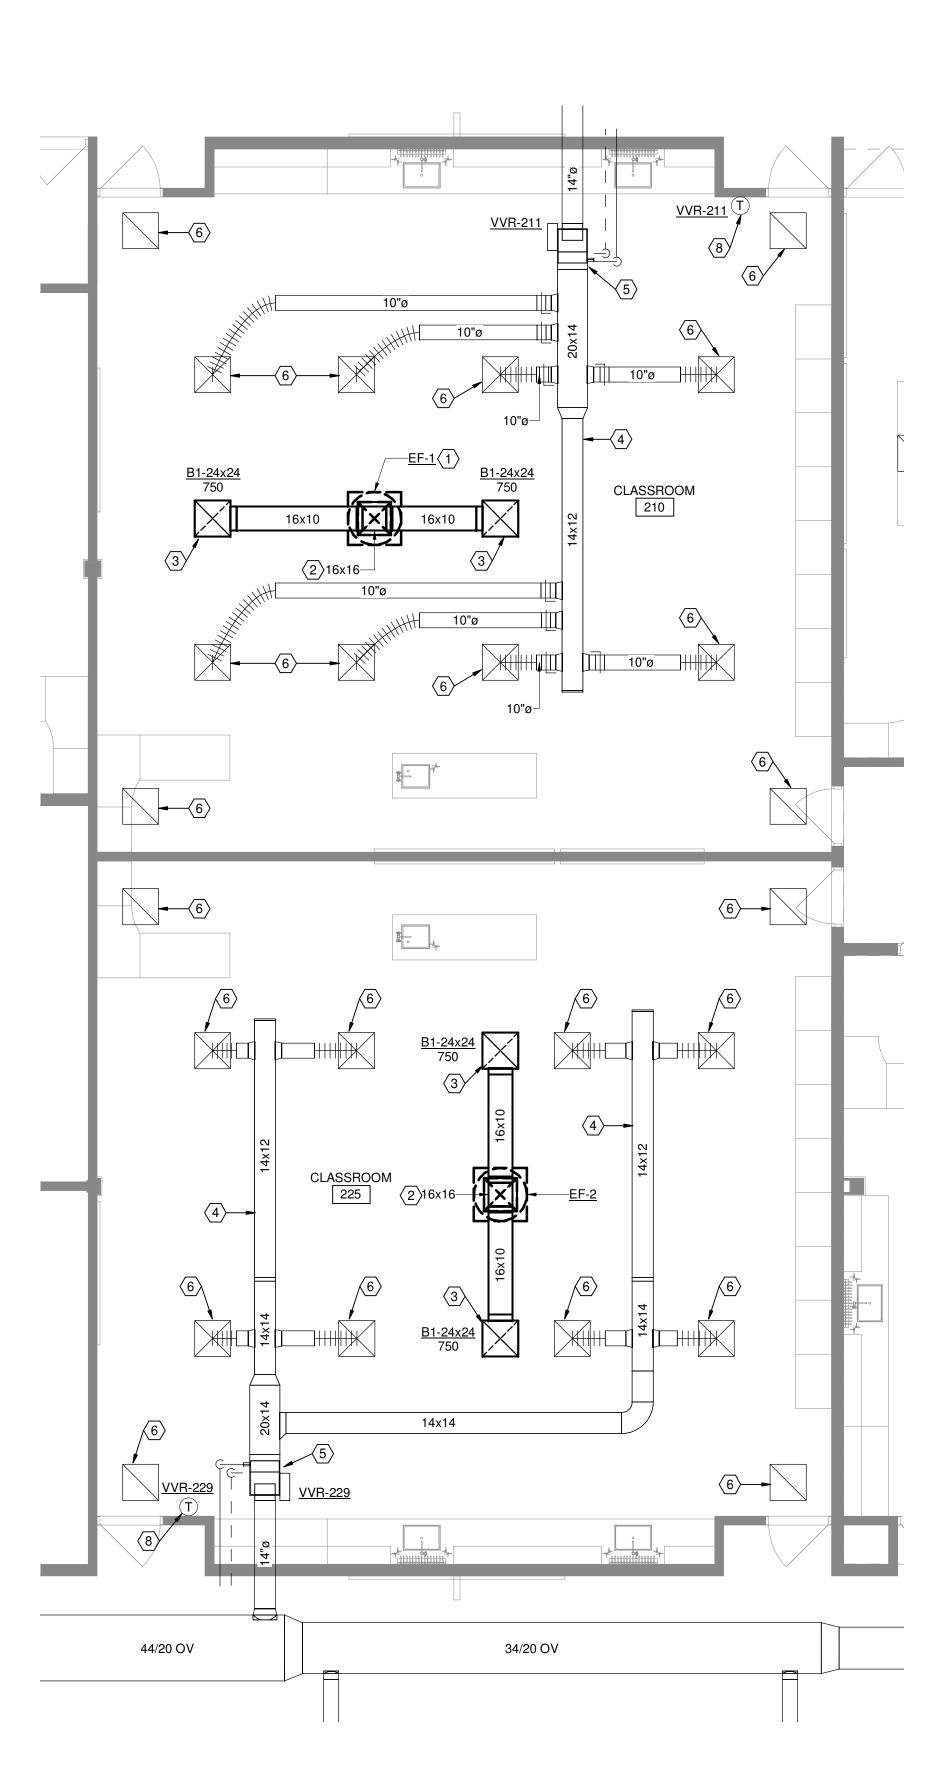
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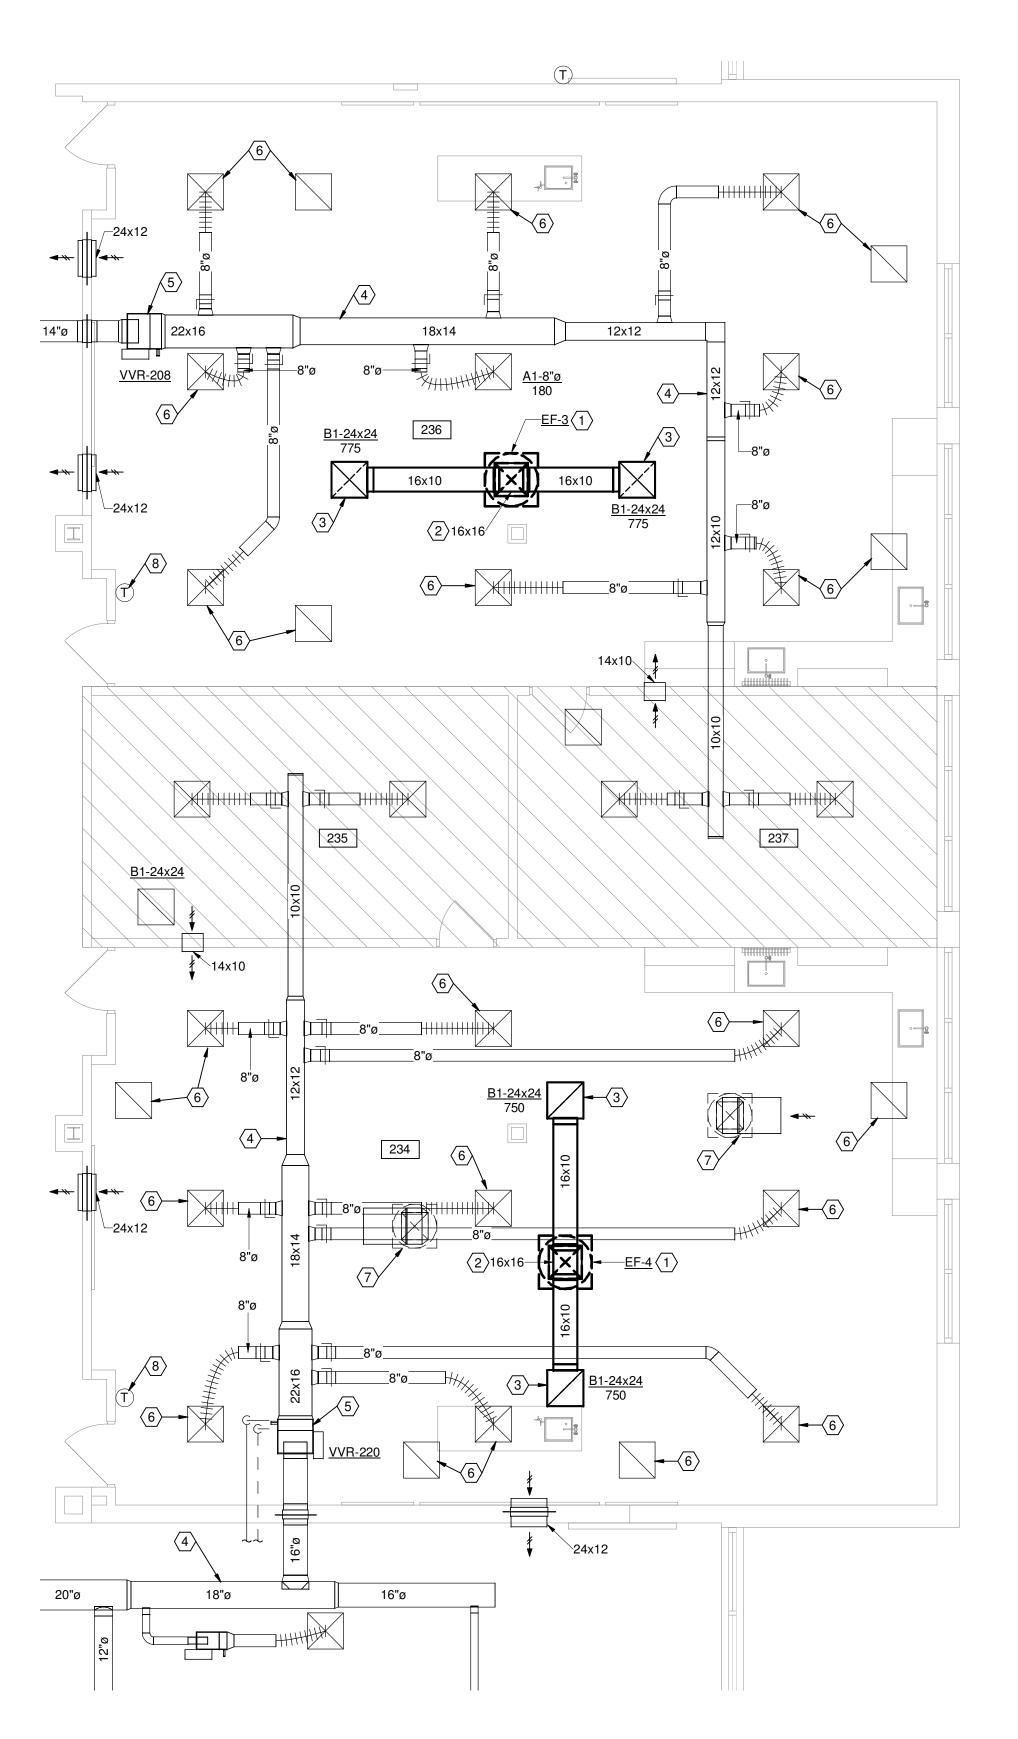
Sheet Title

HVAC ENLARGED OFFICE AREA - NEW WORK

Sheet Number

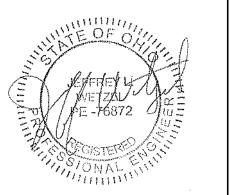


1 ENLARGED CLASSROOMS 210 & 225 - NEW WORK




2 ENLARGED CLASSROOMS 234 & 236 - NEW WORK
3/16" = 1'-0"

- PROVIDE NEW ROOF MOUNTED EXHAUST FAN. FAN SHALL BE CONTROLLED BY WALL MOUNTED ON/OFF SWITCH. REFER TO ELECTRICAL DRAWINGS FOR LOCATION OF SWITCH. REFER TO FAN SCHEDULE FOR ADDITIONAL INFORMATION.
- DUCT UP THROUGH ROOF TO EXHAUST FAN.
- PROVIDE NEW CEILING RETURN GRILLE AND ASSOCIATED DUCTWORK. REFER TO AIR DEVICE SCHEDULE FOR ADDITIONAL INFORMATION.
- 4. EXISTING DUCTWORK TO REMAIN.
- EXISTING VAV TERMINAL BOX TO REMAIN.
- EXISTING AIR DEVICE TO REMAIN.
- EXISTING ROOF MOUNTED PRESSURE RELIEF FAN AND ASSOCIATED DUCTWORK TO REMAIN.
- EXISTING THERMOSTAT TO REMAIN.

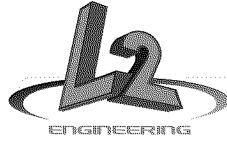

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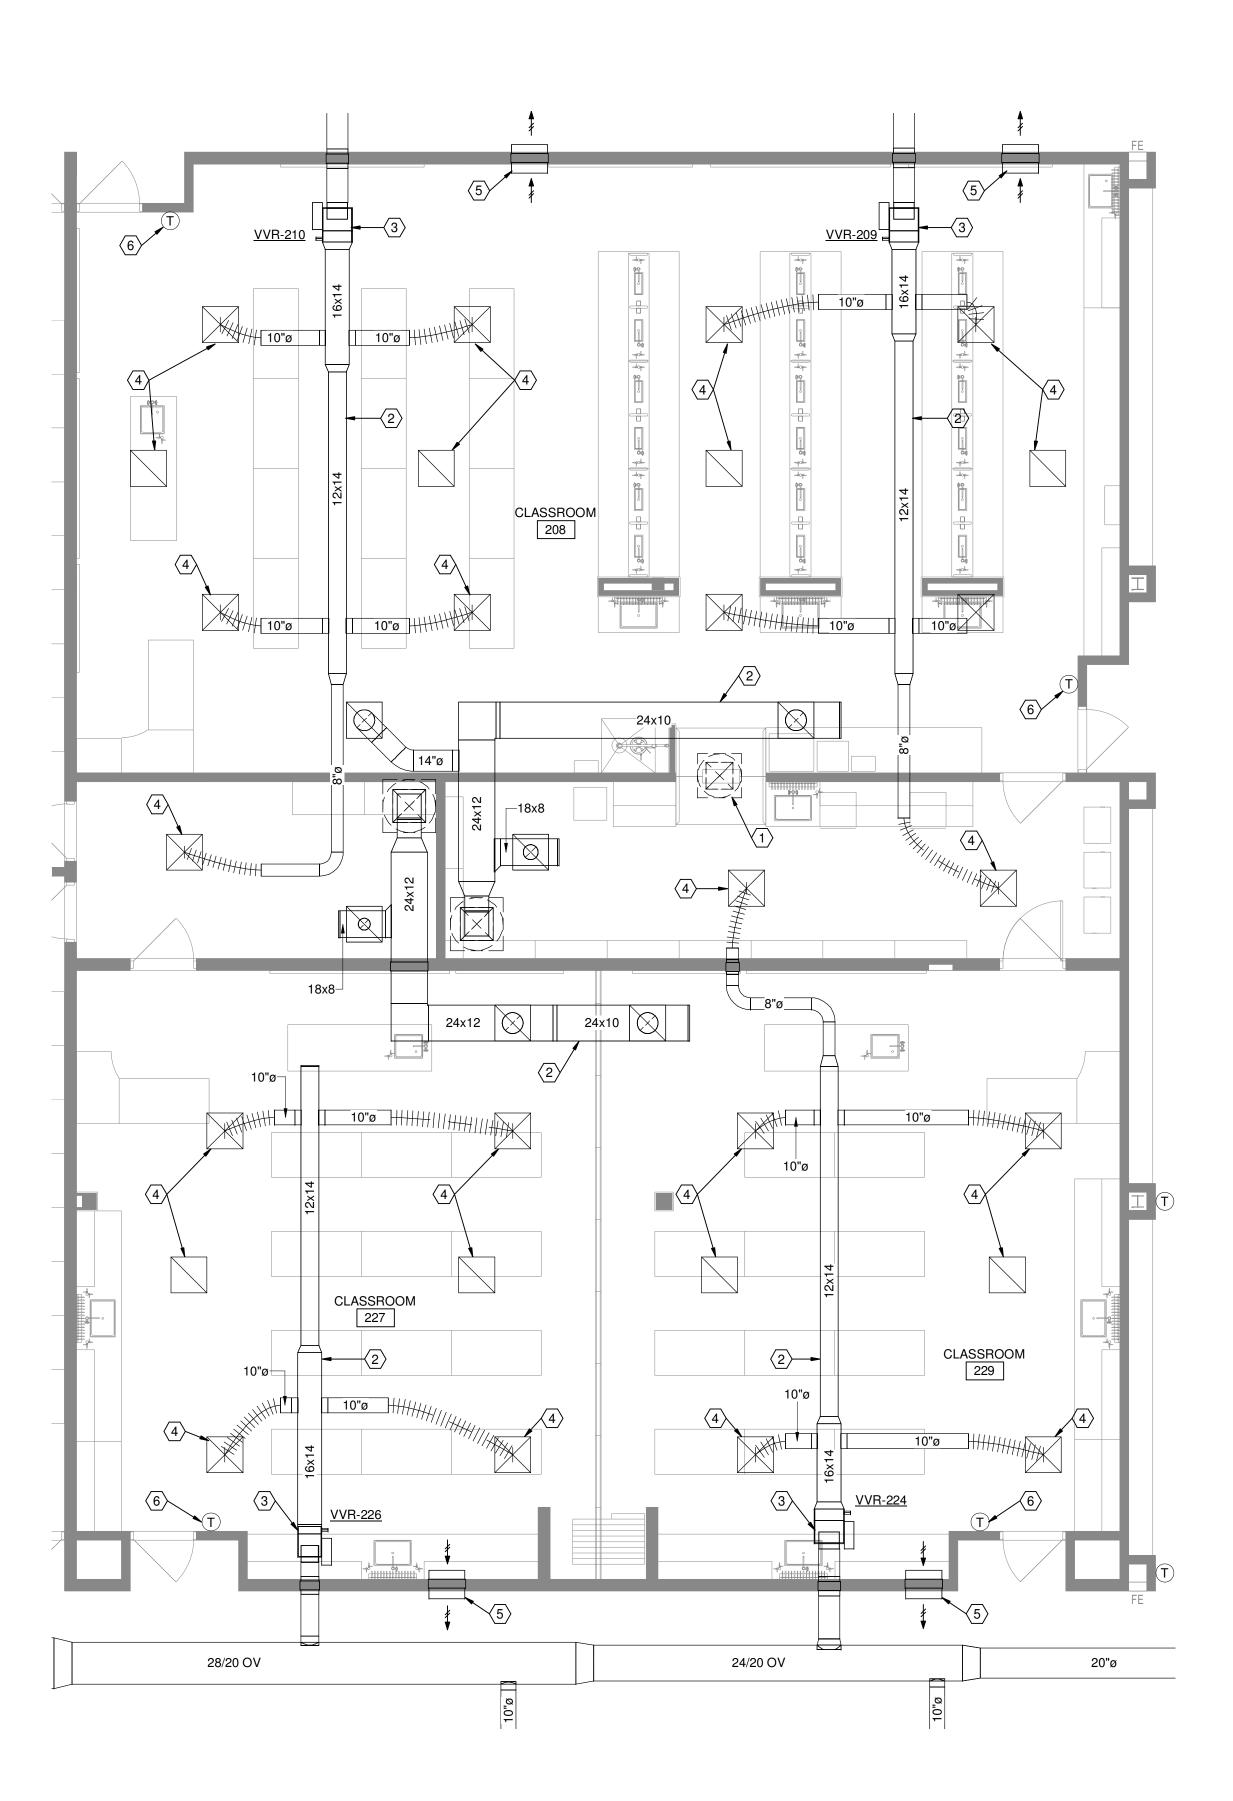
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Sheet Title

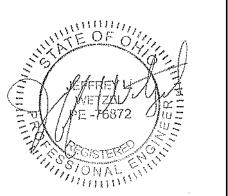ENLARGED CLASSROOMS 210, 225, 234 \$ 236 -NEW WORK

Sheet Number



1 ENLARGED CLASSROOMS 210 & 225 - NEW WORK 3/16" = 1'-0"

- EXISTING ROOF MOUNTED LAB HOOD EXHAUST FAN TO REMAIN.
- EXISTING DUCTWORK TO REMAIN.
- EXISTING VAV TERMINAL BOX TO REMAIN.
- EXISTING AIR DEVICE TO REMAIN.
- EXISTING TRANSFER OPENING TO REMAIN.
- EXISTING THERMOSTAT TO REMAIN.





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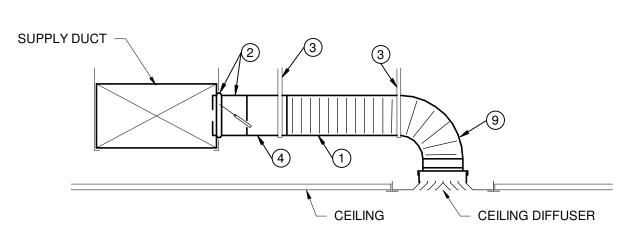
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Sheet Title

ENLARGED CLASSROOMS 208, 227 \$ 229 - NEW WORK


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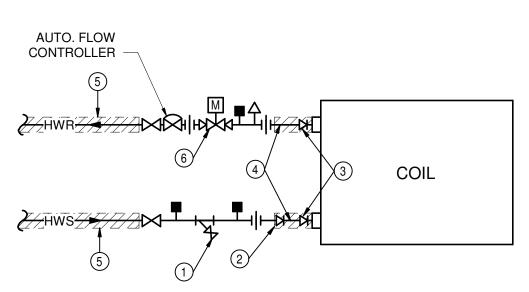
NOTES

- 1 INSULATED FLEXIBLE DUCT SAME DIAMETER AS BRANCH DUCT, 6 FT. MAXIMUM TOTAL LENGTH PER AIR DEVICE. STRETCH FLEXIBLE DUCT TO AT LEAST 90% OF FULLY EXTENDED LENGTH.
- 2 SPIN-IN BRANCH TAP FITTING, STRAIGHT SIDE WITH MANUAL DAMPER. DAMPER SHAFT IN HORIZONTAL. INTEGRAL INSULATION GUARD SLEEVE REQUIRED FOR TAP FITTING TO MAIN DUCT WITH INTERNAL INSULATION, AND EXTENDED DAMPER SHAFT AND HANDLE WITH STAND-OFF TO ACCOMMODATE EXTERNAL INSULATION.
- 3 DUCT STRAP HANGER. ATTACH TO STRUCTURE.
- 4 ROUND SHEET METAL BRANCH DUCT, SAME SIZE AS DIFFUSER INLET UNLESS NOTED OTHERWISE.

① CEILING DIFFUSER DUCT CONNECTION NTS



ROOF MOUNTED FANNTS

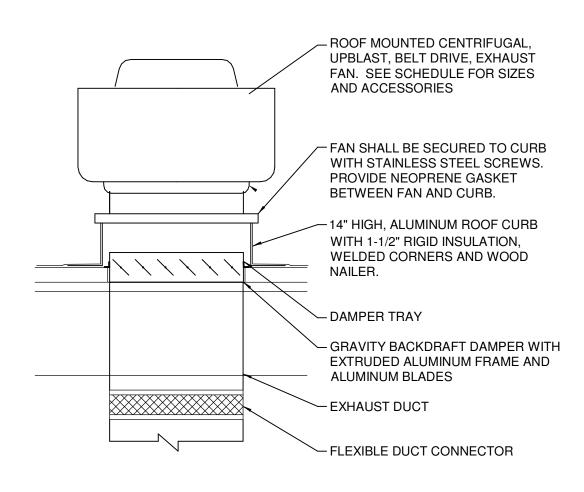

NOTES LOCATE STRAINER WITH BLOW-DOWN VALVE AND HOSE CONNECTION AT LOW POINT OF COIL

PIPE REDUCER IF REQUIRED.


PIPE REDUCER/INCREASER IF COIL CONNECTION SIZE DIFFERS FROM AUTO CONTROL VALVE SIZE.

PIPING SAME SIZE AS AUTO CONTROL VALVE OR COIL CONNECTION, WHICH EVER IS LARGER.

INSULATE PIPING UP TO SHUT-OFF VALVE.

MODULATING 2-WAY AUTOMATIC CONTROL

3 TERMINAL UNIT REHEAT PIPING DIAGRAM

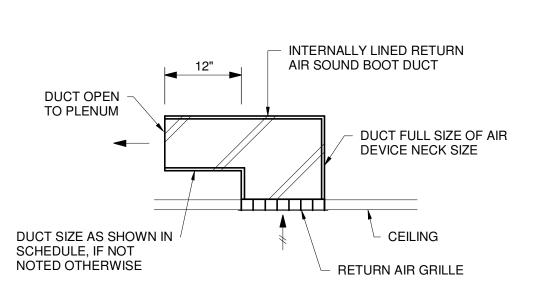

4 RETURN AIR SOUND BOOT

DUCT	WORK	(CO	NSTRU	JCT	ON S	СНІ	EDU	LE				
DUCT SYSTEM	SHAPE	PRESS. CLASS	MATERIAL		LINER			INSUL	ATION		NOTES	
DUCT SYSTEM	SHAPE	W.G.	IVIATERIAL	THK.	TYPE	D	THK.	TYPE	D	JACKET	NOTES	
CONCEALLED SUPPLY & RETURN	RND/RECT	-/+2"	GS	-	-	ı	1.5"	FGW	-	FFJ	1,3	
CONCEALLED SUPPLY AIR DEVICE RUNOUT	RND	+1"	IFD	=	-	-	1.5"	IFD	-	FFJ	2	
EXPOSED SUPPLY & RETURN	RND/RECT	-/+2"	GS	1"	PFL	-	-	-	-	-	4	
CHEMISTRY/BIOLOGY LAB EXHAUST	RND/RECT	-2"	SS	-	-	-	-	5				
GENERAL NOTES: A ALL PAINTING BY GENERAL CONTRACTO B ALL DUCT JOINTS AND SEAMS SHALL BE PER OMC CHAPTER 5.		SCHEI 1. 2. 3. 4.	DULE NOTES INCLUDES PLENUM A ROUND RU DUCTWOF AT CONTR SUBSTITU	DUCTW REA. JNOUTS RK WITH ACTOR' TED.	TO AIR D IN 15 FT C S OPTION	EVICES OF UNIT	SHALL E SHALL B LE WALL	BE EXTER BE INTERN	NALLY I	INSULATEI		
ABBREVIATIONS: AIFD ACOUSTICAL INSULATED FLEX-DUC ALUM ALUMINUM ABA ADHESIVE BACKED ALUMINUM	CT FFJ FGW FPW	FIE FIE	DIL FACED JA BERGLASS V RE WRAP	VRAP			PGGS PVCGS RECT	PVC (COATED		D STEEL ZED STEEL	

GALVANIZED STEEL

PREFORMED LINER

GALVANIZED STEEL SPIRAL PIPE

INSULATED FLEXIBLE DUCT

PERFORATED FABRIC DUCT

MATT FACED FIBERGLASS

ROUND

UFD

THICKNESS

STAINLESS STEEL

UNISULATED FLEXIBLE DUCT

GS

IFD

GSSP

PFD

PFL

ALL SERVICE JACKET

FIBERGLASS BOARD

DOUBLEWALL INSULATED

EXTRUDED POLYSTYRENE

CARBON STEEL

DENSITY (PCF)

ETPS

PLAN	TYPE	BASIS OF	DESIGN	CFM	ESP	WHEEL	DRIVE	MAX.	EL	ECTRIC		NOTE
MARK	TYPE	MANUF.	MODEL	CFIM	("WC)	SIZE	DRIVE	SONES	HP	VOLT	PHASE	
EF-1	CENTRIF. UPBLAST	GREENHECK	CUBE-140	1,500	0.38"	14"	BELT	10.0	1/4	120	1	1,2
EF-2	CENTRIF. UPBLAST	GREENHECK	CUBE-140	1,500	0.38"	14"	BELT	10.0	1/4	120	1	1,2
EF-3	CENTRIF. UPBLAST	GREENHECK	CUBE-140	1,550	0.38"	14"	BELT	10.0	1/4	120	1	1,2
EF-4	CENTRIF. UPBLAST	GREENHECK	CUBE-140	1,550	0.38"	14"	BELT	10.0	1/4	120	1	1,2

EQUIPMENT PLAN MARKS ARE FOR REFERENCE. CONTRACTOR SHALL COORDINATE FINAL EQUIPMENT NAMING/NUMBERING WITH SCHOOL MAINTENANCE SUPERVISOR.

PROVIDE WITH 14" HIGH MOUNTING CURB, NON-FUSED DISCONNECT SWITCH, BACKDRAFT DAMPER AND

FAN SHALL BE CONTROLLED BY WALL TIMER SWITCH. REFER TO ELECTRICAL DRAWINGS FOR SWITCH LOCATION. SWITCH AND WIRING BY E.C.

	AIR	DEV	ICE SC	HEDU	LE			
PLAN	DESCRIPTION	BASIS	OF DESIGN	MOUNTING	FINISH	MATERIAL	ACCESSORIES	NOTES
MARK	DESCRIPTION	MFR	MODEL		ГІМІЗП	IVIATENIAL	ACCESSONIES	NOTES
A1	SQUARE FACE DIFFUSER, 24x24 FACE	TITUS	OMNI	LAY-IN	WHITE	STEEL	-	-
A2	SQUARE FACE DIFFUSER, 24x24 FACE	TITUS	OMNI	SURFACE	WHITE	STEEL	OPP. BLADE DMPR	-
B1	EGGCRATE CEILING GRILLE	TITUS	50F	LAY-IN	WHITE	ALUM.	-	-
B2	EGGCRATE CEILING GRILLE	TITUS	50F	SURFACE	WHITE	ALUM.	OPP. BLADE DMPR	-

A. CARNES AND KRUEGER ACCEPTABLE ALTERNATE MANUFACTURER

NOTES:

			/	AIRFLOV	V			REHEA	T COIL			
PLAN MARK	TYPE	INLET SIZE	COOL MAX CFM	HEAT MAX. CFM	COOL MIN. CFM	EWT (°F)	EAT (°F)	MBH	GPM	CONN. SIZE	CTRL. VLV CV.	NOTES
VVR-118	SINGLE DUCT	12"	1,375	1,375	275	180	55	58.9	2.9	-	-	1
VVR-119	SINGLE DUCT	7"	600	600	120	180	55	25.9	1.3	1"	-	3
VVR-120	SINGLE DUCT	7"	600	600	120	180	55	25.9	1.3	1"	-	3
VVR-121	SINGLE DUCT	14"	1,800	1,800	360	180	55	77.7	3.9	1"	-	3
VVR-121B	SINGLE DUCT	14"	1,500	1,500	300	180	55	64.8	3.3	1"	-	
VVR-122	SINGLE DUCT	14"	1,275	1,275	255	180	55	50.1	2.5	-	-	2
VVR-123	SINGLE DUCT	12"	900	900	180	180	55	38.9	1.9	-	-	2
VVR-213	SINGLE DUCT	10"	600	600	120	180	55	25.9	1.3	1"	-	4
VVR-142	SINGLE DUCT	5"	275	275	0	180	55	13.4	0.6	-	-	2
VVR-143	SINGLE DUCT	4"	150	150	0	180	55	7.3	0.7	-	-	1
VVR-144	SINGLE DUCT	4"	150	150	0	180	55	7.3	0.7	-	-	1
VVR-146	SINGLE DUCT	4"	150	150	0	180	55	7.3	0.7	-	-	2
VVR-147	SINGLE DUCT	5"	225	225	0	180	55	12.2	0.5	-	-	2

GENERAL NOTES:

MANUFACTURER SHALL BE TITUS MODEL DESV MAXIMUM APD OF 0.35" WC. FOR BOX AND COIL.

HOT WATER CONTROL VALVE SHALL BE MODULATING 2-WAY UNLESS NOTED OTHERWISE.

THIS CONTRACTOR SHALL BE RESPONSIBLE FOR ALL LOW VOLTAGE POWER WIRING AND ANY REQUIRED TRANSFORMERS.

UNIT IS EXISTING TO REMAIN. UNIT SHALL BE COMMISSIONED FOR PROPER OPERATION AND


REBALANCED TO THE MAXIMUM AIRFLOW LISTED.

UNIT IS EXISTING TO REMAIN. BALANCE TO PERFORMANCES LISTED. UNIT IS RELOCATED. BALANCE TO PERFORMANCES LISTED.

UNIT SHALL BE FURNISHED BY THE OWNER FOR INSTALLATION. EXISTING UNIT TAG INDICATES VVR-213. BALANCE TO PERFORMANCES LISTED.

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Sheet Title

HVAC SCHEDULES \$ DETAILS

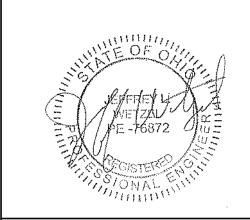Sheet Number

H3.0

ABBREVIATIONS

ABOVE FINISHED FLOOR AFF AFG ABOVE FINISHED GRADE BKR BREAKER CONDUIT CABLE TELEVISION CABINET UNIT HEATER CKT CIRCUIT Cu COPPER EXISTING

EXHAUST FAN

JUNCTION BOX

KILOWATTS

MECHANICAL

NIGHT LIGHT

NOT TO SCALE

PHASE (POLE)

TYPICAL

VOLTS

WATTS

LIGHTING

KILOVOLT AMPERE

NOT IN CONTRACT

POLYVINYL CHLORIDE

UNIT VENTILATOR

VERIFY IN FIELD

WATER COOLER

WEATHERPROOF

UNIT HEATER

VARIABLE AIR VOLUME

UNLESS NOTED OTHERWISE

TELEPHONE TERMINAL BOX

UNLESS OTHERWISE NOTED

KVA

KW

LGTG

MECH

TTB

TYP

VIF

UH

UON

ELECTRICAL **EMERGENCY EMERGENCY METALLIC TUBING** FCU FAN COIL UNIT GROUND

GROUND FAULT INTERRUPTER GALVANIZED RIGID CONDUIT HORSEPOWER

ALL CONDUIT DROPS FOR PLENUM RATED CABLES SHALL BE PROVIDED WITH A CONDUIT BUSHING ABOVE CEILING.

CIRCUITRY. DERATE PER CODE WHERE CIRCUITS ARE COMBINED.

CONDUCTORS FOR BRANCH CIRCUITRY ARE #12 AWG MINIMUM, UNLESS

ALL HOMERUN CONDUCTORS BACK TO PANEL SHALL BE #10 AWG MINIMUM,

UNLESS NOTED. PROVIDE A GREEN GROUND CONDUCTOR IN ALL BRANCH

NOTED. DERATE PER CODE WHERE CIRCUITS ARE COMBINED.

IN CEILING TILE, UNLESS NOTED.

FIXTURES WITH HVAC DUCTWORK.

WHERE TERMINATED IN J-BOX, ALL SPARE CIRCUITRY SHALL BE LABELED WITH PANEL AND CIRCUIT NUMBER.

COORDINATE WITH MECHANICAL CONTRACTOR AND PROVIDE ALL NECESSARY AUXILIARY CONTACTS, RELAY, ETC. IN MOTOR STARTERS FOR REQUIRED CONTROL OF MECHANICAL EQUIPMENT.

DO NOT SUPPORT CONDUIT OFF OF CEILING GRID, CEILING GRID SUPPORTS, MECHANICAL SUPPORTS. OR ANY OTHER TRADE'S SUPPORTS. INSTALL CONDUITS AND BOXES ON SEPARATE SUPPORTS FROM BAR JOIST OR

ALL EXISTING SWITCH LEGS ARE ASSUMED TO BE INSTALLED IN SLAB OF SPACE. INCLUDED IN THE SCOPE OF THIS PROJECT IS EXTENDING SWITCH LEGS TO ABOVE ACCESSIBLE CEILING IN SPACE IN ORDER TO ACCOMMODATE NEW LINE VOLTAGE LIGHTING CONTROL

ALL NEW ELECTRICAL DEVICES SHOWN IN BLOCK WALLS SHALL BE RECESSED IN EXISTING OR NEW BLOCK WALLS. COORDINATE REPAIR OF EXISTING CMU WALL WITH G.C.

ALL EXISTING OUTLETS, LIGHT SWITCHES AND ALL OTHER ELECTRICAL DEVICES SHALL BE REPLACED WITH NEW WHITE DEVICES AND STAINLESS STEEL COVERPLATES. VERIFY EXACT COLOR OF DEVICES AND COLOR PLATES WITH ARCHITECT PRIOR TO ORDERING. ALL COVER PLATES SHALL BE

E.C. IS TO FIELD VERIFY ALL HEIGHTS OF EXISTING DEVICES AND COORDINATE LOCATIONS OF NEW DEVICES TO AVOID CONFLICTS WITH OTHER TRADES, EXISTING AND NEW LOCATIONS. E.C. TO COORDINATE WITH HVAC CONTRACTOR FOR CORRECT MOUNTING HEIGHT OF THERMOSTATS.

ALL WAP AND SECURITY WIRE IS TO BE INSTALLED IN A WAY SO THAT IT IS ALWAYS PROTECTED FROM PHYSICAL DAMAGE. WHEN NOT IN A CABLE TRAY, IT MUST BE INSTALLED IN CONDUIT.

EC SHALL ORDER LONG LEAD ITEMS LIKE SPECIALTY LIGHT FIXTURES AS SOON AS POSSBILE.

GENERAL ELECTRICAL DEMO NOTES

EXISTING CONDITIONS SHOWN ON THIS DRAWING ARE TAKEN FROM ORIGINAL

ALL CONDUITS SERVING OTHER SPACES OR FLOORS, THAT RUN THROUGH THE

PROJECT AREA SHALL REMAIN ACTIVE DURING CONSTRUCTION SO AS NOT TO

ALL CEILING MOUNTED DEVICES NOT SPECIFICALLY INDICATED IN THE PROJECT

AREA SHALL BE REMOVED AND REINSTALLED TO FACILITATE INSTALLATION OF

SHALL BE REMOVED BACK TO PANEL FROM WHERE IT ORIGINATES OR TO NEXT

ALL CONDUIT, WIRING, BOXES, AND RACEWAY THAT IS NOT BEING REUSED

TRANSPORT AND STORE LUMINARIES TO AN ON-SITE OR OFF-SITE STORAGE

WRAPPING OR EQUIVALENT TO PREVENT LAMP BREAKAGE. PROVIDE STORAGE

BOXES. TRANSPORT AND STORE LAMPS TO AN ON-SITE OR OFF-SITE STORAGE

CIRCUITS SHALL BE RE-SUPPORTED OFF THE EXISTING STRUCTURE PER THE

DEMOLISHED SHALL BE FULLY REMOVED FROM BLOCK WALL. BLOCK WALL TO

DESCRIBED IN THE "E" SERIES DRAWINGS AND ALSO IN THE ARCHITECTUAL

BE REPAIRED BY OTHERS. COORDINATE WITH G.C. DEMO AND REPAIR SCOPE IS

COMPLETE, THE E.C. SHALL PROVIDE UNIT PRICING FOR REMOVAL OF EXISTING

ALL EXISTING SURFACE MOUNTED RACEWAY LOCATED IN CLASS ROOMS SHALL

DISCIPLINES INCLUDING, BUT NOT LIMITED TO, ARCHITECTRUAL, PLUMBING AND

THE ELECTRICAL SCOPE INCLUDES ALL CONSTRUCTION DOCUMENTS. SOME

OF THE ELECTRICAL DEMOLITION SCOPE MAY BE SHOWN ON OTHER

HAVC DRAWINGS. IT IS THE RSPONSIBILITY OF THE EC TO REVIEW ALL

DOCUMENTS AND PROVIDE ALL LABOR AND MATERIALS SHOWN ON ALI

SALVAGE ANY REMOVED LED LAMPS FOR THE OWNER. PROVIDE BUBBLE

ALL EXISTING NON-COMPLIANT, ABOVE CEILING CABLING AND BRANCH

LATEST EDITION OF THE NEC. E.C. SHOULD VERIFY ALL CONDITIONS.

ALL EXISTING ELECTRICAL DEVICES IN BLOCK WALLS INDICATED TO BE

REPAIR PLANS. EVEN THOUGH THESE DRAWINGS ARE BELIEVED TO BE

ELECTRICAL DEVICES INSTALLED IN BLOCK WALLS.

SALVAGE REMOVED LUMINARIES AND TURN OVER TO THE OWNER.

DRAWINGS AND FIELD INVESTIGATION. ALL EXISTING CONDITIONS MUST BE

VERIFIED PRIOR TO BID. FIELD CONDITIONS SHALL GOVERN.

CAUSE ANY DISRUPTION TO THESE OTHER SPACES.

NEW CEILINGS/LIGHT FIXTURES.

FACILITY DESIGNATED BY THE OWNER.

FACILITY. DESIGNATED BY THE OWNER.

DRAWINGS AND ALL SPECIFICATIONS.

ACTIVE DEVICE.

BE REMOVED.

GENERAL LIGHTING/POWER NOTES GENERAL PROJECT NOTES

WORK SHALL BE DONE IN ACCORDANCE WITH LOCAL, STATE OF OHIO, 2017 LIGHT FIXTURES DESIGNATED AS "NIGHT LIGHTS" SHALL BE ON UNSWITCHED NEC AND NATIONAL CODES, RECOMMENDATIONS, REGULATIONS, AND CIRCUIT, UNLESS NOTED. REQUIREMENTS.

EXIT LIGHTS SHALL BE ON UNSWITCHED CIRCUIT. COORDINATE ELECTRICAL REQUIREMENTS FOR NEW WORK WITH THE

PLUMBING AND MECHANICAL CONTRACTORS. VERIFY VOLTAGE, PHASE AND ALL RECESSED DOWNLIGHTS MOUNTED IN GRID CEILING SHALL BE CENTERED ACCESSORY REQUIREMENTS, SUCH AS MOTOR STARTERS AND IN ALL MECHANICAL ROOMS, COORDINATE EXACT LOCATION OF LIGHT

DRYWALL, ETC.

CONTRACTOR SHALL PERFORM ALL CUTTING AND PATCHING AS REQUIRED FOR HIS WORK. OPENING IN WALLS, FLOORS AND CEILINGS SHALL BE FILLED IN, PATCHED, PAINTED AND FINISHED IN A MANNER TO MATCH THE QUALITY OF THE EXISTING, LIKE ADJACENT SURFACES.

NEW OPENINGS IN EXISTING WALLS AND FLOORS SHALL BE CORE DRILLED OR SAW CUT. OPENINGS IN NEW WALLS AND FLOORS SHALL BE PLANNED AND COORDINATED WITH GENERAL CONTRACTOR FOR THE INSTALLATION OF APPROPRIATE SLEEVES.

ALL CONDUIT SHALL BE 3/4" MINIMUM U.N.O.

CONDUIT SHALL BE CONCEALED IN CEILING OR WALLS WHEREVER POSSIBLE. CONTACT ARCHITECT FOR DIRECTION WHERE CONDUIT CANNOT BE RUN CONCEALED WITHIN WALLS.

ALL BRANCH CIRCUITS AND FEEDERS SHALL CONTAIN A GREEN INSULATED GROUND CONDUCTOR. GROUNDING BY MEANS OF RACEWAY IS NOT

REFER TO MECHANICAL, PLUMBING, AND ARCHITECTURAL PLANS FOR

CONTRACTOR SHALL COORDINATE EXACT HEIGHT OF DEVICES DESIGNED

VERIFY CEILING TYPES PER THE ARCHITECTURAL REFLECTED CEILING PLAN. PROVIDE APPROPRIATE TYPE FIXTURE, LAY-IN FOR GRID, FLANGE FOR

VERIFY AND COORDINATE MOUNTING HEIGHTS AND LOCATIONS OF ALL DEVICES MOUNTED IN CASEWORK OR ABOVE COUNTERS WITH SPECIFIC EQUIPMENT FURNISHED.

CONTRACTOR SHALL PROVIDE ALL FIRESTOPPING FOR CONDUIT OR CABLE TRAY PENETRATIONS THAT PENETRATE ACOUSTICAL RATED OR SMOKE AND FIRE RATED ASSEMBLIES. SEE ARCHITECTURAL DRAWINGS FOR LOCATIONS OF ALL RATED ASSEMBLIES. ALL RATED PENETRATIONS SHALL BE FIRESTOPPED TO ORIGINAL ASSEMBLY RATING. ALL NON-RATED FLOOR PENETRATIONS SHALL BE SEALED WATER TIGHT WITH A FLEXIBLE SEALANT.

PROVIDE ALL PULL BOXES, IN ACCESSIBLE AREA, THAT EXCEED NEC NUMBER OF BENDS OR LENGTH IN FEEDER AND BRANCH CIRCUITS. INSTALL BOXES WHERE REQUIRED PER CODE.

ALL WIRING DEVICES SHALL BE OF HEAVY DUTY COMMERCIAL GRADE CONSTRUCTION. REFER TO ARCHITECTURAL SHEETS AND CODE SHEET FOR ALL FIRE-RATED PARTITION LOCATIONS AND RATINGS. COORDINATE COLORS WITH ARCHITECT.

CONTRACTOR IS RESPONSIBLE FOR ALL CORE-DRILLS REQUIRED FOR INSTALLATION OF ELECTRICAL WORK.

ROUTING OF CIRCUITRY INSTALLED IN CASEWORK, CABINETRIES, ETC. SHALL BE COORDINATED FOR PROPER CONCEALMENT AND FUNCTION OF CASEWORK, CABINETRIES, ETC.

VERIFY THE LOCATION OF ALL UTILITIES PRIOR TO EXCAVATION, TRENCHING, OR DRILLING.

18. ALL EXPOSED METAL CONDUITS ARE TO BE PAINTED TO MATCH THE ADJACENT SURFACE. COORDINATION OF PAINTING OF CONDUIT IS TO BE BY THE ELECTRICAL CONTRACTOR, WITH PAINTING BY OTHERS.

ELECTRICAL CONTRACTOR SHALL BE RESPONSIBLE FOR PROVIDING ALL REQUIRED JUNCTION BOXES, PULL BOXES. ETC FOR A COMPLETE INSTALLATION PER THE N.E.C. AND LOCAL CODES. ALL CONDUCTORS SHALL BE RATED FOR 90 DEGREE CELSIUS.

COORDINATE WORK WITH OTHER TRADES. COORDINATION OR SCHEDULING SHALL BE RESPONSIBILITY OF THE INVOLVED CONTRACTORS.

ALL LOW VOLTAGE CABLING INSTALLED IN SPACES WITHOUT A LAY-IN OR

WITH A HARD CEILING SHALL BE INSTALLED IN CONDUIT AND BOXES.

FIRE ALARM DEVICES SHOWN FOR REFERENCE ONLY. CONTRACTOR TO ENGAGE FIRE ALARM SUPPLIER FOR FIRE ALARM PERMIT DRAWINGS. EXISTING FIRE ALARM SYSTEM IS TO BE VERIFIED AT SITE. ELECTRICAL CONTRACTOR TO COORDINATE WITH EQUIPMENT SUPPLIER FOR ALL COMPONENTS REQUIRED. E.C. TO PROVIDE ALL FIRE ALARM DOCUMENTS REQUIRED TO SECURE A FIRE ALARM PERMIT. CONTRACT WITH OWNER'S

VENDOR: SECURECOM TO ACCOMPLISH THIS WORK. EC TO PROVIDE LABOR AND MATERIALS TO CHANEL ALL EXISTING BLOCK WALLS TO INSTALL NEW ELECTRICAL DEVICES. EC SHALL COORDINATE WITH THE GC AND MASONRY CONTRACTOR TO ENSURE THAT ALL OF THE SCOPE IS COORDINATED AT TIME OF BID.

EC IS RESPONSIBLE FOR MAKING SURE THAT ALL EXISTING DEVICES ARE TO REMAIN ACTIVE AND FUNCITONING AFTER ANY WORK TO THE EXISTING CIRCUITS.

EC TO SUPPLY ALL CONDUIT, PATHWAYS, WIRING (ALL CABLES LABELED AT EACH END FOR OPENING #, LOCATION, AND DEVICE), TERMINATIONS (EXCEPT FOR ANY CARD READER BY SECURITY CONTRACTOR). COORDINATE WITH OWNER'S SECURITY CONTRACTOR ON THE NECESSARY WIRING TO SUPPLY AND INSTALL PER THE OWNER'S SPECIFICATIONS. ELECTRICAL CONTRACTOR RESPONSIBLE FOR TEMPORARILY REMOVING AND REINSTALLING ANY WIRING OR PATHWAYS ON EXISTING OPENINGS BEING RETROFITTED WITH NEW DOORS, FRAMES, AND HARDWARE.


AS OVER COUNTER WITH CASE WORK AND FURNITURE DRAWINGS.

	ELECTRICA	AL LEG	IEND
	LIGHTING		FIRE ALARM
?	LIGHTING FIXTURE. REFER TO FIXTURE SCHEDULE. LETTER INDICATES	E	FIRE ALARM PULL STATION, 44" AFF MOUNTING HEIGHT
0	TYPE.	ÞF	FIRE ALARM HORN/STROBE. 80" AFF MOUNTING HEIGHT
	EMERGENCY LIGHTING FIXTURE WITH EMERGENCY BALLAST. "NL"	0	FIRE ALARM DUCT MOUNTED SMOKE DETECTOR. S = SUPPLY, R = RETURN - COORDINATE WITH DUCTWORK. MAKE SAMPLING TUBE FULL
?	INDICATES NIGHT LIGHT CIRCUIT. FULL LUMEN OUTPUT MINIMUM 1400 LUMENS ON LAMP. CONNECT BALLAST AHEAD SWITCHES. LED LIGHT	l	WIDTH OF DUCT IN LENGTH. PROVIDE SMOKE DETECTOR FOR DAMPER
	FIXTURES SHALL OPERATE ON INVERTER SYSTEM. REFER TO DETAILS	$\Big \Big _{R}$	OPERATION AND 120 VOLT POWER CONNECTION AS SHOWN ON THE POWER DRAWINGS. COORDINATE ALL CONNECTIONS WITH
	ON DRAWING (NL - NIGHT LIGHT - FIXTURE TO OPERATE CONTINUOUSLY.)	• n	MECHANICAL CONTRACTOR. CONNECT TO ALARM SYSTEM.
		<u> </u>	FIRE ALARM CEILING MOUNTED SMOKE DETECTOR.
? 0	LIGHTING FIXTURE. LETTER INDICATES TYPE.	FAAP	FIRE ALARM ANNUNCIATOR PANEL.
? ●	EMERGENCY LIGHTING FIXTURE WITH EMERGENCY BALLAST OR POWERED THROUGH INVERTER SYSTEM.	FACP	FIRE ALARM CONTROL PANEL. FIRE ALARM STROBE. 80" AFF MOUNTING HEIGHT.
←	CEILING MOUNTED EXIT SIGN. REFER TO FIXTURE SCHEDULE. SHADED		BLUE EXTERIOR STROBE LIGHT FOR FIRE DEPARTMENT CONNECTION
X1 ⊠	AREA DENOTES FACE OF UNIT. CONNECT TO LOCAL UNSWITCHED LIGHTING CIRCUIT. WALL MOUNTED EXIT SIGN. REFER TO FIXTURE SCHEDULE. SHADED	WP WP	WP - WEATHERPROOF
? ₩Η	AREA DENOTES FACE OF UNIT. CONNECT TO LOCAL UNSWITCHED LIGHTING CIRCUIT.	FS	SPRINKLER SYSTEM FLOW SWITCH FURNISHED AND INSTALLED BY THE FIRE PROTECTION CONTRACTOR, CONNECTED BY ELECTRICAL
<u> </u>	SINGLE POLE WALL SWITCH. 120/277 VOLT, 20 AMP. 44" AFF.		CONTRACTOR.
3 \$	THREE WAY WALL SWITCH. 120/277V, 20 AMP. 44" AFF	TS	SPRINKLER SYSTEM GATE VALVE. SUPERVISORY SWITCH FURNISHED AND INSTALLED BY THE FIRE PROTECTION CONTRACTOR, CONNECTED
^ 4\$	FOUR WAY WALL SWITCH. 120/277V, 20 AMP. 44" AFF	dF)	BY ELECTRICAL CONTRACTOR.
oc [¢]	OCCUPANCY SENSOR WALL SWITCH. 120/277V, 20 AMP. 44" AFF	WP	FIRE ALARM STROBE. 80" AFF MOUNTING HEIGHT.
Ψ	SINGLE POLE KEYED WALL SWITCH. 120/277V, 20 AMP. 44" AFF	DH	MAGNETIC DOOR HOLD OPEN.
* *	EXTERIOR LIGHT FIXTURE. ER, EXISTING TO REMAIN, PL1 - NEW	RPS	FIRE ALARM REMOTE POWER SUPPLY.
¤	FIXTURE. REFER TO FIXTURE SCHEDULE.		FIRE ALARM MONITOR MODULE.
<u>+</u>	EMERGENCY EGRESS LIGHT. REFER TO FIXTURE SCHEDULE.	R	FIRE ALARM CONTROL RELAY MODULE.
<u>(oc)</u>	CEILING MOUNTED OCCUPANCY SENSOR.	E.O.L.R. >	END OF THE LINE RESISTOR.
	POWER	KB	FIRE ALARM CONTROL RELAY MODULE.
Φ	DUPLEX RECEPTACLE. 120 VOLT, 20 AMP. 18" AFF UNO.		
	DUPLEX RECEPTACLE WITH USB PLUG. 120 VOLT, 20 AMP. 18" AFF UNO.		CARBON MONOXIDE DETECTOR.
Ψ _υ	15A TAMPER RESITANT ULTRA FAST USB TYPE A/C OUTLET. SIMILAR TO LEGRAND #R26USBAC6W.		DOOR ACCESS
T	DUPLEX RECEPTACLE MOUNTED AT 44" OR ABOVE BACKSPLASH. 120 VOLT, 20 AMP.	E	ELECTRIC DOOR STRIKE.
#	DOUBLE DUPLEX RECEPTACLE. 120 VOLT, 20 AMP. 18" AFF UNO.	DC	DOOR SWITCH/CONTACT.
•	120 VOLT DOUBLE DUPLEX, 20 AMP RECEPTACLE MOUNTED AT 46" AFF OR 4" ABOVE BACKSPLASH.	CR	KEY OR KEYCARD ACTIVATED SWITCH IN TAMPER PROOF ENCLOSURE WP - WEATHERPROOF.
	DUPLEX RECEPTACLE WITH GROUND FAULT PROTECTION. 120 VOLT, 20 AMP. 18" AFF UNO, WP-WEATHERPROOF BOX	HC	HANDICAP DOOR ACCESS BUTTON IN FLUSH WALL BOX.
Φ	FLUSH FLOOR DUPLEX RECEPTACLE IN FLOOR BOX]	NTRUDER DETECTION SYSTEM
φ	120 VOLT SINGLE 20 AMP RECEPTACLE.	PIR	CEILING MOUNTED MOTION SENSOR DEVICE.
Ψ_{c}	DUPLEX RECEPTACLE. CEILING MOUNTED	KP	CEILING MOUNTED MOTION SENSOR DEVICE.
A	SPECIAL PURPOSE RECEPTACE. REFER TO FLOOR PLANS		
<u> </u>	FOR NEMA CONFIGURATION.		DATA & COMMUNICATION
\$ _m	FRACTIONAL HP MOTOR STARTER WITH THERMAL OVERLOADS. ELECTRICAL MOTOR.	∇	DATA /COMMUNICATION OUTLET. TWO PORTS REFER TO DETAIL FOR MOUNTING REQUIREMENTS.
	INDICATES FINAL CONNECTION REQUIRED.	lacksquare	WALL PHONE. 54" AFF.
XXX-1	HOMERUN TO PANELBOARD. NOTION INDICATES PANEL AND CIRCUIT NUMBER. (ALL CONDUCTORS SHALL BE #10 UNLESS NOTED		DATA OUTLET. 18" AFF.
	OTHERWISE.) ELECTRICAL PANELBOARD.	∇	DATA/COMMUNTICATION. FOUR PORT DATA, 18" AFF.
<u> </u>	JUNCTION BOX.		DATA/COMMUNITICATION FOLID DODT DATA 19" AFE
<u>.</u>	CONDUIT STUB-OUT AND CAP BELOW GRADE. MARK STUB-OUT AT GRADE LEVEL.		DATA/COMMUNTICATION. FOUR PORT DATA, 18" AFF.
—UE—	UNDERGROUND HIGH VOLTAGE OR SECONDARY SERVICE FEED.	VWAP	WIRELESS ACCESS CONNECTION POINT WITH CEILING MOUNTED CISCO WIRELESS DEVICE.
r□ _{4X}	SAFETY DISCONNECT SWITCH (NON-FUSED). 4X INDICATES ENCLOSURE TYPE.	\(\tau_{\tau} \)	INDICATES TO BE REMOVED.
г <u>Д</u>	SAFETY DISCONNECT SWITCH (FUSED).		INTERCOM CALL STATION, 48" AFF.
rX	COMBINATON MOTOR STARTER/DISCONNECT. WITH HOA SWITCH AT UNIT (FUSIBLE). OR (CIRCUIT BREAKER FOR ELEVATOR).	S √	WALL MOUNTED SPEAKER
<u>T1</u>	TRANSFORMER (NUMBER INDICATES WHICH TRANSFORMER).	©S)	CEILING SPEAKER
HD	HAND DRYER, VERIFY MOUNTING WITH SUPPLIER		CCTV
		4	

ELECTRICAL LEGEND

ELECTRICAL INDEX OF DRAWINGS SHEET NUMBER ELECTRICAL LEGEND AND GENERAL NOTES E0.01 ELECTRICAL EQUIPMENT AND LIGHTING SCHEDULE E0.02 FIRST FLOOR OVERALL POWER PLAN - DEMO FIRST FLOOR OVERALL LIGHTING PLAN - DEMC E2.01 FIRST FLOOR OVERALL ELECTRICAL PLAN - NEW WORK E2.02 FIRST FLOOR ENLARGED POWER PLAN - NEW WORK E2.03 FIRST FLOOR ENLARGED POWER PLAN - NEW WORK E2.04 FIRST FLOOR OVERALL LIGHTING PLAN - NEW WORK FIRST FLOOR ENLARGED LIGHTING PLAN - NEW WORK E2.05 FIRST FLOOR ENLARGED LIGHTING PLAN - NEW WORK E2.06 FIRST FLOOR LIGHTING THEATRE E2.07 E2.08 FIRST FLOOR LIGHTING GYM FIRST FLOOR POWER - PART '5' E2.10 FIRST FLOOR POWER - PARTS '3' & '4' SECOND FLOOR OVERALL ELECTRICAL PLAN - NEW WORK SECOND FLOOR LIGHTING 'PART 7' ELECTRICAL DETAILS E3.01 E3.02 ELECTRICAL DETAILS ELECTRICAL DETAILS E3.03 E3.04 LEHIGH DETAILS E3.05 LEHIGH DETAILS LEHIGH DETAILS E3.06 E3.07 LEHIGH DETAILS LEHIGH DETAILS E3.08 E3.09 LEHIGH DETAILS LEHIGH DETAILS E4.01 PANELBOARD SCHEDULES PANELBOARD SCHEDULES E4.02

	TECH	HNOLOGY INDEX OF DRAWINGS
	SHEET NUMBER	SHEET NAME
١	T1.01	FIRST FLOOR OVERALL DATA PLAN - DEMO
١	T1.10	FIRST FLOOR OVERALL DATA PLAN - NEW WORK

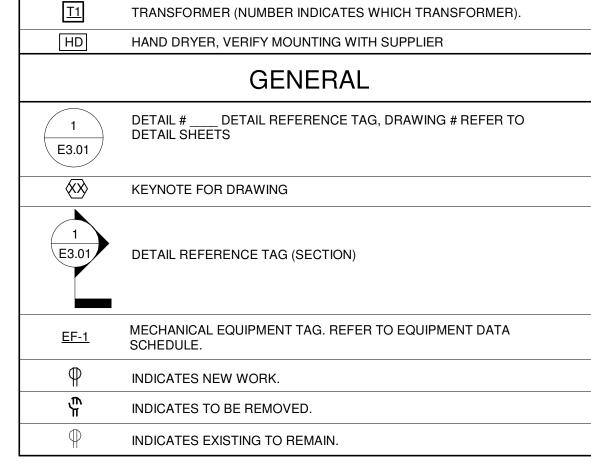

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Project Number 2021131

January 24, 2022

Sheet Title

ELECTRICAL LEGEND AND GENERAL NOTES

Sheet Number

EO.O

EQUIPI	MENT ELECTRICAL DATA SCHEDULE																								
		LOA	AD CH	HARA	CTEF	RISTIC	CS				STA	ARTER					DIS	CONNECT	-	CTRL DEVICE					
PLAN SYMBOL	DESCRIPTION/LOCATION	KW	윺	VOLTAGE	PHASE	FLA	SPEED DRIVE	TYPE	NEMA SIZE	FURNISH BY	INSTALL	AUXIL. RELAY	LOCATION	TYPE	FURNISH	BY	BY	SWITCH/ FUSE SIZE	LOCATION	TYPE FURNISH BY INSTALL BY	PANEL	CIRCUIT	FEEDER SIZE/ RACEWAY	NOTES	PLAN SYMBOL
EF-1	EXHAUST FAN	-	1/4	120	1	-	-	-	-	ES	ES	-	IN UNIT	NFS	-		-	20A	-	SW	-	-	(2) #12, (1) #12 GRD. IN .75" C.	-	EF-1
EF-2	EXHAUST FAN	-	1/4	120	1	-	-	-	-	ES	ES	-	IN UNIT	NFS	; -		-	20A	-	SW	-	-	(2) #12, (1) #12 GRD. IN .75" C.	-	EF-2
EF-3	EXHAUST FAN	-	1/4	120	1	-	-	-	-	ES	ES	-	IN UNIT	NFS	; -		-	20A	-	SW	-	-	(2) #12, (1) #12 GRD. IN .75" C.	-	EF-3
EF-4	EXHAUST FAN	-	1/4	120	1	-	-	-	-	ES	ES	-	IN UNIT	NFS	-		-	20A	-	SW	-	-	(2) #12, (1) #12 GRD. IN .75" C.	-	EF-4

CC - CONTROL CONTRACTOR

ABBREVIATIONS:

CP - CORD/PLUG EC - ELECTRICAL CONTRACTOR ES - EQUIPMENT SUPPLIER

FS - FUSED SWITCH
FSC - FIRE SUPPRESSION CONTRACTOR
FSEC - FOOD SERVICE EQUIP. CONTRACTOR

FVNR - FULL VOLTAGE NON-REVERSING

GC - GENERAL CONTRACTOR HC - HEATING CONTRACTOR PC - PLUMBING CONTRACTOR

SC - SPRINKLER CONTRACTOR

VC - VENTILATION CONTRACTOR TS - THERMOSTAT SW - HORSEPOWER RATED SWITCH

NOTES:

LIG	HTIN	IG F	IXT	URE	SCH	HEDUL	E																		
		LA	MPS/L	.IGHT	ENGIN	ΙE								CLASSIFICATION		TF	RIM (COLO	ıR		MOUNTING	S	IZE (IN	1.)	
IXTURE SYMBOL	OURESCENT	CANDESCENT	ITITY	E.D.	ATTS/LAMP	(MANUFACTURER) CATALOG NUMBER	XTURE VOLTAGE	XTURE INPUT WATTS	CT (TEMPERATURE K)	ELIVERED LUMENS	MANUFACTURER AND MODEL NUMBER	OTHER ACCEPTABLE MANUFACTURER	DIFFUSER MEDIA	EM - EMERGENCY N - NORMAL HAZ - HAZARDOUS HB - HIGH BAY LB - LOW BAY HM - HIGH MAST	НТЕ	ICKEL	нвоме	RONZE	NDAF	ш	S - SURFACE R - RECESSED SM - STEM MTD. WM - WALL MTD. C - CHAIN MTD. UC - UNDER CAB. CS - CEIL. SURF.	AMETER OR WIDTH	ENGTH	ЕРТН	NOTES
A1	<u>ш</u>			_i 1	<i>≤</i> 40		277	40	4,000	4,281	FINELITE #HP4-P-D-S-940-DL-96LG-277-SC-FC-10%-FVA50-SW	AS PRE-APPROVED	DOWNLIGHT DIFFUSER	N	>	Z	O	В	O	ν X	C	4	96	4	1,2
A2	_	-	_	1	40	_	277	40	4,000		COLUMBIA #CFP22-55/41/3440	AS PRE-APPROVED	EDGE LIT PANEL	N	Х					$\stackrel{\wedge}{+}$	R - LAY IN	23.7	23.7	1.68	-
A5	-	-	-	1	40	-	277	40	4,000	5,030	COLUMBIA #CFP24-55/41/3440	AS PRE-APPROVED	EDGE LIT PANEL	N	Х						R - LAY IN	23.7	47.7	1.68	-
C1	-	-	-	1	32.5	-	277	40	4,000	1,324	PRESCOLITE #LC6ML-6LCML-24L-40K-8	AS PRE-APPROVED	SEMI-DIFFUSE REFLECTOR	N						Х	R	12.02	47.98	1.69	2
C2	-	-	-	1	13.4	-	277	37.5	4,000	4,376	GREENCREATIVE #LEL-90-35-DIM010UNV-WD-ADR6-CW	AS PRE-APPROVED	SEMI-DIFFUSE CLEAR	N						Х	R	4	14.375	6.75	1,2,3
D1	-	-	-	1	28	-	277	28	4,000	2,980	HEXO EVO #HEXO-D/1.5-LM-SUR-WH-OP-40K-UNV-010V-29L	AS PRE-APPROVED	OPAL COVER	N						Х	S	1.5	DIA	2.5	1,2
D2	-	-	-	1	35	-	277	35	4,000	4,180	HEXO EVO #HEXO-D/2-LM-SUR-WH-OP-40K-UNV-010V-40L	AS PRE-APPROVED	OPAL COVER	N						Х	S	2	DIA	2.5	1,2
D3	-	-	-	1	57	-	277	57	4,000	7,100	HEXO EVO #HEXO-D/3-LM-SUR-WH-OP-40K-UNV-010V-68L	AS PRE-APPROVED	OPAL COVER	N						Х	S	3	DIA	2.5	1,2
X1		-			2.42	-	277	2.42	-		DUAL LITE #EVC-R-W	AS PRE-APPROVED	EMERGENCY EGRESS	EM						Х	WM-8'-0''	9	12	2.55	4
	-	-	-	-	-	-	277	-	-	-	COMPASS #CU2	AS PRE-APPROVED	EMERGENCY EGRESS	EM						Х	WM-8'-0''	4	9	2.75	-

1. COORDINATE WITH ARCHITECT FOR CORRECT MOUNTING HEIGHT.
2. COORDINATE WITH ARCHITECT FOR FINISH OF FIXTURE PRIOR TO ORDERING.
3. COORDIANTE CORRECT COLOR TEMPERATURE OF FIXTURE WITH OWNER PRIOR TO ORDERING.
4. PROVIDE DUAL LITE #WGLXE WHEN SPECIFIED.

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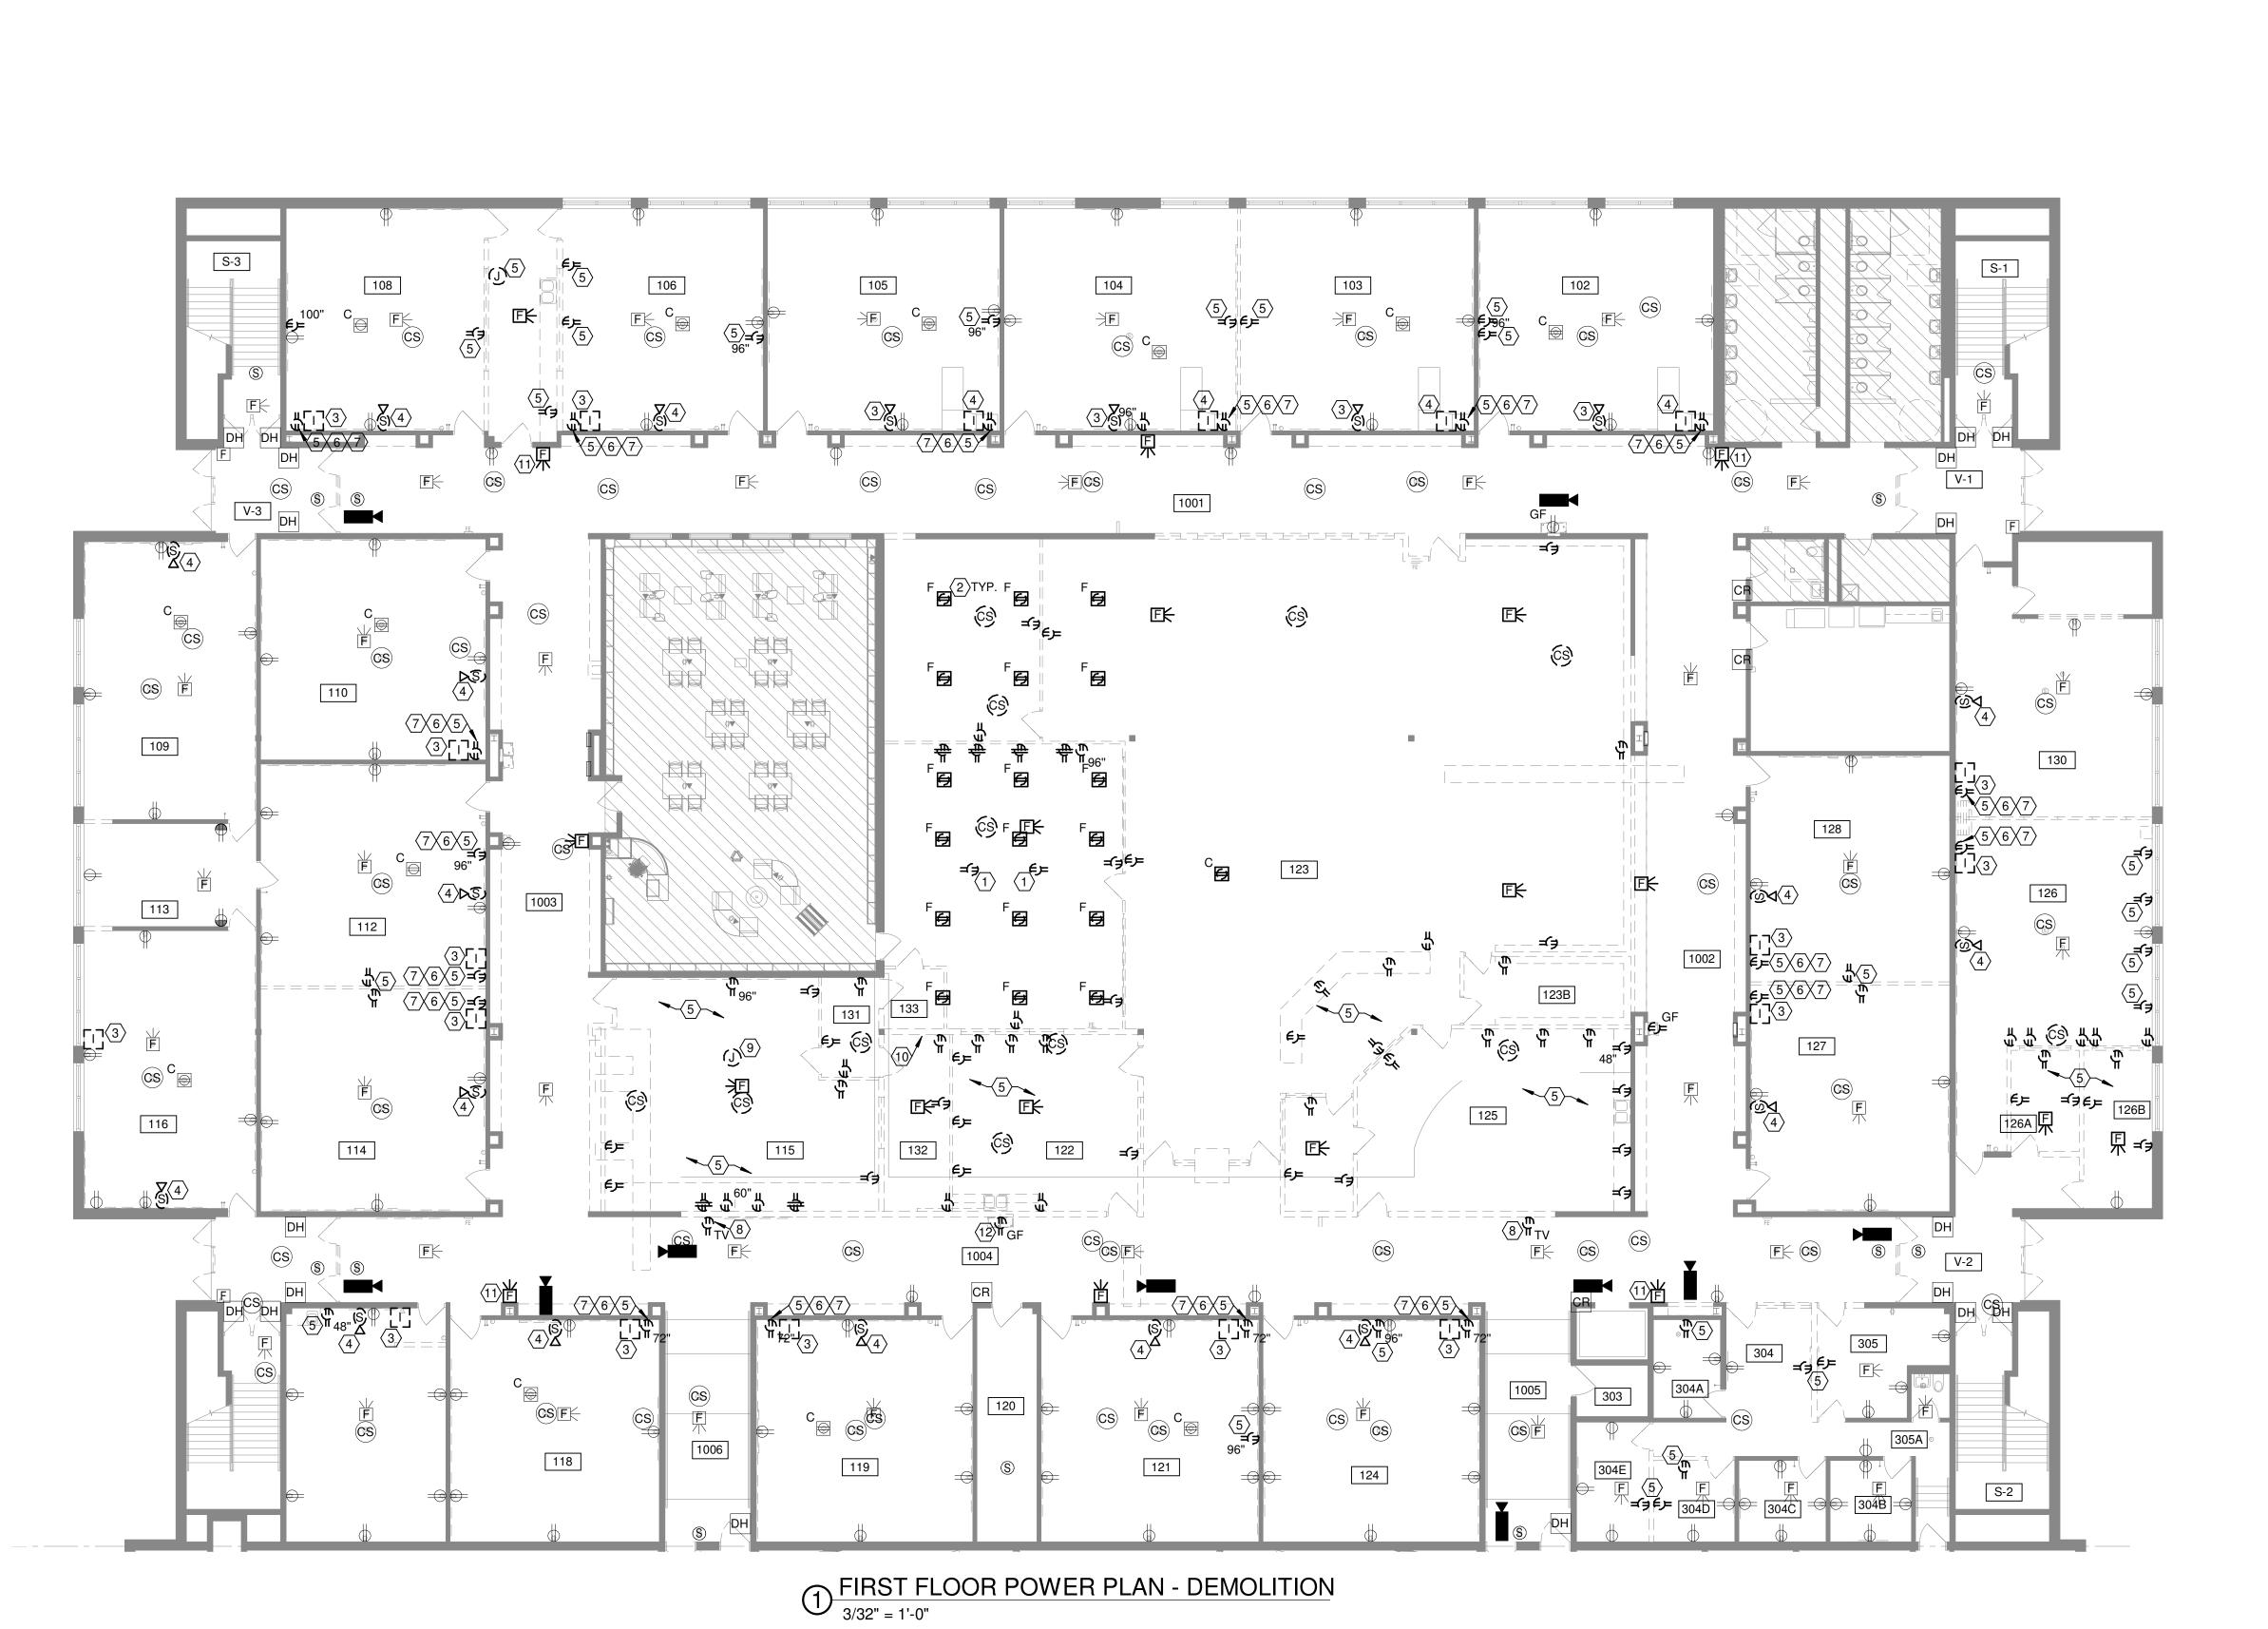
January 24, 2022

Sheet Title

ELECTRICAL EQUIPMENT AND LIGHTING SCHEDULE

Sheet Number


EO.02



- POWER POLES ARE TO BE REMOVED.
- REMOVE EXISTING FLOOR BOX. RESTORE CONCRETE FLOOR TO LIKE NEW CONDITION.
- B. REMOVE EXISTING CLOCK/INTERCOM SPEAKER. PULL WIRES BACK AND RECONNECT TO CEILING SPEAKER TO COMPLETE INTERCOM SYSTEM.
- 4. REMOVE EXISTING INTERCOM CALL BUTTON. PULL WIRES BACK AND RECONNECT TO NEW INTERCOM CALL BUTTON TO COMPLETE INTERCOM SYSTEM. REFER TO NEW WORK FOR NEW LOCATION OF INTERCOM BUTTON.
- REFER TO GENERAL DEMOLITION NOTES ON SHEET E0.01 FOR FURTHER INFORMATION. COORDINATE CLOSELY WITH ARCHITECTURAL REPAIR DRAWINGS FOR COMPLETE SCOPE. SURFACE MOUNTED DEVICES AND CONDUIT ARE TO BE REMOVED.
- 6. CONTRACTOR IS TO CAREFULLY PULL BACK ALL LOW VOLTAGE CABLING AND BUNDLE IT ABOVE ACCESSIBLE CEILING IN ORDER TO PROTECT THE CABLE FROM DAMAGE FOR REUSE. ANY CABLES DAMAGED OR CUT DUE TO DEMOLITION WORK WILL BE REPLACED AT CONTRACTORS EXPENSE.
- 7. REMOVE ALL OUTLETS AND LOW VOLTAGE DEVICES AND ALL ASSOCIATED WIRE, CONDUIT, AND BACK BOXES ASSOCIATED WITH TV OUTLETS. ALL LOCATIONS MAY NOT BE SHOWN.
- REMOVE BACK BOX AND CONDUIT TO FACILITATE BLOCK WALL REPAIR.
- 9. BUS PLUG IS TO BE DEMOLISHED AND TAKEN BACK TO PANEL.
- 10. CAPPED CONDUITS ARE TO BE INVESTIGATED AND CUT BACK TO BE FLUSH WITH FLOOR IF EMPTY.
- 11. REMOVE ABANDONED FIRE ALARM DEVICE TO FACILITATE BLOCK REPAIR.
- 12. WATER FOUNTAIN CIRCUIT TO BE EXTENDED TO NEW LOCATION ACROSS THE HALL. REFER TO SHEET E2.02 FOR FURTHER INFORMATION.

GENERAL LIGHTING/POWER NOTES

A. ALL EXISTING AND NEW OUTLETS, LIGHT SWITCHES AND ALL OTHER ELECTRICAL DEVICES SHALL BE REPLACED WITH NEW WHITE DEVICES AND STAINLESS STEEL COVERPLATES. VERIFY EXACT COLOR OF DEVICES WITH ARCHITECT PRIOR TO ORDERING. ALL COVER PLATES SHALL BE OVERSIZED.

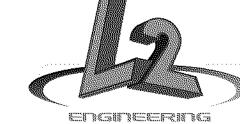

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Date

January 24, 2022

Sheet Title

FIRST FLOOR OVERALL POWER PLAN - DEMO

Sheet Number

E1.01



- REMOVE BACK BOX AND CONDUIT TO FACILITATE BLOCK WALL REPAIR.
- FIXTURES ARE TO BE TAKEN DOWN AND CLEANED FOR RELOCATION INTO NEW RCP. REFER TO NEW WORK SHEETS FOR RELOCATION OF FIXTURES.





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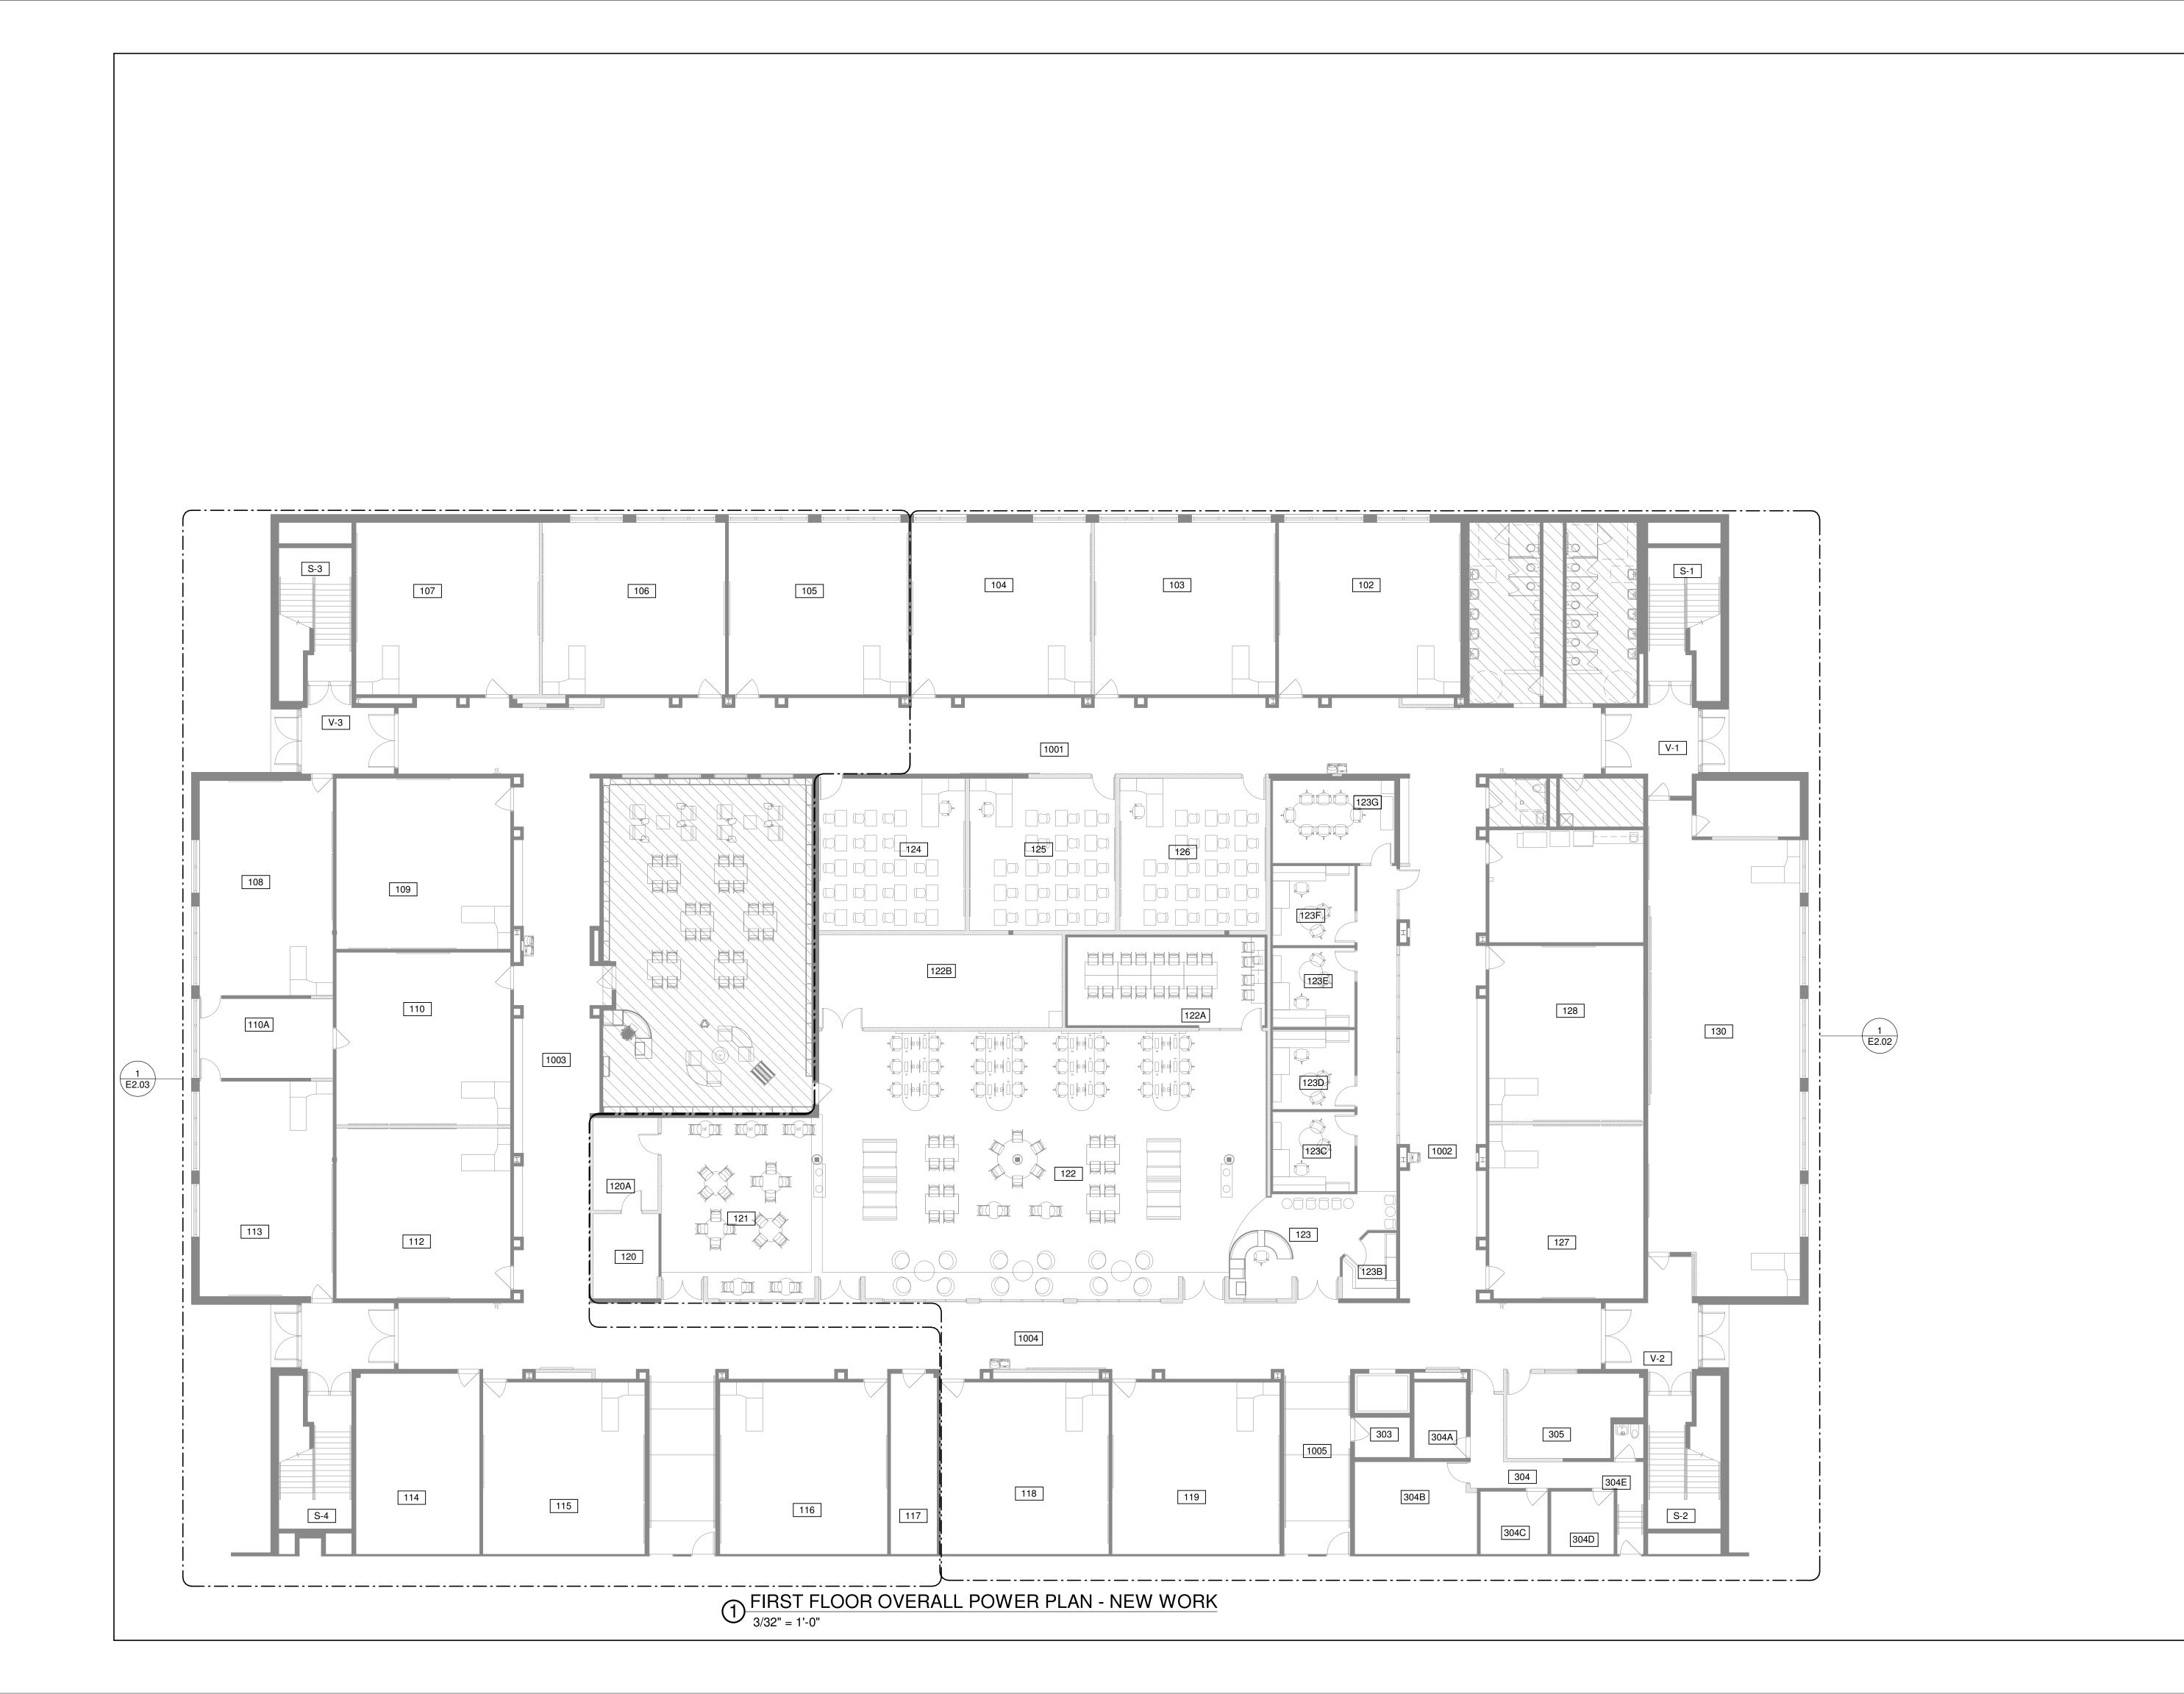
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Sheet Title


FIRST FLOOR OVERALL LIGHTING PLAN - DEMO

Sheet Number

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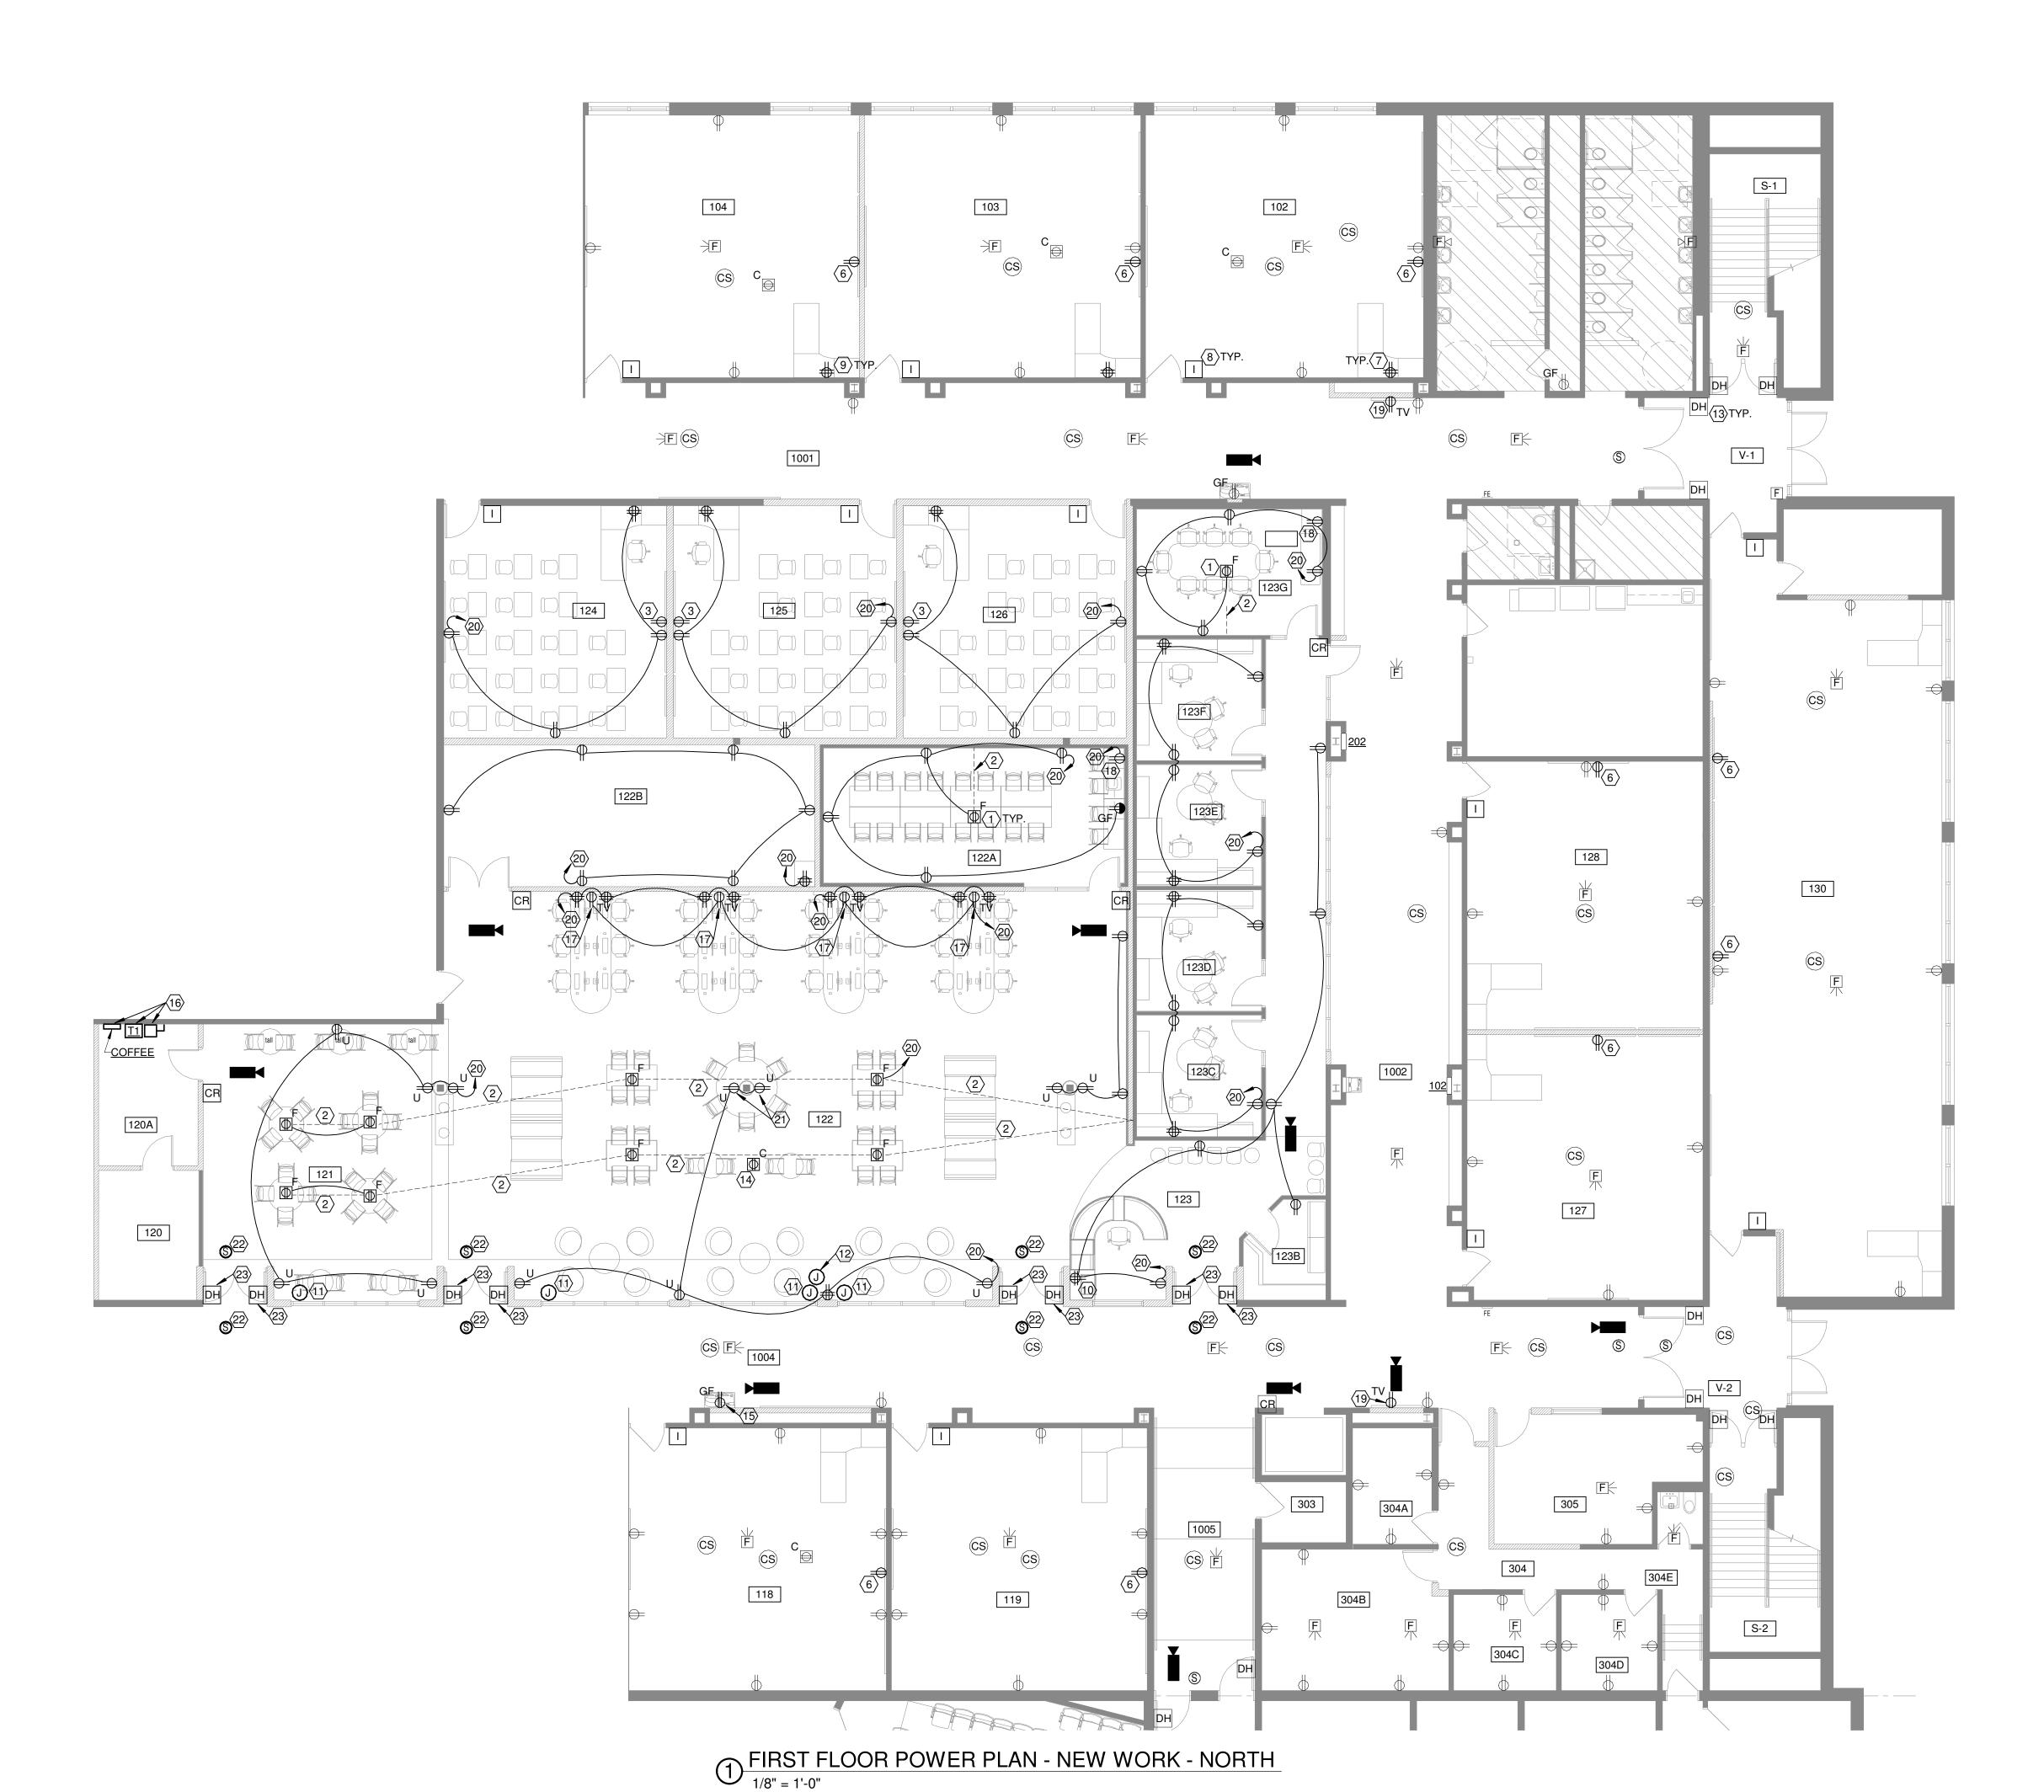
Date

January 24, 2022

Sheet Title
FIRST FLOOR OV

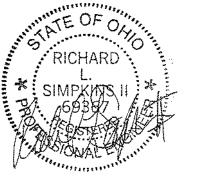FIRST FLOOR OVERALL ELECTRICAL PLAN - NEW WORK

Sheet Number





- . SAW CUT FLOOR FOR NEW FLOOR BOX EQUAL TO HUBBELL MODEL #CFB4G25CR WITH #24GTCVRALUC.
- ROUTE 2-1.5" DATA, 1-1" CONDUIT IN NEW SAW CUT FLOOR TO WALL AND TO ACCESSIBLE CEILING. CONNECT FLOOR OUTLETS TO SPARE 20A/1P RENDERED SPARE FROM DEMOLITION. USB POWER PORTS TO BE PROVIDED BY OWNER.
- PROVIDE CEILING MOUNTED OUTLET FOR OWNER PROVIDED OVERHEAD PROJECTOR. UTILIZE SPARE 20A/1P RENDERED SPARE FROM DEMOLITION
- PROVIDE POWER CONNECTION TO MOTORIZED SCREEN PROVIDED BY OTHERS. PROVIDE WIRING FOR SCREEN CONTROLLER AS REQUIRED. COORDINATE EXACT REQUIREMENTS AT SITE. UTILIZE SPARE 20A/1P RENDERED SPARE FROM DEMOLITION.
- E.C. TO PROVIDE BACK BOX AND CONDUIT TO ABOVE ACCESSIBLE CEILING FOR THERMOSTATS. CONTROL WIRING AND THERMOSTAT PROVIDED BY H.C.
- 6. EXTEND EXISTING CEILING PROJECTOR CIRCUIT TO NEW WALL MOUNTED PROJECTOR LOCATION. VERIFY WIRING DEVICE MOUNTING HEIGHT WITH THE OWNER PRIOR TO ROUGH IN. PROVIDE CONDUIT AND AV CABLES BETWEEN THE PROJECTOR AND THE TEACHERS DESK. AV CABLES SHALL BE (1) CAT5E, (1) CAT6A SHIELDED, (1) HDMI, (1) 3.5MM CABLE. PROVIDE CONDUIT WITH (1) CAT5E BETWEEN THE PROJECTOR AND THE DATA CLOSET.
- 7. CONNECT NEW OUTLETS TO EXISTING OUTLET CIRCUIT IN SPACE. EXISTING OUTLET IS TO HAVE NEW DEVICE AND COVERPLATE.
- 8. NEW INTERCOM EQUIPMENT TO BE PROVIDED BY INTERCOM SUPPLIER. PROVIDE BACK BOX, WIRE, AND CONDUIT AS REQUIRED TO FACILITATE INTERCOM INSTALLATION. RECESS BOX AND CONDUIT INTO EXISTING BLOCK WALL. EC IS RESPONSIBLE FOR CAREFULLY REMOVING AND REINSTALLING, IF NEEDED, ALL INTERCOM DEVICES AND IS SOLELY RESPONSIBLE FOR MAKING SYSTEM OPERATIONAL AFTER WORK IS COMPLETE.
- 9. PROVIDE (3) CAT5E OR BETTER DATA CABLES BETWEEN THE TEACHER'S DESK TO THE NEAREST DATA CLOSET [HOMERUNS]. PROVIDE QUAD ELECTRICAL OUTLET UNDER DESK. CIRCUIT QUAD OUTLET TO THE NEAREST CIRCUIT WITH "SPARE CAPACITY". IF THERE ARE EXISTING DATA CABLES AT THESE LOCATIONS, THEY MAY BE ABLE TO BE MAINTAINED, HOWEVER, THIS WILL BE DETERMINED IN THE FIELD.
- 10. PROVIDE AN AV WALL BOX AT DESK HEIGHT I WALL TO CONNECT TO OVER HEAD PROJECTOR. PROVIDE 2-1.5"C FROM BOX TO ABOVE ACCESSIBLE CEILING FOR A/V CABLING.
- 11. JUNCTION BOX FOR MOTORIZED SHADES. REFER TO ARCHITECTURAL PLANS FOR FINAL SPECIFICATION AND CONTROL REQUIREMENTS. UTILIZE SPARE 20A/1P RENDERED SPARE FROM DEMOLITION.
- 2. PROVIDE POWER CONNECTION TO MOTORIZED SCREEN PROVIDED BY OTHERS. PROVIDE WIRING FOR SCREEN CONTROLLER AS REQUIRED. COORDINATE EXACT REQUIREMENTS AT SITE. UTILIZE SPARE 20A/1P RENDERED SPARE FROM DEMOLITION. COORDINATE EXACT LOCATION OF PROJECTION SCREEN PRIOR TO ROUGH IN.
- 3. DISCONNECT EXISTING MAGNETIC DOOR HOLDS AND REPLACE WITH NEW. COORDINATE WITH ARCHITECTURAL DRAWINGS FOR FURTHER INFORMATION.
- 14. COORDINATE EXACT LOCATION OF PROJECTOR LOCATION PRIOR TO ROUGH IN.
- 15. UTILIZE EXISTING WATER FOUNTAIN CIRCUIT. REFER TO NOTE 12 ON SHEET E1.01 FOR FURTHER INFORMATION.
- 16. 480V TO 120/208V 30KVA TRANSFORMER FOR 100A "COFFEE" PANEL TO BE LOCATED ABOVE CEILING. COORDINATE WITH OTHER TRADES PRIOR TO ROUGH IN SO THERE IS NO CONFLICT. PROVIDE (3) #8 CU, (1) #10 CU IN 1" C. FROM PANEL 101 TO TRANSFORMER. PROVIDE NEW 50A BREAKER IN EXISTING GOULD ITE (10K AIC) PANEL 101. NEW 100A/3P FUSED DISCONNECT FOR PRIMARY SIDE OF TRANSFORMER. UTILIZE SPACES 37, 39, 41 IN EXISTING PANEL 101. PROVIDE (3) #3 CU, (1) #8 CU IN 1.25" C. FROM TRANSFORMER TO NEW PANEL.
- 17. COORDINATE THE MOUNTING HEIGHT OF DISPLAY OUTLETS WITH LATEST ARCHITECTURAL ELEVATIONS.
- 18. PROVIDE A DUPLEX OUTLET AND A DATA BOX WITH A 1" CONDUIT TO ABOVE ACCESSIBLE CEILING FOR BINQ COMPUTER PROVIDED BY OWNER. COORDINATE MOUNTING HEIGHT OF BOXES WITH CASE WORK PROVIDER PRIOR TO ROUGH IN.
- 19. COORDINATE EXACT MOUNTING HEIGHT WITH ARCHITECT AND OWNER PRIOR TO ROUGH IN.
- 20. OUTLETS ARE TO BE CONNECTED TO SPARE 20A/1P RENDERED SPARE FROM DEMOLITION.
- COORDINATEMOUNTING HEIGHT OF RECEPTACLES WITH ARCHITECT PRIOR TO ROUGH IN.
- 22. SMOKE DETECTOR FOR CONTROL OF MAGNETIC DOOR HOLD OPEN DEVICE. SMOKE DETECTOR SHALL RELEASE DOORS WHEN ACTIVATED. SMOKE DETECTORS TO BE CONNECTED TO EXISTING FIRE ALARM SYSTEM. FIRE ALARM PERMIT DRAWING ARE TO BE PROVIDED BY MANUFACTURER.
- 23. MAGNETIC HOLD OPEN DEVICES PROVIDED BY OTHERS. COORDINATE WITH DOOR HARDWARE PROVIDER. MAGNETIC HOLD OPEN IS TO BE TIED TO EXISTING FIRE ALARM. PROVIDE LOW VOLTAGE WIRING, CONDUIT, AND POWER AS REQUIRED BY MANUFACTURER.





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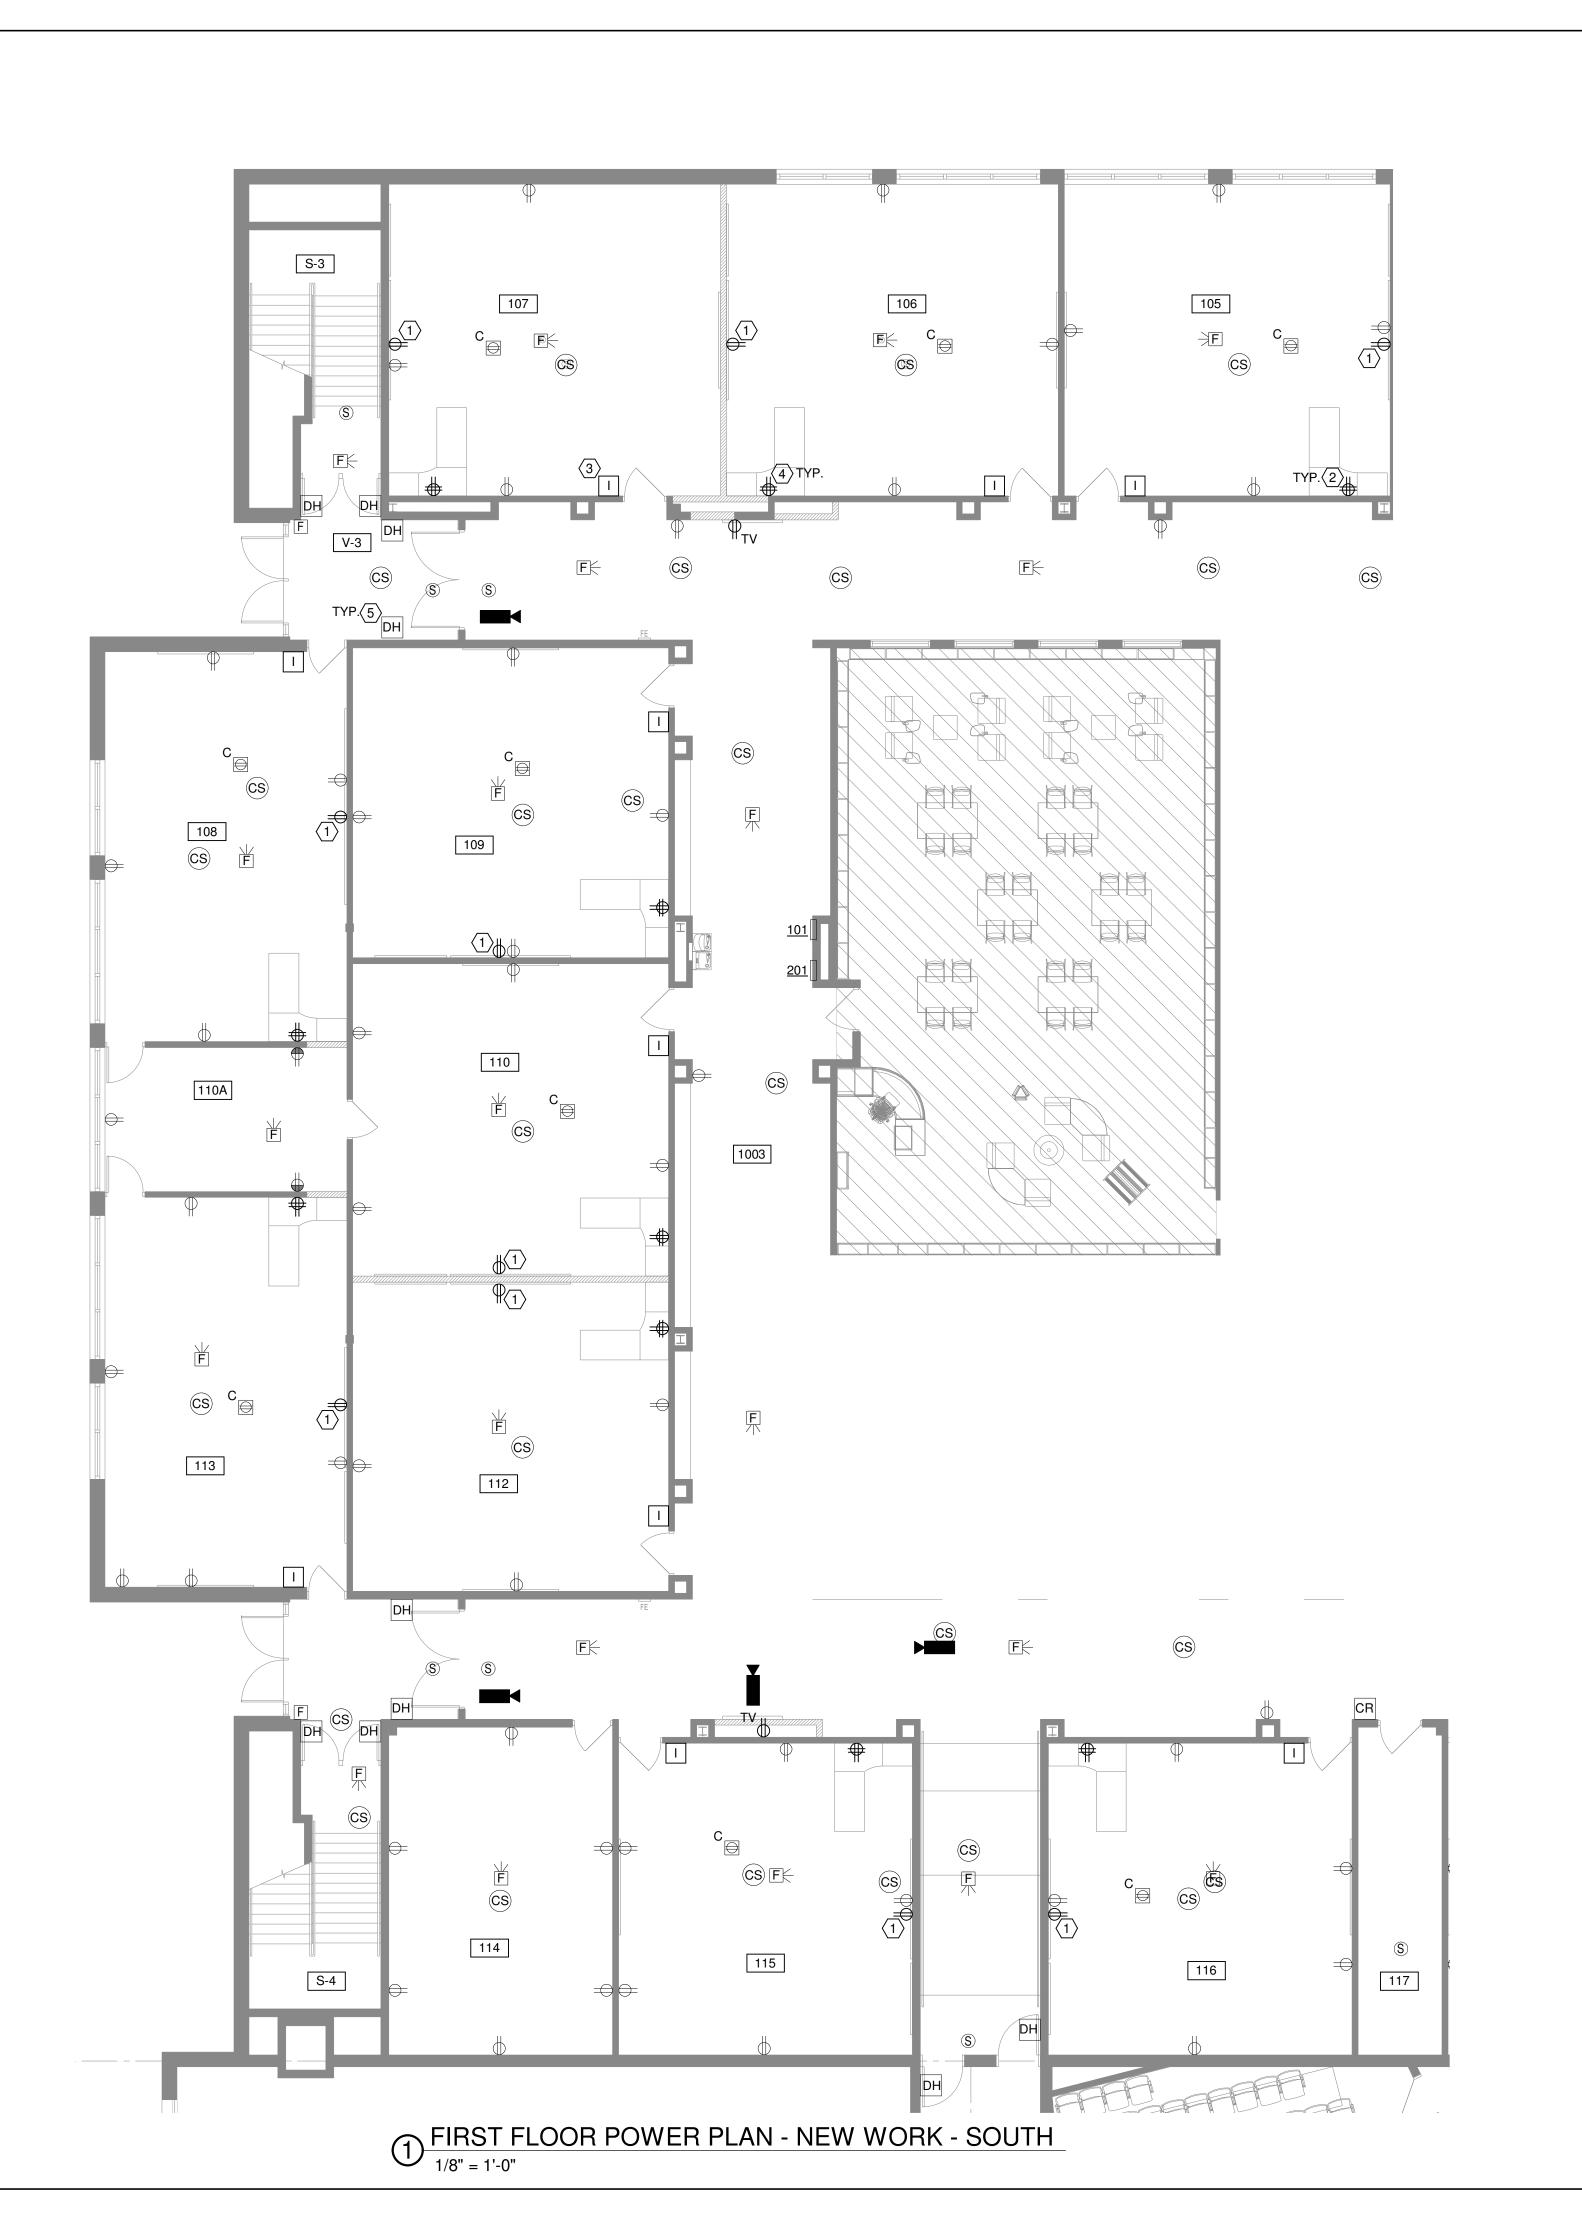
Date

January 24, 2022

Sheet Title

FIRST FLOOR ENLARGED POWER PLAN - NEW WORK

Sheet Number



- EXTEND EXISTING CEILING PROJECTOR CIRCUIT TO NEW WALL MOUNTED PROJECTOR LOCATION. VERIFY WIRING DEVICE MOUNTING HEIGHT WITH THE OWNER PRIOR TO ROUGH IN. PROVIDE CONDUIT AND AV CABLES BETWEEN THE PROJECTOR AND THE TEACHERS DESK. AV CABLES SHALL BE (1) CAT5E, (1) CAT6A SHIELDED, (1) HDMI, (1) 3.5MM CABLE. PROVIDE CONDUIT WITH (1) CAT5E BETWEEN THE PROJECTOR AND THE DATA CLOSET.
- CONNECT NEW OUTLETS TO EXISTING OUTLET CIRCUIT IN SPACE. EXISTING OUTLET IS TO HAVE NEW DEVICE AND COVERPLATE.
- 3. NEW INTERCOM EQUIPMENT TO BE PROVIDED BY INTERCOM SUPPLIER. PROVIDE BACK BOX, WIRE, AND CONDUIT AS REQUIRED TO FACILITATE INTERCOM INSTALLATION. RECESS BOX AND CONDUIT INTO EXISTING BLOCK WALL. EC IS RESPONSIBLE FOR CAREFULLY REMOVING AND REINSTALLING, IF NEEDED, ALL INTERCOM DEVICES AND IS SOLELY RESPONSIBLE FOR MAKING SYSTEM OPERATIONAL AFTER WORK IS COMPLETE.
- PROVIDE (3) CAT5E OR BETTER DATA CABLES BETWEEN THE TEACHER'S DESK TO THE NEAREST DATA CLOSET [HOMERUNS]. PROVIDE QUAD ELECTRICAL OUTLET UNDER DESK. CIRCUIT QUAD OUTLET TO THE NEAREST CIRCUIT WITH "SPARE CAPACITY". IF THERE ARE EXISTING DATA CABLES AT THESE LOCATIONS, THEY MAY BE ABLE TO BE MAINTAINED, HOWEVER, THIS WILL BE DETERMINED IN THE FIELD.
- 5. DISCONNECT EXISTING MAGNETIC DOOR HOLDS AND REPLACE WITH NEW. COORDINATE WITH ARCHITECTURAL DRAWINGS FOR FURTHER INFORMATION.



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GENERAL LIGHTING/POWER NOTES

- A. ALL EXISTING AND NEW OUTLETS, LIGHT SWITCHES AND ALL OTHER ELECTRICAL DEVICES SHALL BE REPLACED WITH NEW WHITE DEVICES AND STAINLESS STEEL COVERPLATES. VERIFY EXACT COLOR OF DEVICES WITH ARCHITECT PRIOR TO ORDERING. ALL COVER PLATES
- B. ALL LOW VOLTAGE WORK INCLUDING AV, DATA, INTERCOM ARE BY OTHERS.

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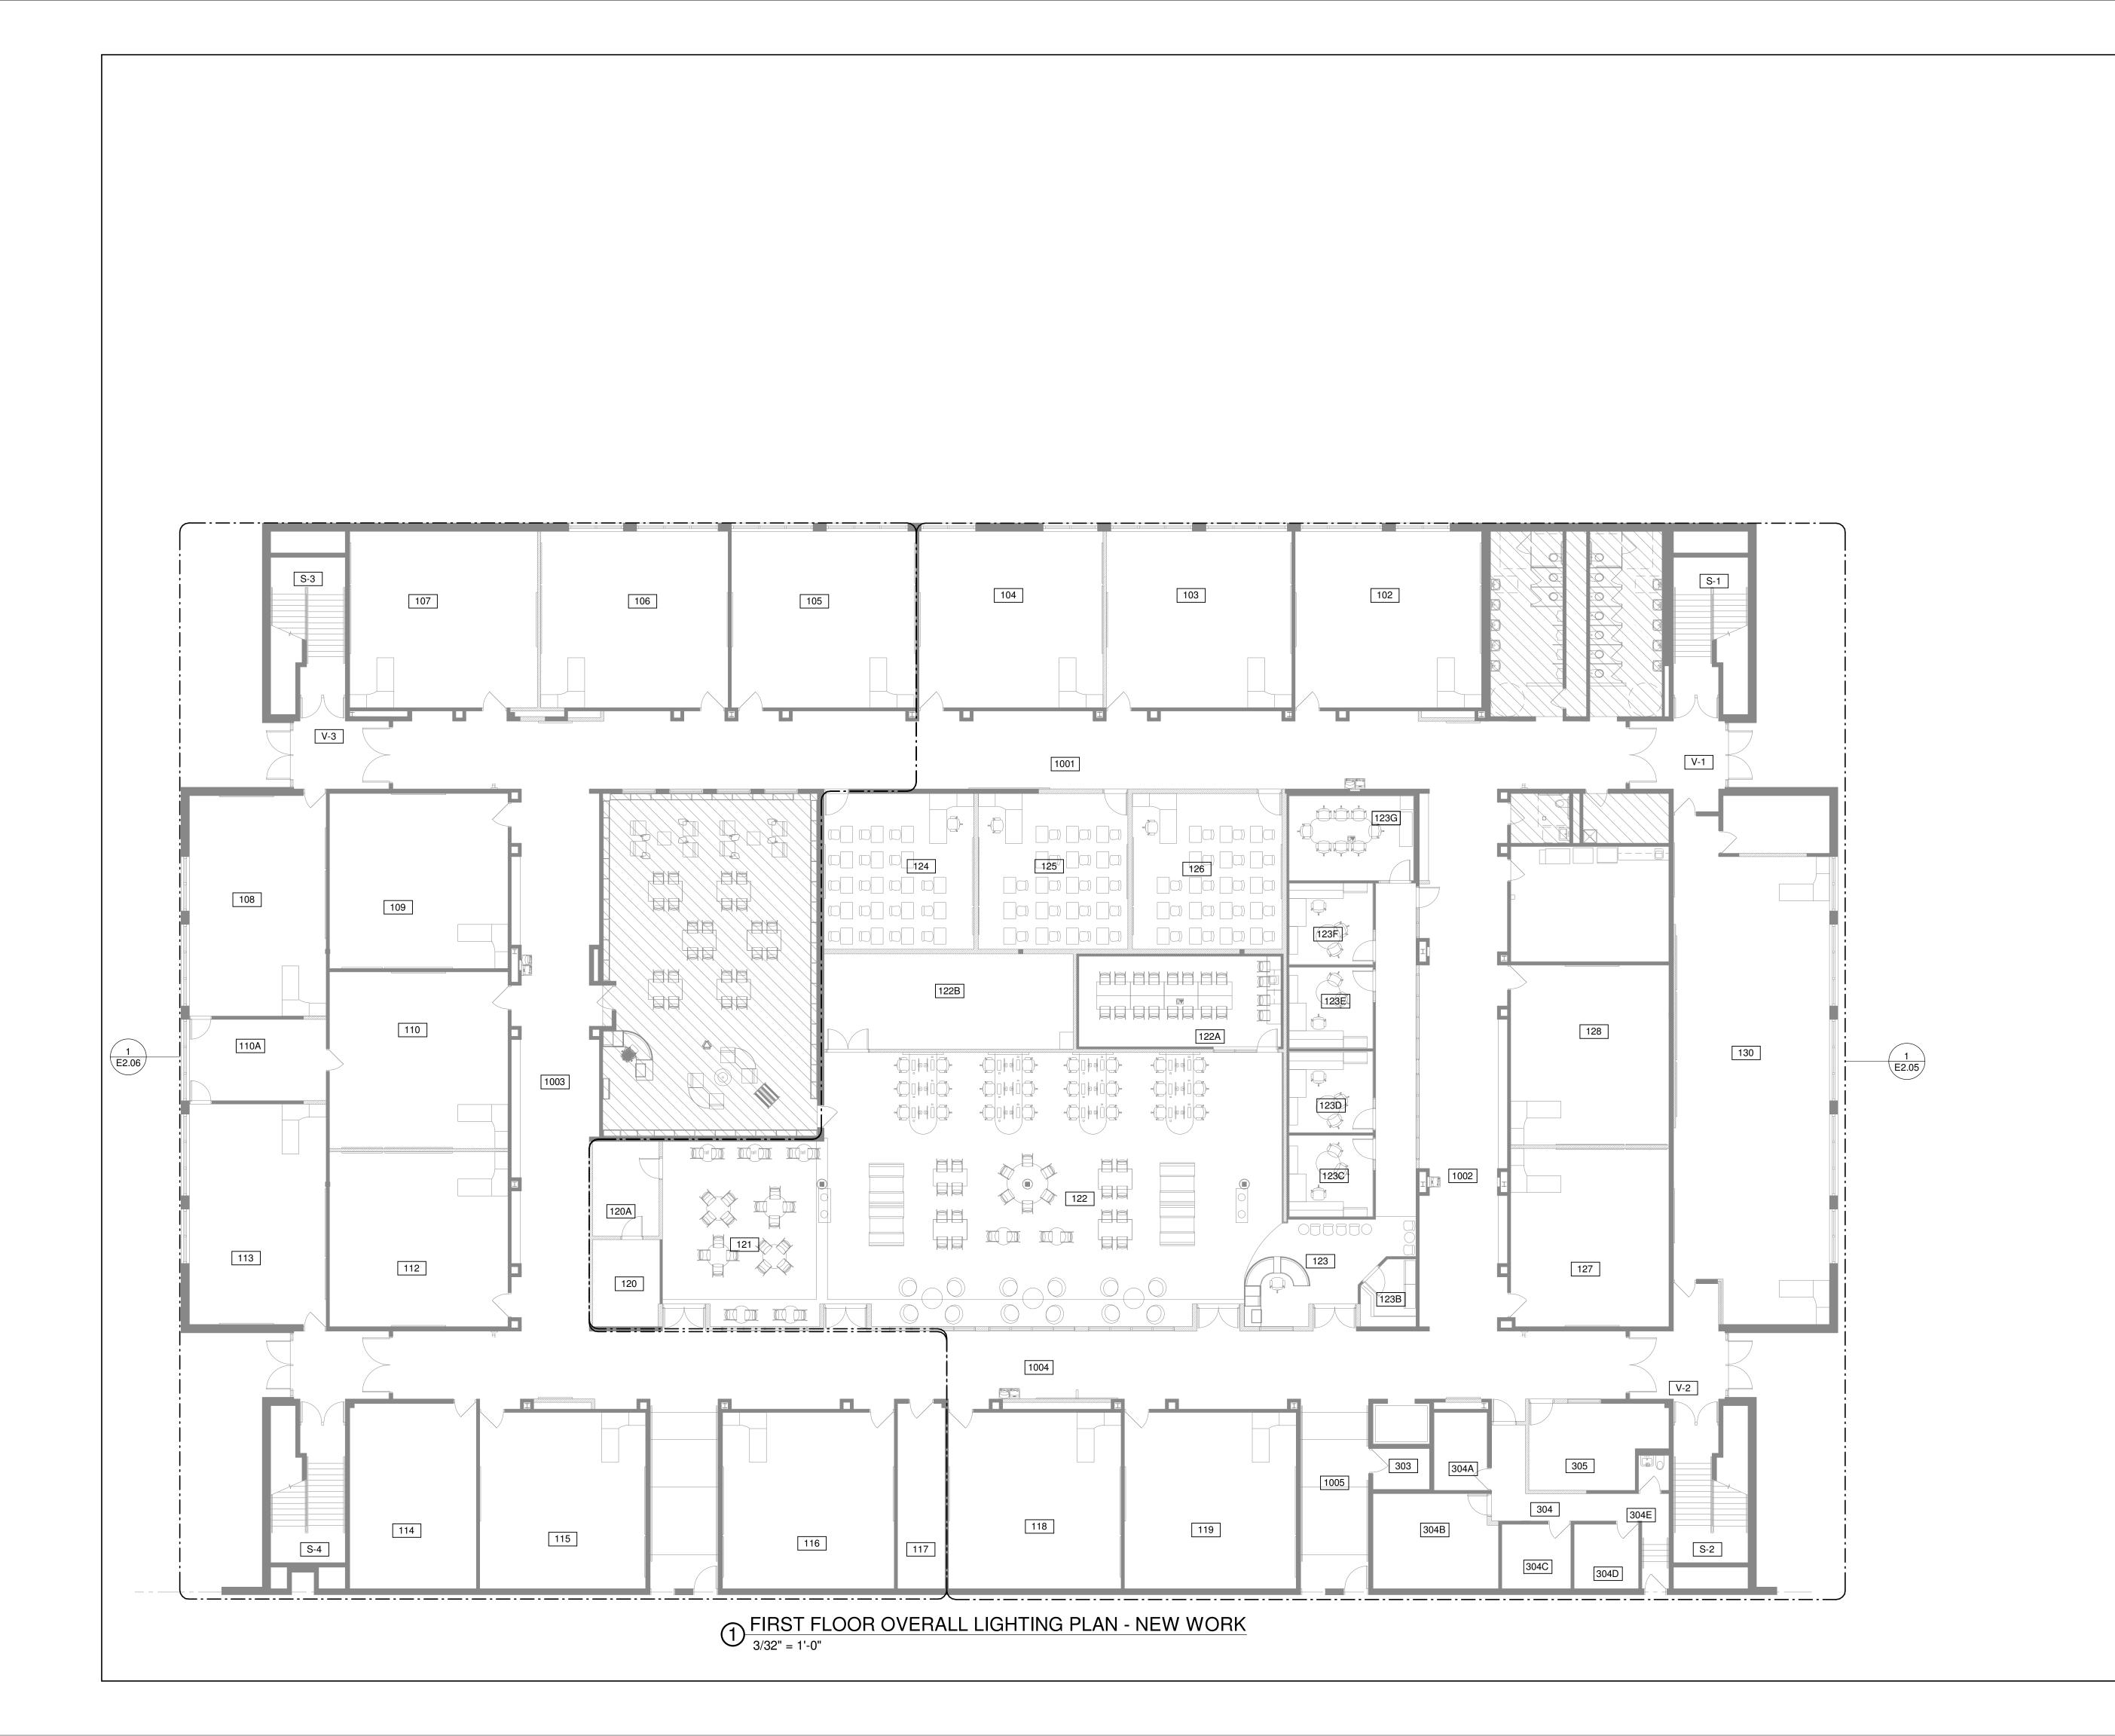
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FIRST FLOOR ENLARGED POWER PLAN - NEW WORK

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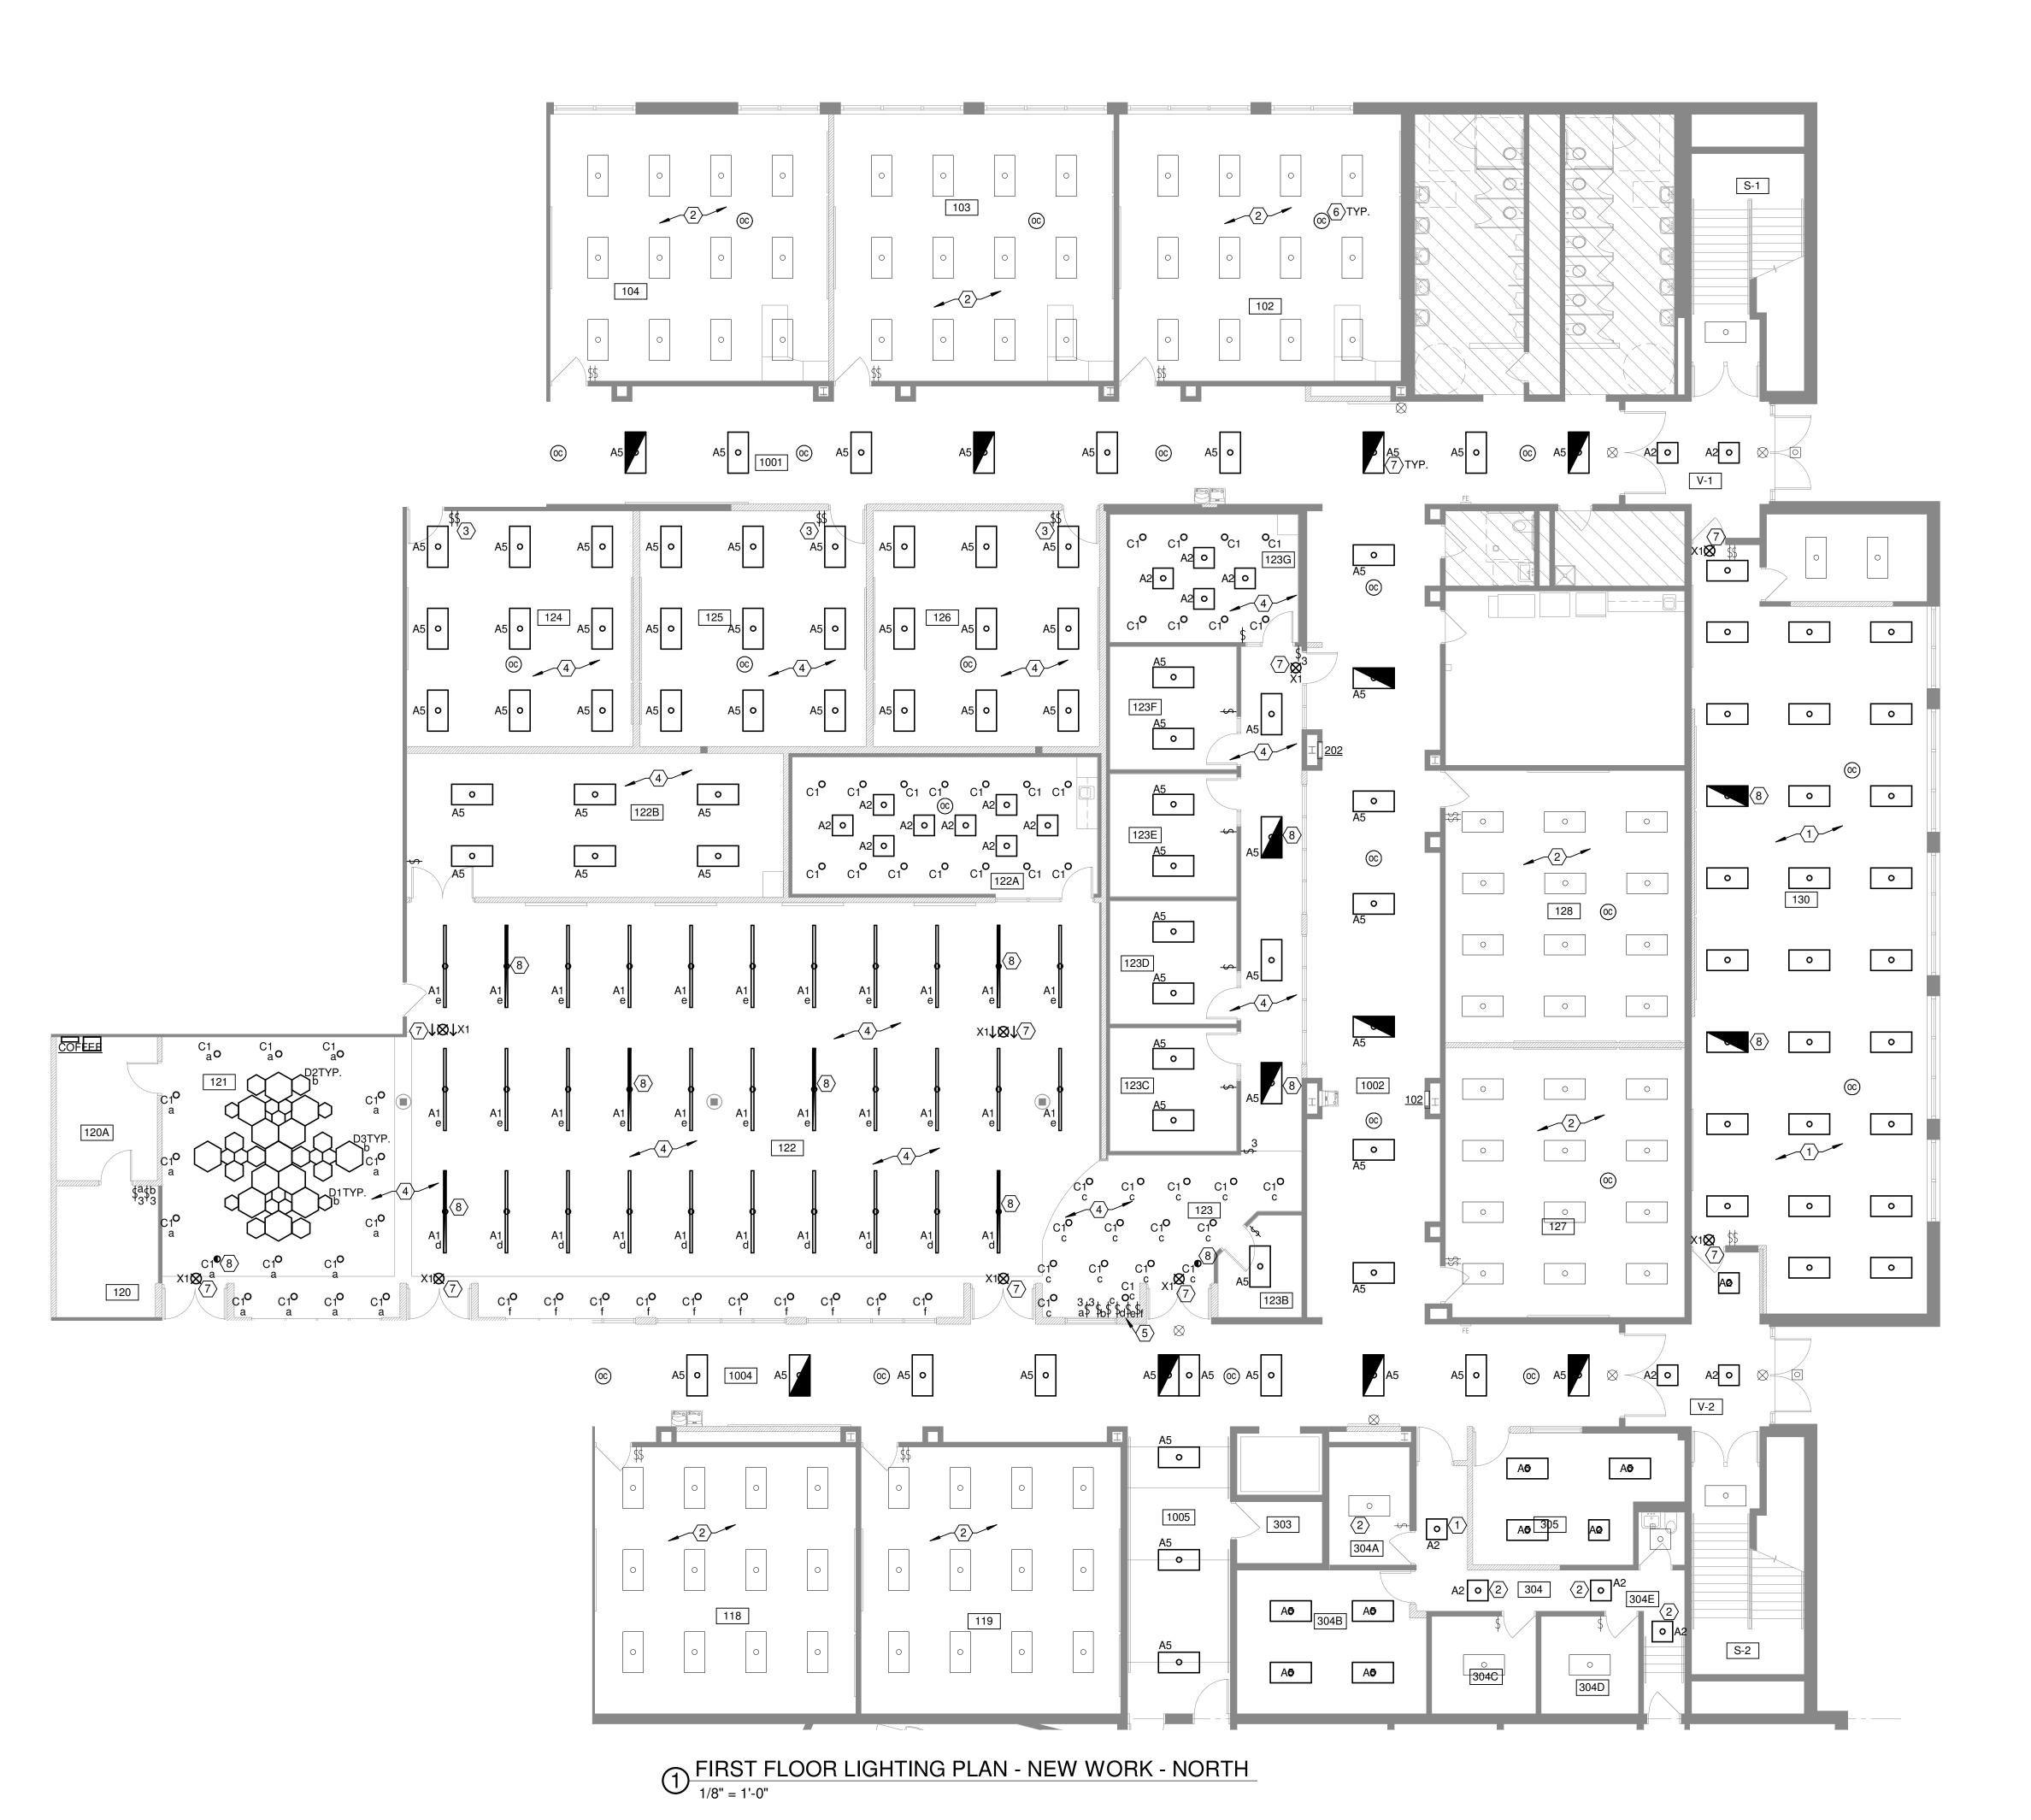
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Sheet Title

FIRST FLOOR OVERALL LIGHTING PLAN - NEW WORK

Sheet Number





- FIXTURES ARE TO BE RELOCATED INTO NEW RCP.
- ALL EXISTING LIGHTING FIXTURES ARE TO BE TAKEN DOWN AND CLEANED. REPLACE LENSES WITH SLP LIGHTING MODEL #FRL. MAINTAIN EXISTING CONTROLS.
- 3. LIGHTING CONTROL FROM SWITCH IS TO CONTROL THE ROW OF LIGHTS CLOSEST TO THE PROJECTOR AT THE FRONT OF THE CLASSROOM. THE REST OF THE LIGHTING IN THE CLASSROOM IS CONTROLLED FROM OTHER SWITCH. ALL SWITCHING IS TO BE CLOSELY COORDINATED WITH REPRESENTATIVE PRIOR TO WIRING SWITCHING TO LIGHTS.
- NEW FIXTURES ARE TO USE LIGHTING CIRCUIT RENDERED SPARE FROM DEMOLITION.
- SWITCHING IN THE STUDENT UNION IS TO BE DIMMABLE. STACK SWITCHES ON DRYWALL AS NEEDED.
- PROVIDE NEW LIGHTING CONTROL DEVICES PER NOTE #11 ON SHEET E0.01 UNDER "GENERAL LIGHTING/POWER NOTES". THE INTENT IS TO REPLACE BATTERY POWERED OCCUPANCY SENSORS WITH HARDWIRED DEVICES
- CONNECT TO EXISTING EMERGENCY CIRCUIT.
- 8. PROVIDE BODINE GTD20A SWITCH BYPASS DEVICE FOR 2X4 LIGHTS IN SPACE

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GENERAL LIGHTING/POWER NOTES

A. ALL EXISTING AND NEW OUTLETS, LIGHT SWITCHES AND ALL OTHER ELECTRICAL DEVICES SHALL BE REPLACED WITH NEW WHITE DEVICES AND STAINLESS STEEL COVERPLATES. VERIFY EXACT COLOR OF DEVICES WITH ARCHITECT PRIOR TO ORDERING. ALL COVER PLATES SHALL BE OVERSIZED.

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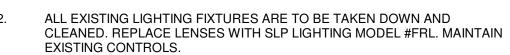
FIRST FLOOR ENLARGED LIGHTING PLAN - NEW WORK

Sheet Number





. FIXTURES ARE TO BE RELOCATED INTO NEW RCP.



3. PROVIDE NEW LIGHTING CONTROL DEVICES PER NOTE #11 ON SHEET E0.01 UNDER "GENERAL LIGHTING/POWER NOTES". THE INTENT IS TO REPLACE BATTERY POWERED OCCUPANCY SENSORS WITH HARDWIRED DEVICES.

4. CONNECT TO EXISTING EMERGENCY CIRCUIT.





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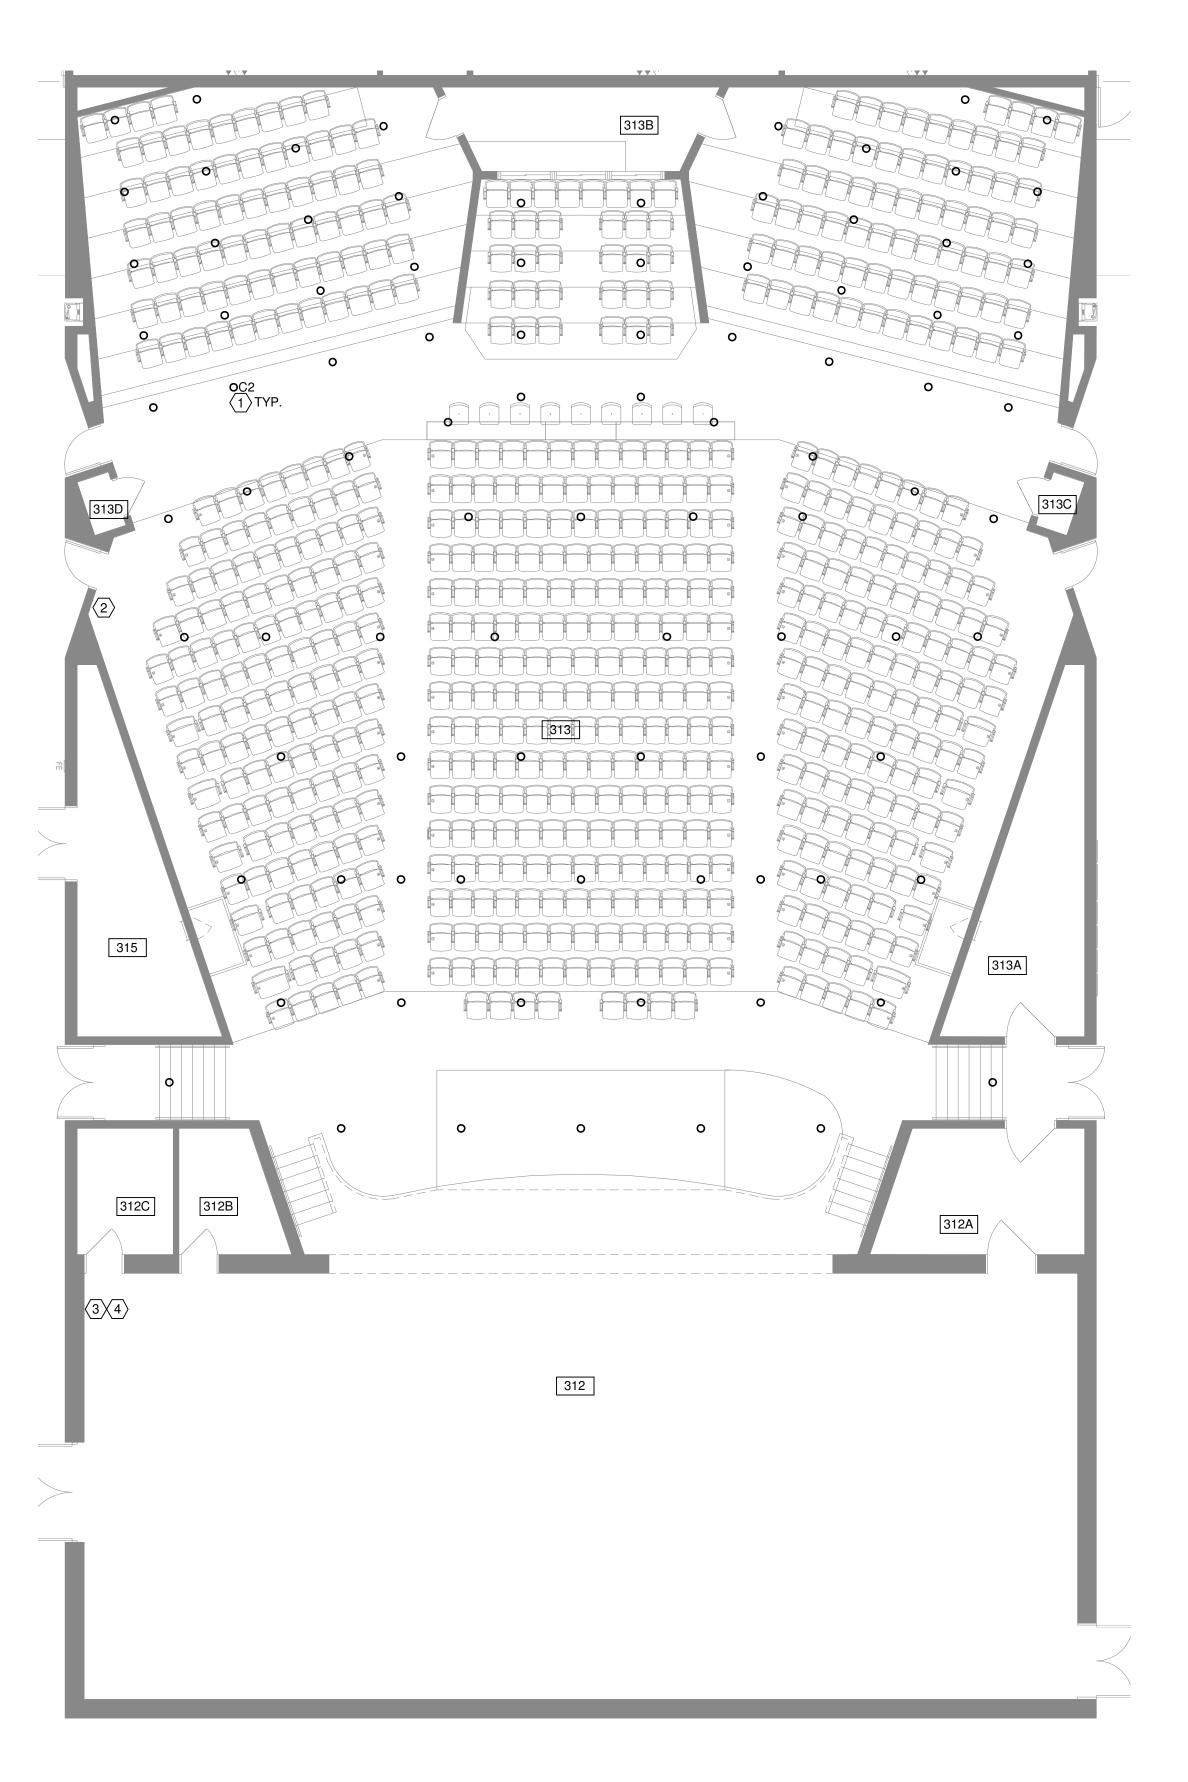
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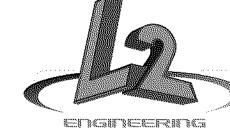
FIRST FLOOR ENLARGED LIGHTING PLAN - NEW WORK

Sheet Number



1 FIRST FLOOR OVERALL LIGHTING PLAN - NEW WORK

- REPLACE EXISTING DIMMABLE LED DOWNLIGHTS IN AUDITORIUM WITH FIXTURE INDICATED. MAINTAIN EXISTING CONTROLS. REFER TO LIGHTING FIXTURE SCHEDULE FOR FURTHER INFORMATION. FIXTURE COLOR TEMPERATURE TO BE COORDINATED WITH OWNER PRIOR TO ORDERING. VERIFY THE EXISTING FIXTURES ARE 6" DIAMETER FIXTURES PRIOR TO ORDERING.
- PROVIDE UP TO 6 CLEAR PLASTIC COVERS FOR EXISTING LIGHTING CONTROL TO PREVENT INADVERTENT ACTIVATION.
- REPLACE ALL EXISTING THEATRICAL LIGHTING CONTROLS WITH NEW LEHIGH SYSTEM. REMOVE EXISTING CONTROL SYSTEM IN IT'S ENTIRETY. EXISTING CONTROLS HAVE BEEN CONVERTED TO DMX CONTROL DURING A PREVIOUS REMODEL. PROVIDE 48 DIMMERS EACH RATED FOR 2.4KW. EXTEND EXISTING 400A POWER FEED FROM EXISTING DIMMER TO NEW DIMMING SYSTEM. REFER TO DRAWINGS E3.04-E3.10 FOR ADDITIONAL INFORMATION.
- EXPAND EXISTING LEHIGH #DX3-60 TO REPLACE EXISTING THEATRICAL LIGHTING CONTROLS. NEW EQUIPMENT SHALL BE COMPATIBLE TO LEHIGH #CTM612. EXISTING LEHIGH HOUSE DIMMING PANEL AND NEW LEHIGH STAGE DIMMING PANEL SHALL ALL BE CAPABLE OF BEING CONTROLLED THROUGH DMX CONTROL BOARD. PROVIDE NEW MODERN DMX CONTROL BOARD FOR LIGHTING CONTROL. COORDINATE EXACT DMX CONTROL BOARD NEEDS WITH OWNERS THEATRICAL REPRESENTATIVE. PROVIDE A 5 PIN DMX CABLE FROM DIMMERS TO BOOTH IN THEATER. REFER TO DRAWINGS E3.04-E3.10 FOR ADDITIONAL INFORMATION.



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Sheet Title

FIRST FLOOR LIGHTING THEATRE

Sheet Number



1 FIRST FLOOR LIGHTING PLAN - NEW WORK

DRAWING NOTES

PROVIDE BACKUP LIGHTING INVERTER FOR GYMNASIUM LIGHTING. INVERTER SHALL BE SIMILAR TO EVENLITE #LM-2800VA-1P-1A-OA-O6-TA OR EQUAL. PROVIDE (2) #8, (1) #10 GRD. IN .75" C. FROM BREAKER TO INVERTER. ALL GYMNASIUM LIGHTS SHALL BE SERVED FROM INVERTER AND SHALL BE NORMALLY CONTROLLED VIA EXISTING CONTROLS. DURING LOSS OF NORMAL POWER, THE LIGHTS SHALL BE SERVED FROM THE INVERTER. THESE LIGHTS ARE NOT TO BE CONSIDERED PART OF THE EMERGENCY EGRESS/EXIT LIGHTING. EC TO PROVIDE EXISTING FIXTURE INFORMATION TO DETERMINE IF SPECIFIED INVERTER IS ADEQUATE.

2. EXISTING EXIT SIGNS ARE TO BE REPLACE WITH NEW EXIT SIGNS. REUSE EXISTING CIRCUIT. UTILIZE DUAL-LITE PROTECTIVE CAGE MODEL #WGLXE OR EQUAL TO PROTECT NEW EXIT SIGN.



RICHARD SIMPKINS II

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Sheet Title

FIRST FLOOR LIGHTING GYM

Sheet Number



- DISCONNECT EXISTING MAGNETIC DOOR HOLDS AND REPLACE WITH NEW. COORDINATE WITH ARCHITECTURAL DRAWINGS FOR FURTHER INFORMATION.
- MAGNETIC HOLD OPEN DEVICES PROVIDED BY OTHERS. COORDINATE WITH DOOR HARDWARE PROVIDER. MAGNETIC HOLD OPEN IS TO BE TIED TO EXISTING FIRE ALARM. PROVIDE LOW VOLTAGE WIRING, CONDUIT, AND POWER AS REQUIRED BY MANUFACTURER.
- PROVIDE NEW LIGHTING CONTROL DEVICES PER NOTE #11 ON SHEET E0.01 UNDER "GENERAL LIGHTING/POWER NOTES". THE INTENT IS TO REPLACE BATTERY POWERED OCCUPANCY SENSORS WITH HARDWIRED DEVICES.
- LIGHTING CONTROL FROM SWITCH IS TO CONTROL THE ROW OF LIGHTS CLOSEST TO THE FRONT OF THE CLASSROOM. THE REST OF THE LIGHTING IN THE CLASSROOM IS CONTROLLED FROM OTHER SWITCH. ALL SWITCHING IS TO BE CLOSELY COORDINATED WITH REPRESENTATIVE PRIOR TO WIRING SWITCHING TO LIGHTS.
- REMOVE UP TO FOUR BACK BOX AND CONDUIT FOR HALLWAY LIGHTING CONTROL TO FACILITATE BLOCK WALL REPAIR. COORDINATE EXACT LOCATION AND QUANTITY OF WALL SWITCHES AT SITE.



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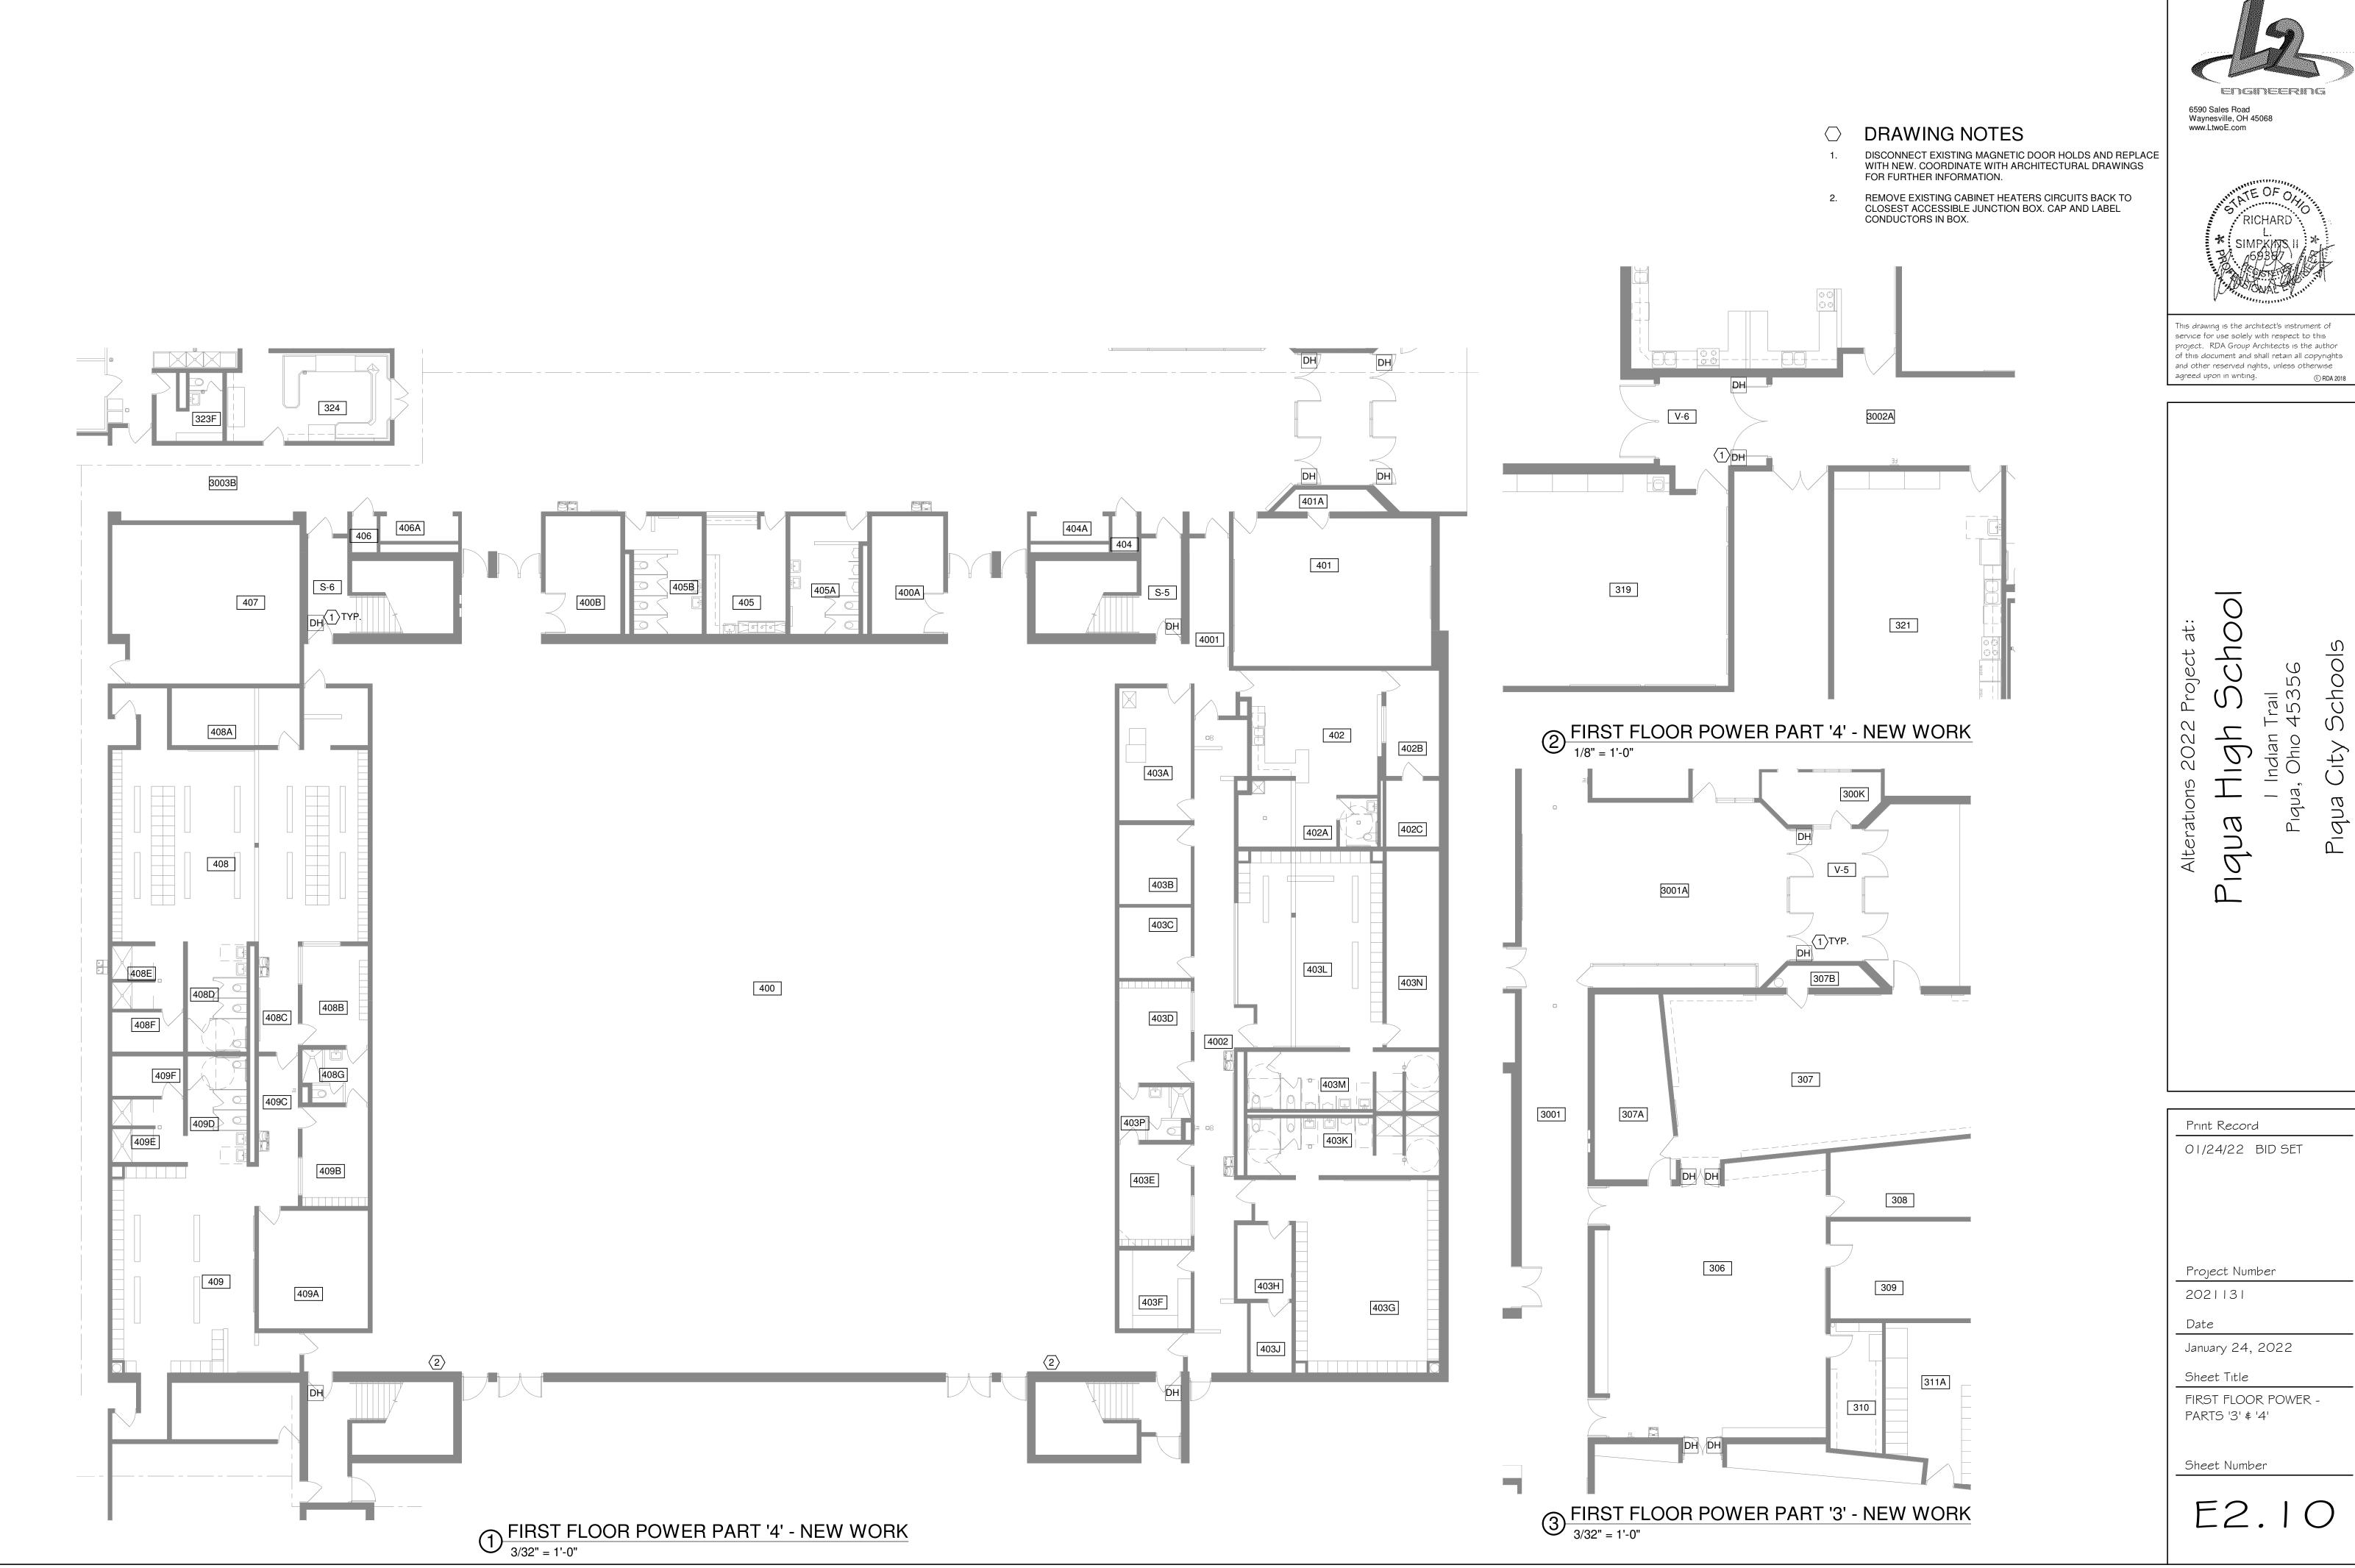
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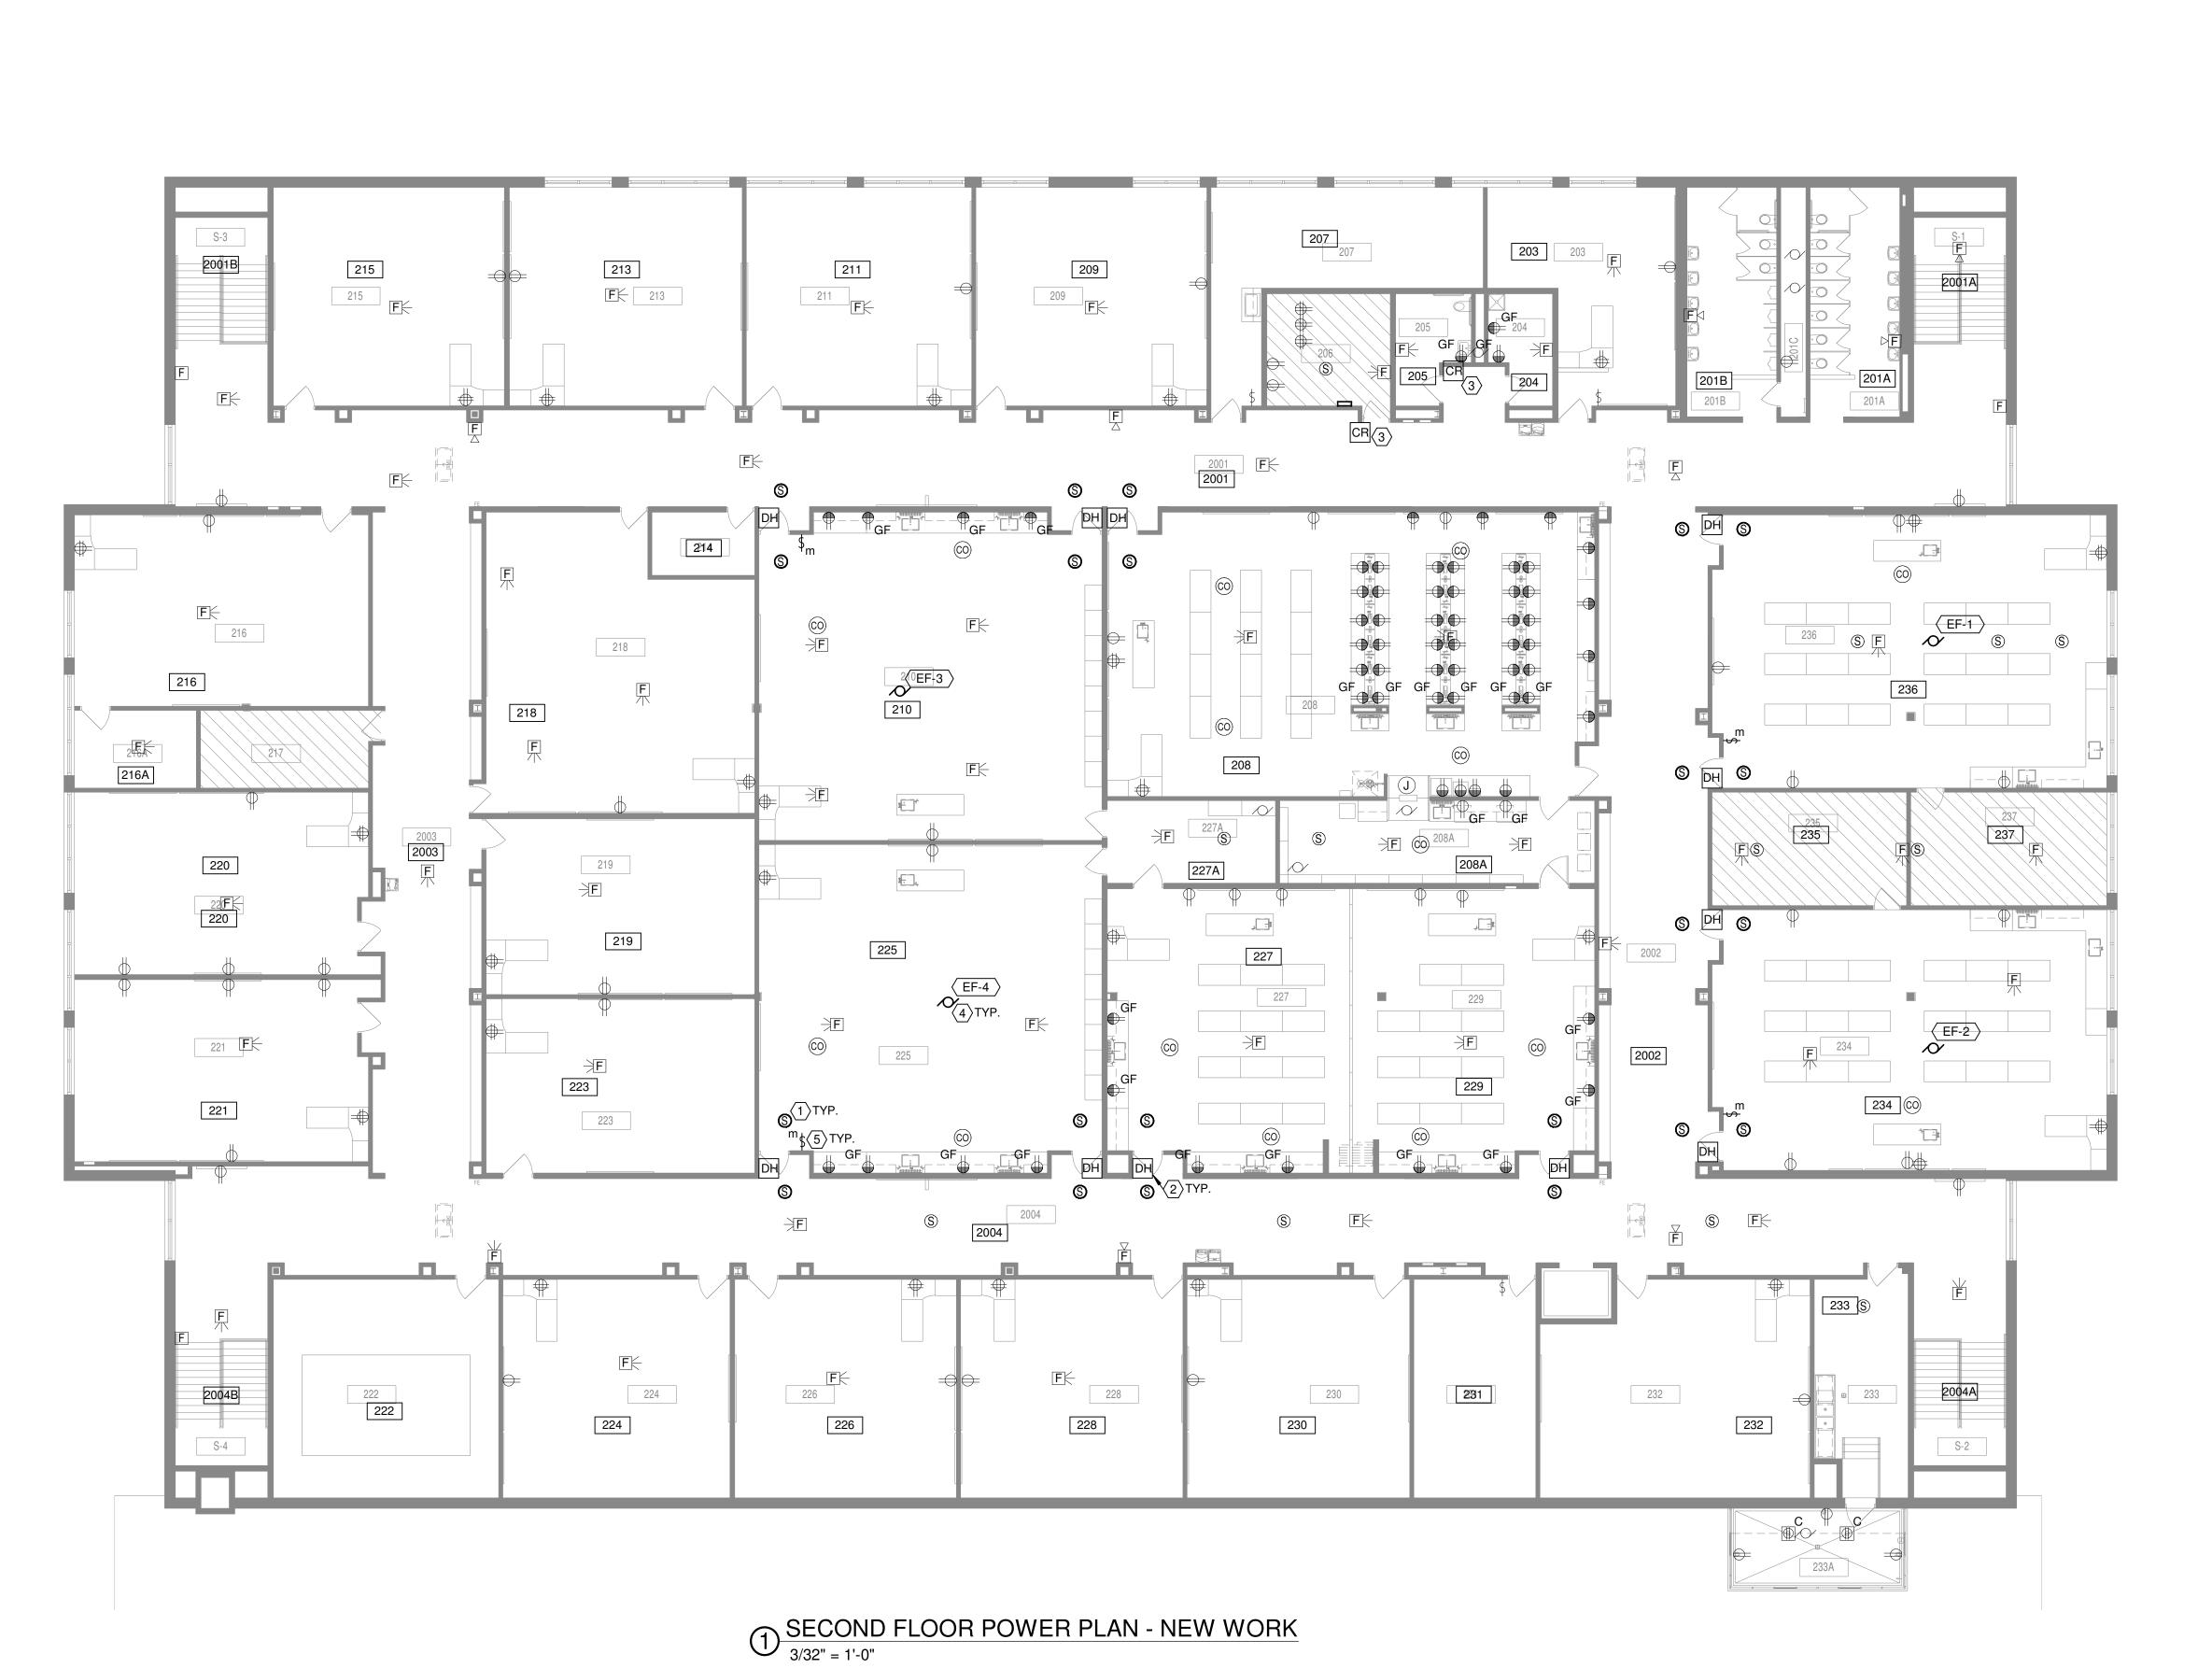
Sheet Title FIRST FLOOR POWER -PART '5'

Sheet Number









- 1. SMOKE DETECTOR FOR CONTROL OF MAGNETIC DOOR HOLD OPEN DEVICE. SMOKE DETECTOR SHALL RELEASE DOORS WHEN ACTIVATED. SMOKE DETECTORS TO BE CONNECTED TO EXISTING FIRE ALARM SYSTEM. FIRE ALARM PERMIT DRAWING ARE TO BE PROVIDED BY MANUFACTURER.
- 2. MAGNETIC HOLD OPEN DEVICES PROVIDED BY OTHERS. COORDINATE WITH DOOR HARDWARE PROVIDER. MAGNETIC HOLD OPEN IS TO BE TIED TO EXISTING FIRE ALARM. PROVIDE LOW VOLTAGE WIRING, CONDUIT, AND POWER AS REQUIRED BY MANUFACTURER.
- 3. PROVIDE JUNCTION FOR CARD READER. CARD PROVIDED BY OTHERS. COORDINATE WITH DOOR HARDWARE MANUFACTURERS.
- 4. COORDINATE EXACT LOCATION OF EXHAUST FAN WITH HVAC DRAWINGS PRIOR TO ROUGH IN. UTILIZE SPARE BREAKER IN CLOSEST PANEL AND VERIFY SPACE. ALL FOUR EXHAUST FANS SHALL BE RAN AS ONE CIRCUIT WITH INDIVIDUAL CONTROL.
- 5. EXHAUST FAN SWITCH LOCATION. PROVIDE INTERMATIC FF SERIES #FF60MC. LABEL SWITCH WITH "ROOM EXHAUST FAN TIMER".



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Sheet Title

SECOND FLOOR OVERALL ELECTRICAL PLAN - NEW WORK

Sheet Number

1. EXISTING EXIT SIGNS ARE TO BE REPLACE WITH NEW EXIT SIGNS. REUSE EXISTING CIRCUIT. UTILIZE DUAL-LITE PROTECTIVE CAGE MODEL #WGLXE OR EQUAL TO PROTECT NEW EXIT SIGN.



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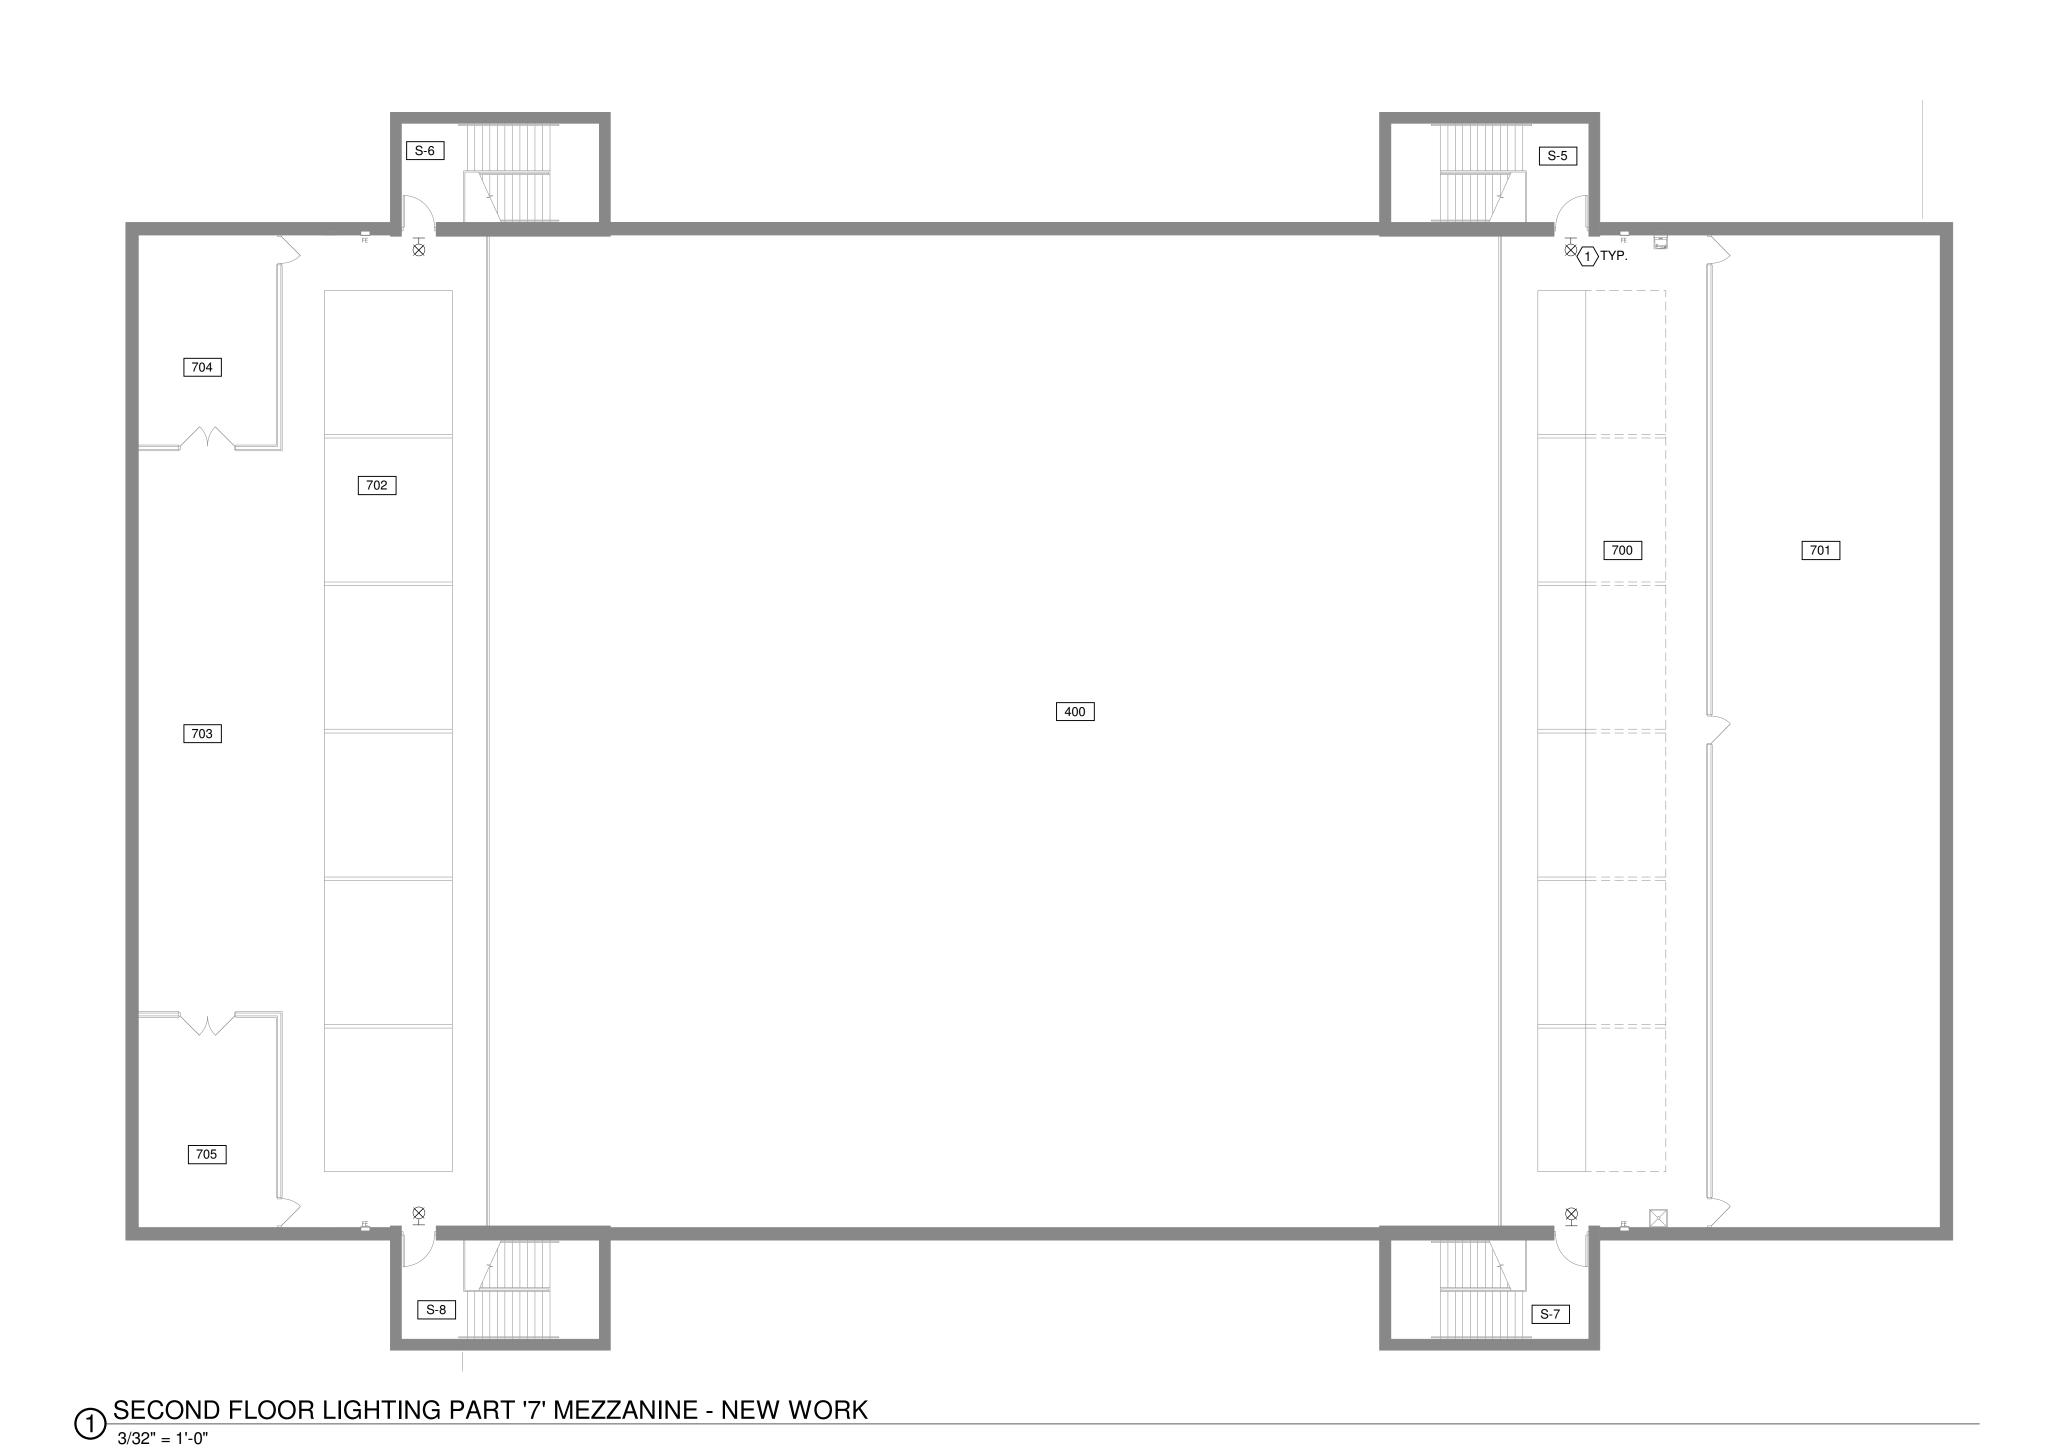
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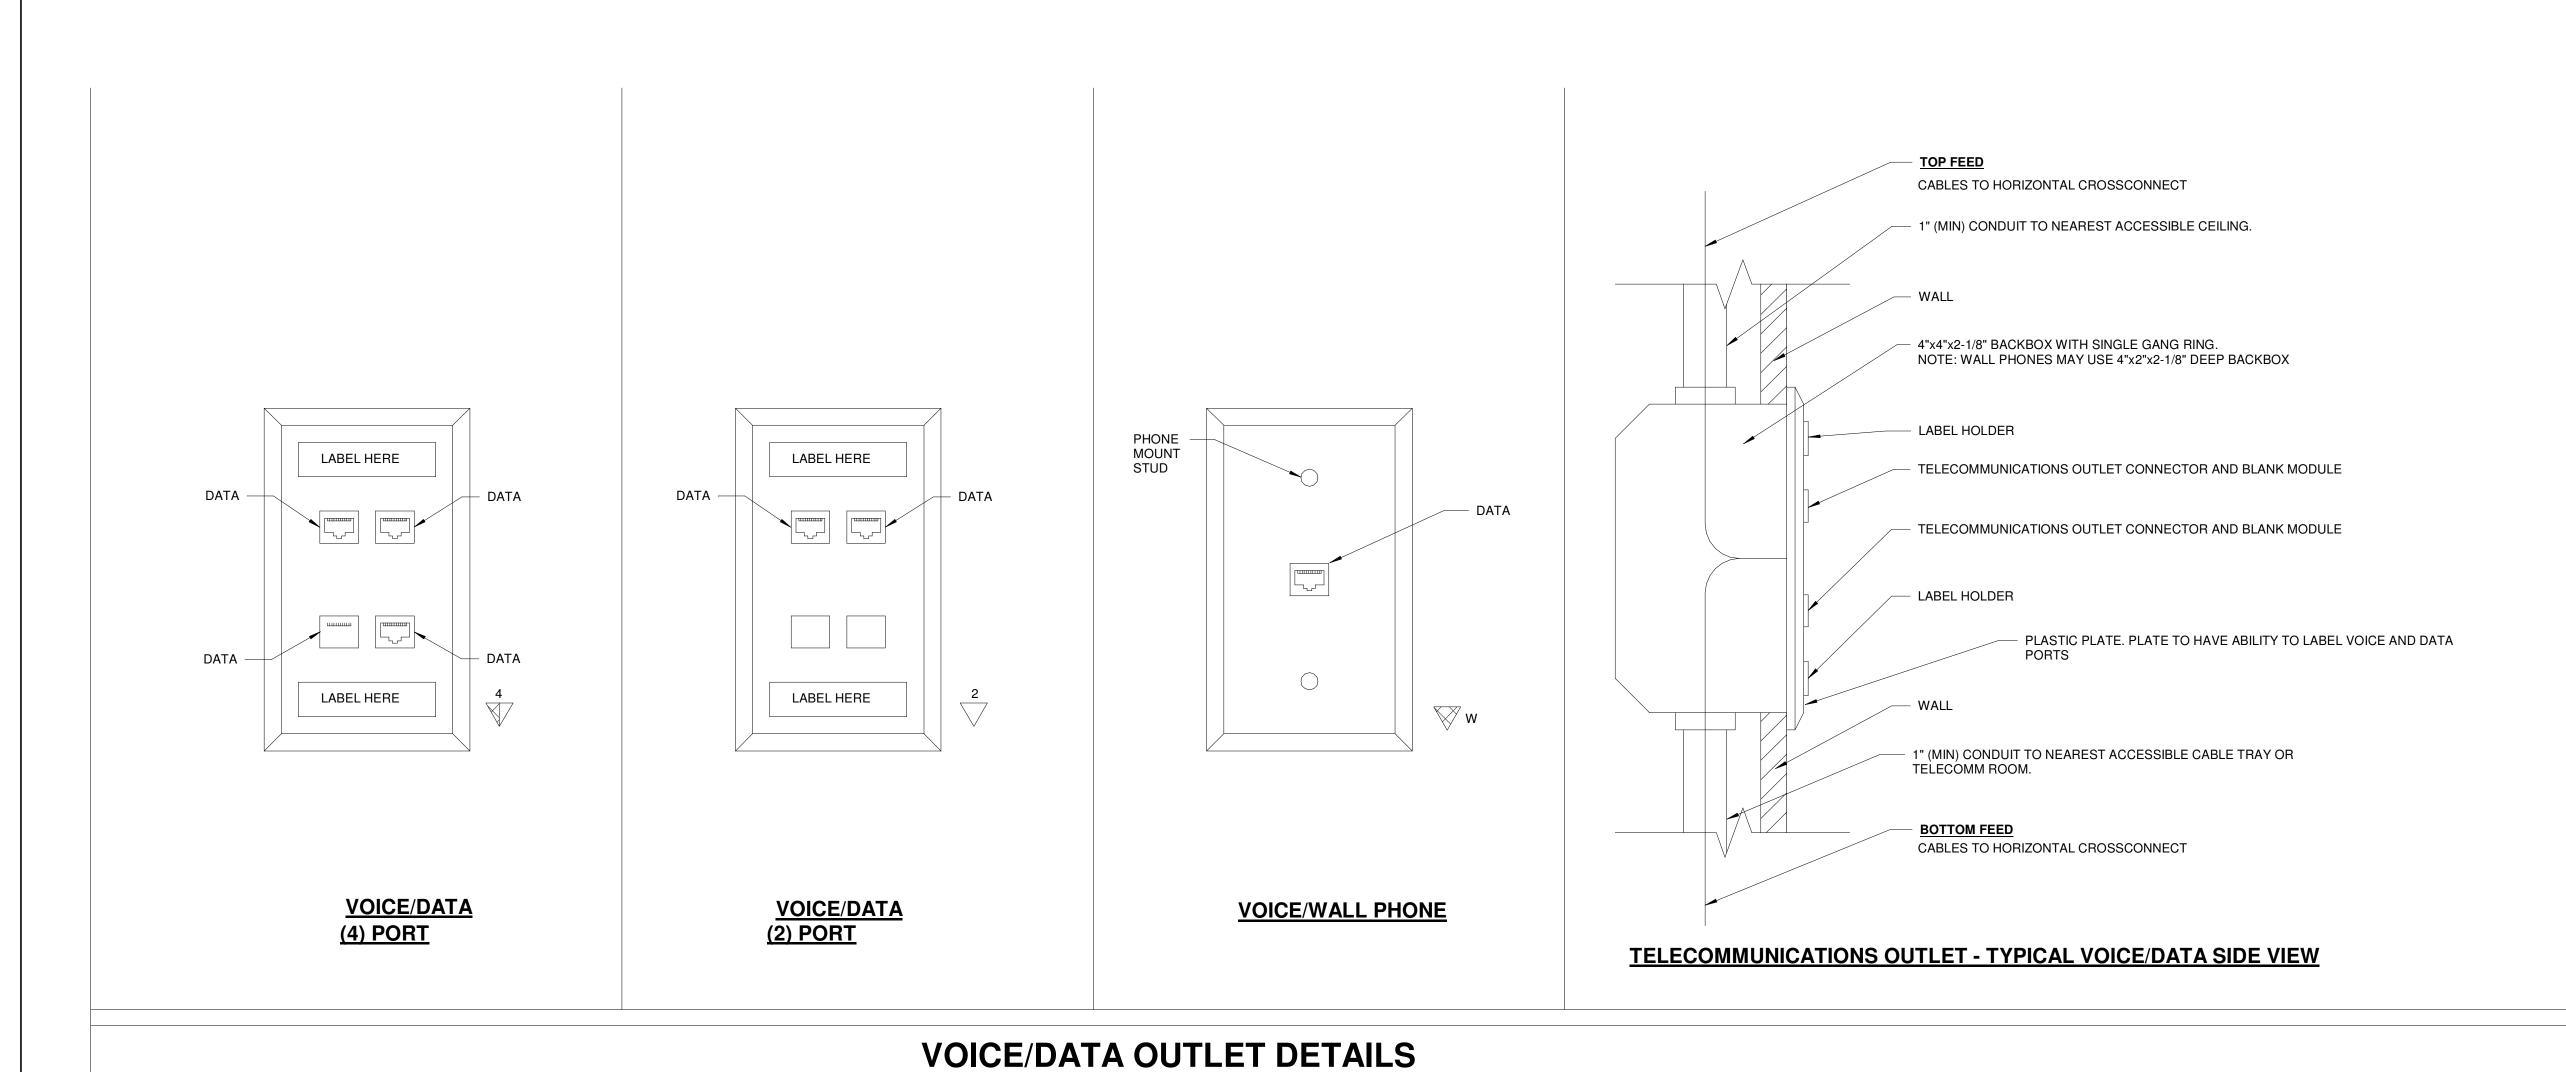
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Sheet Title

SECOND FLOOR LIGHTING 'PART 7'

Sheet Number






3 VOICE/DATA OUTLET DETAILS

1 TYPICAL DEVICE ELEVATION DETAILS

DETAIL NOTES:

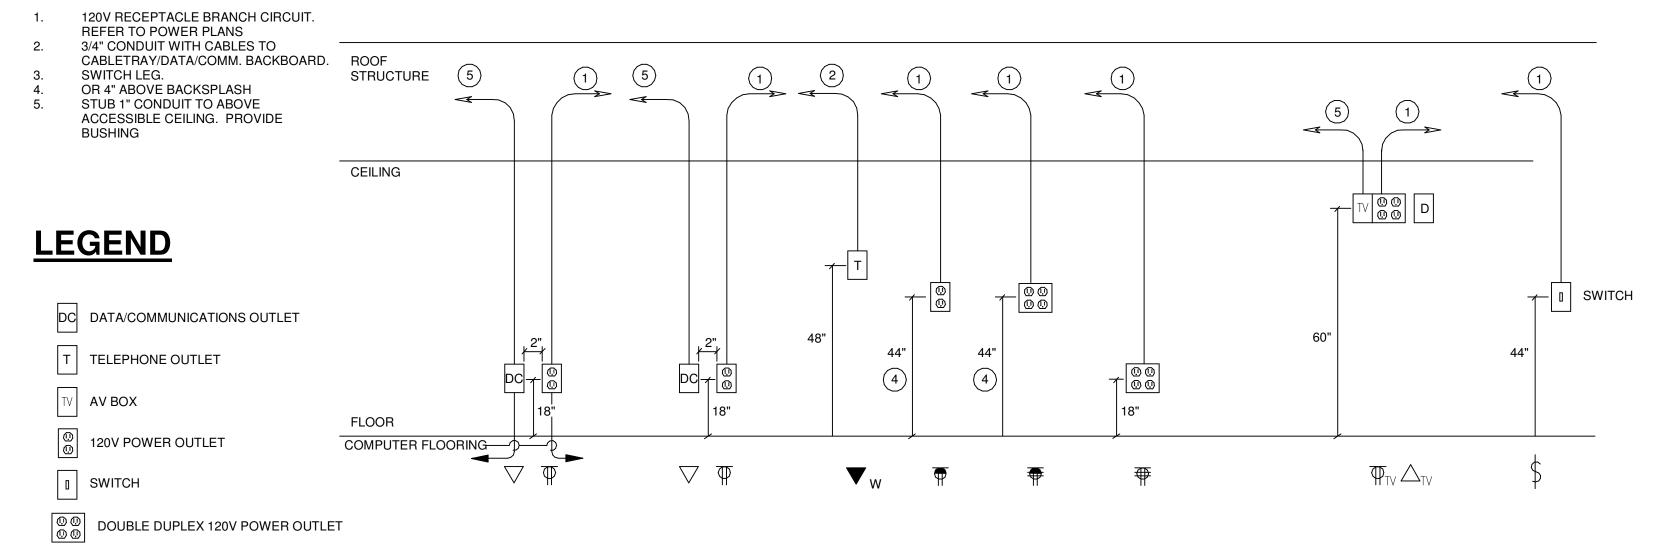

CABLE TRAY
BONDING STRAP (TYP)

6"

WALL

B

PENETRATIONS, REFER TO PLANS

/ J-HOOKS

FOR EXACT NUMBER OF PENETRATIONS

② WALL SLEEVE PENETRATION DETAIL

NTS

- 4" PENETRATIONS FOR (2) 3" CONDUITS 6590 Sales Road Waynesville, OH 45068 www.LtwoE.com



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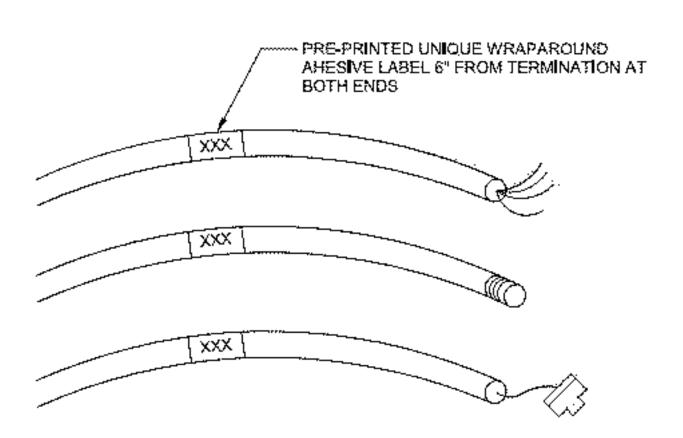
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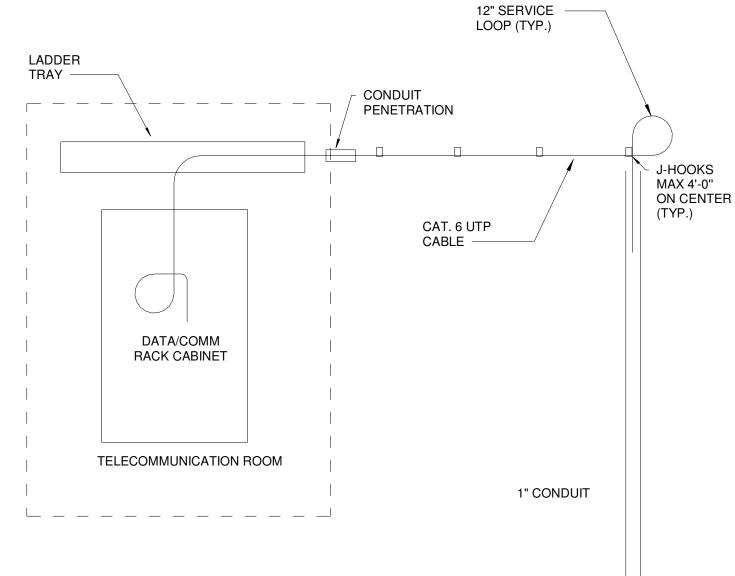
Sheet Title

ELECTRICAL DETAILS

Sheet Number



3 CABLE LABELING



PR3 PR1 PR4

12345678

DATA JACK


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TYPICAL DATA CONNECTION

(VOICE/DATA)

DETAIL NOTES

- VERIFY EXACT QUANITY OF DEVICES FROM THE FLOOR
- LABEL ALL CABLES, CONDUITS, AND DEVICES.
- PROVIDE CONNECTIONS TO DATA/COMM RACK EQUIPMENT. LABEL DEVICES AND TERMINAL POINTS. TEST ALL CABLES.
- REFER TO DRAWINGS FOR REQUIREMENTS.
- REFER TO SPECIFICATIONS FOR REQUIREMENTS.
- PROVIDE 12" LOOP AT USER END AND A LOOP IN THE COMMUNICATION CLOSET CONNECTION LOCATION.
- ENSURE 6" SEPERATION FROM POWER CABLING FOR ALL COMMUNICATION CABLING.
- REAM AND BUSH CONDUIT END AND PROVIDE PLASTIC
- PROVIDE BLANK MODULES WHERE OUTLETS ARE NOT
- PROVIDED.
- PROVIDE BLUE CABLE COLORS FOR ALL DATA DEVICES.
- 11. PLATES SHALL BE WHITE IN COLOR.
- THE MININUM INSIDE BEND RADIUS FOR 4 PAIR BALANCED TWISTED CORD CABLE SHALL BE FOUR TIMES THE CABLE CORD DIAMETER.
- MOUNT DEVICE AT SAME HEIGHT AS ELECTRICAL OUTLETS. REFER TO TO TYPICAL DEVICE ELEVATION DETAIL ON ELECTRICAL DRAWINGS.

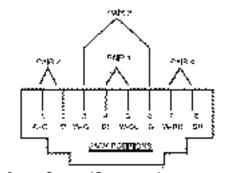


<u>PIN/PAIR ASSIGNMENTS (T568B)</u>

epot on internitional land	COLOR COO	Assertalation
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PMP?	सम्बद्धाः (१) सम्बद्धाः (१)	940: 93
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PAPS 6	AND-MOVIL (1)	r Kuljuko 1954)

DRAWING NOTES:

- (1) перидре учировиц корорик (мурч социясь имерука воя шекаля сидов. $\left(X
 ight)$, white objectively despite the proposition of the proposition of the section $\left(X
 ight)$
- (5) мартильная функцияна, п
- $|\Phi\rangle$ -pseudon ν) if independently, it is the specific potential by a property of partial values Φ
- επισγεία (konzell Artice) γκαι είναι (like) (α αραφακατή γνήτας τεξά (κατεκτ είνητησε σε γκαθητικέθει καταστάσευς κάσε του έσε καθός (like) γ.

4 PIN/PAIR ASSIGNMENTS (T568B) NTS

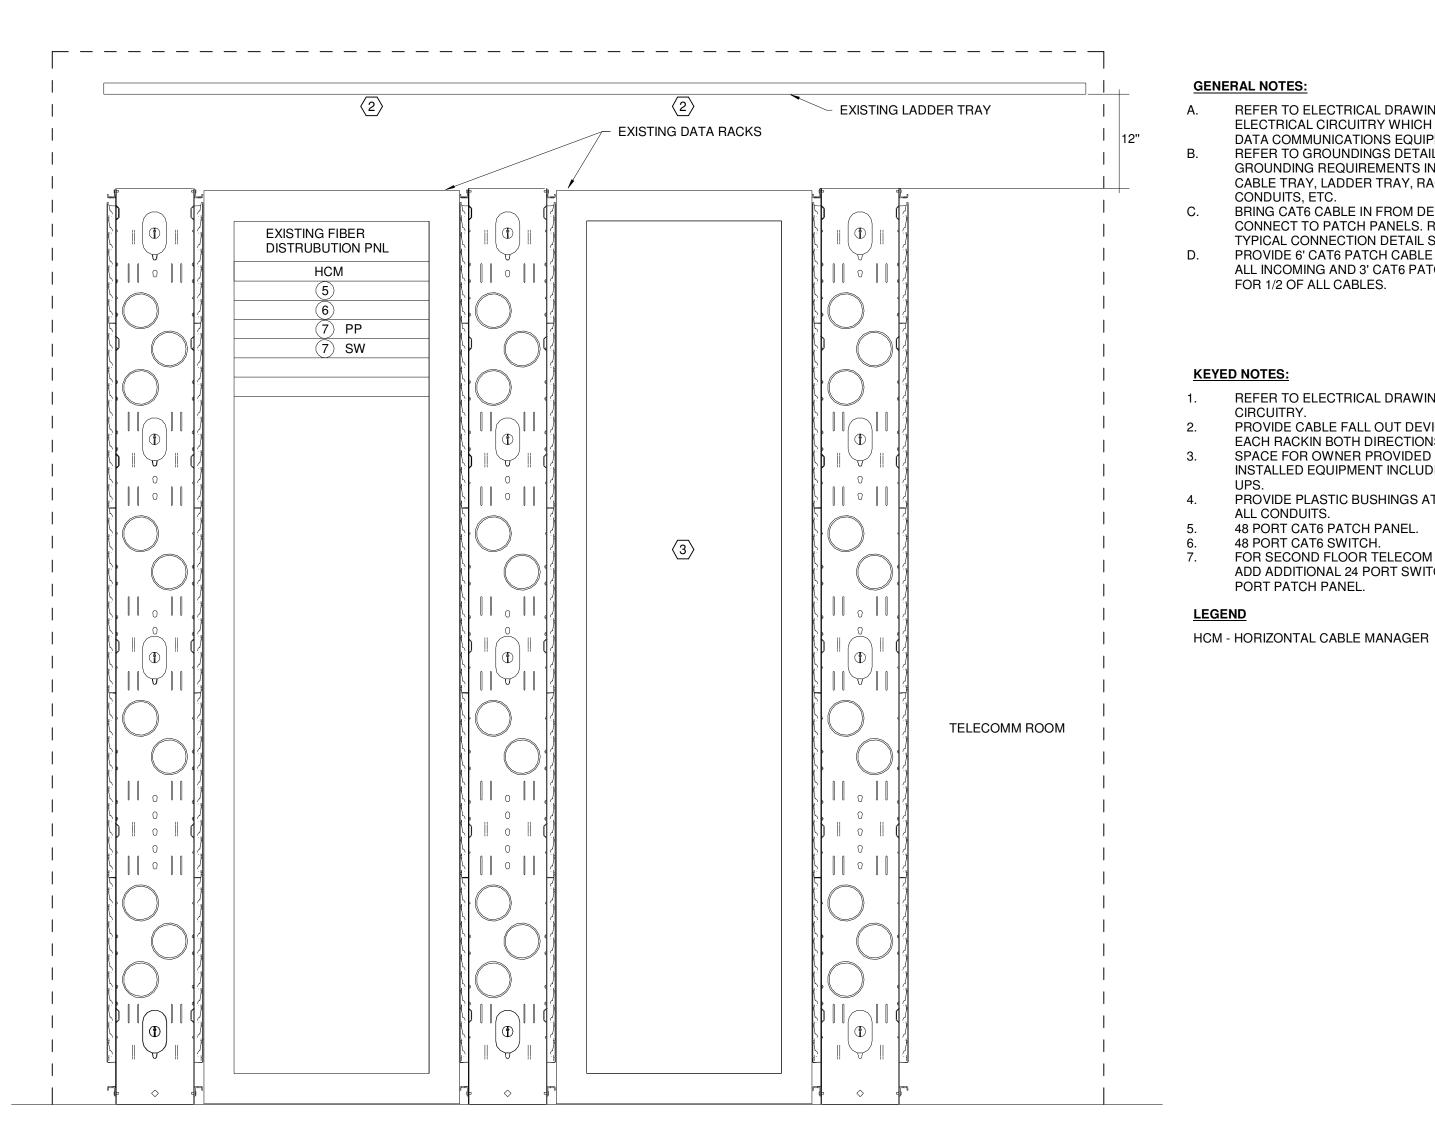

DRAWING NOTES

- REPLACE EXISTING SPARE 15A/3P BREAKER WITH NEW SQUARE D NF TYPE BREAKER 50A/3P 65K AIC TO SERVE NEW PANEL.
- PROVIDE (3) #8, (1) #10 GRD. IN .75" C.
- PROVIDE (4) #3, (1) #8 GRD. IN 1.25" C.

REFER TO ELECTRICAL DRAWINGS FOR

DATA COMMUNICATIONS EQUIPMENT.

CABLE TRAY, LADDER TRAY, RACKS,

CONDUITS, ETC.

CIRCUITRY.

ALL CONDUITS.

PORT PATCH PANEL.

FOR 1/2 OF ALL CABLES.

ELECTRICAL CIRCUITRY WHICH WILL SERVE

REFER TO GROUNDINGS DETAIL #8/T501 FOR

GROUNDING REQUIREMENTS INCLUDING

BRING CAT6 CABLE IN FROM DEVICES AND CONNECT TO PATCH PANELS. REFER TO

PROVIDE 6' CAT6 PATCH CABLE FOR 1/2 OF

ALL INCOMING AND 3' CAT6 PATCH CABLE

REFER TO ELECTRICAL DRAWINGS FOR

EACH RACKIN BOTH DIRECTIONS.

48 PORT CAT6 PATCH PANEL. 48 PORT CAT6 SWITCH.

PROVIDE CABLE FALL OUT DEVICES ABOVE

SPACE FOR OWNER PROVIDED AND OWNER INSTALLED EQUIPMENT INCLUDING SERVER

PROVIDE PLASTIC BUSHINGS AT THE END OF

FOR SECOND FLOOR TELECOM ROOM RACK ADD ADDITIONAL 24 PORT SWITCH AND 24

TYPICAL CONNECTION DETAIL SHEET.



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Date

January 24, 2022

Sheet Title


ELECTRICAL DETAILS

Sheet Number


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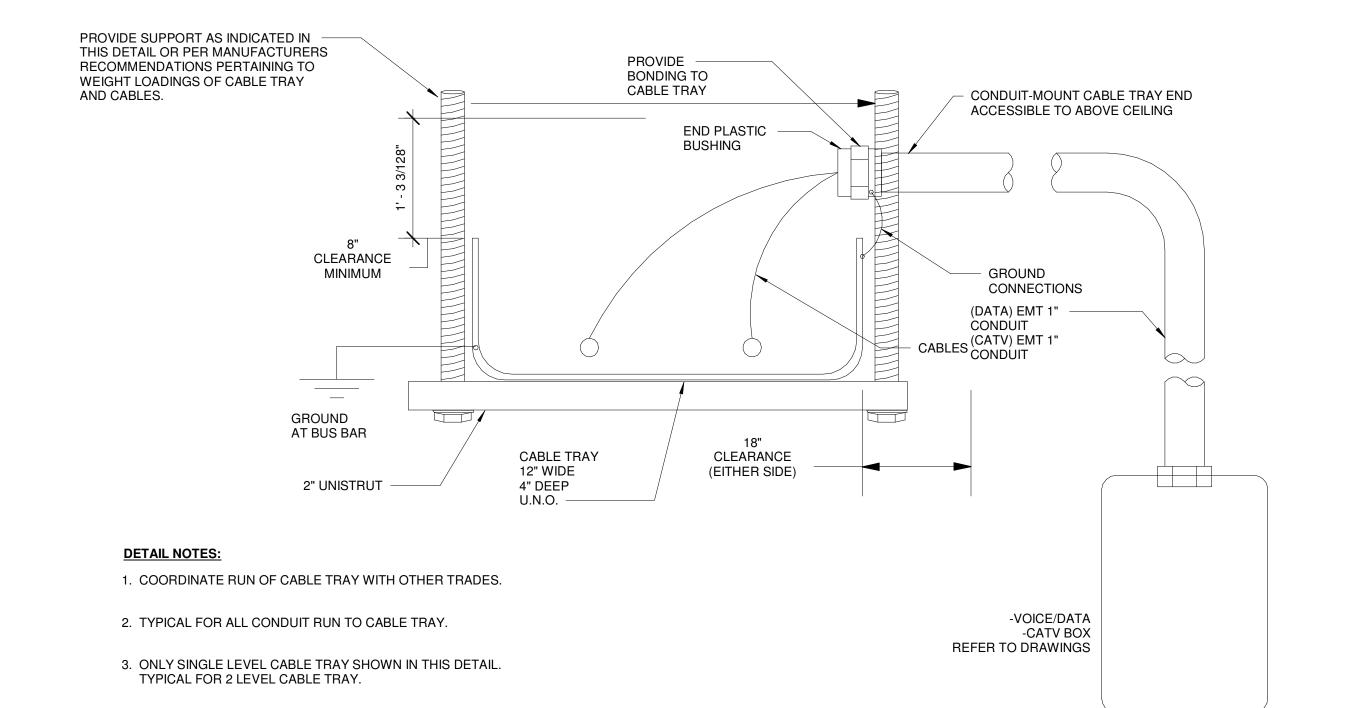
1 TYPICAL VOICE DATA CONNECTION DETAIL NTS

② SERVER RACK ELEVATION/RISER NTS

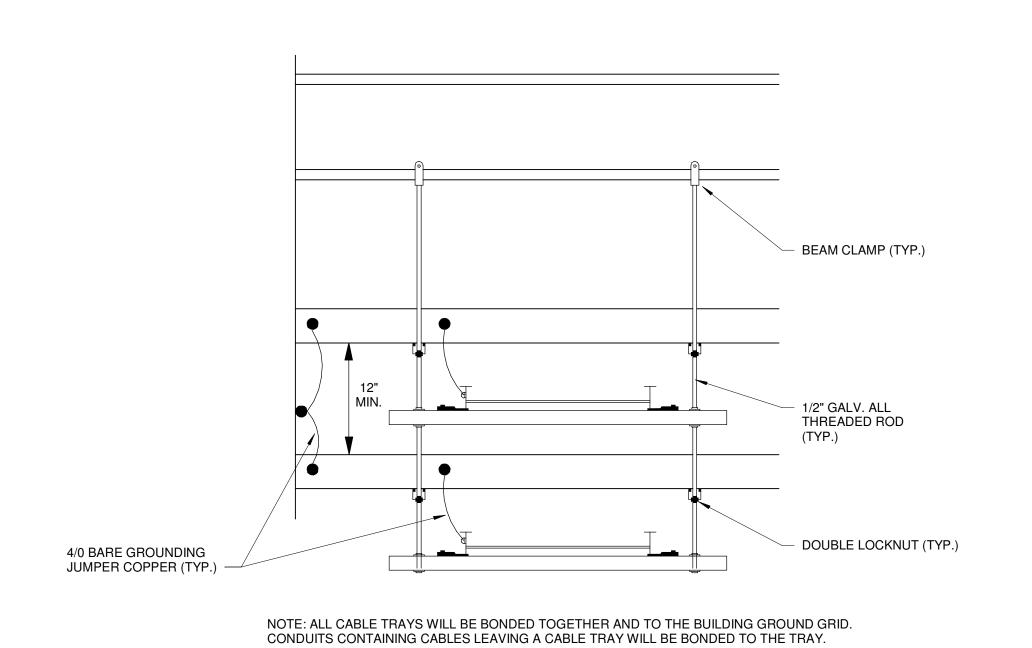

① CABLE TRAY TRAPEZE AND GROUNDING NTS



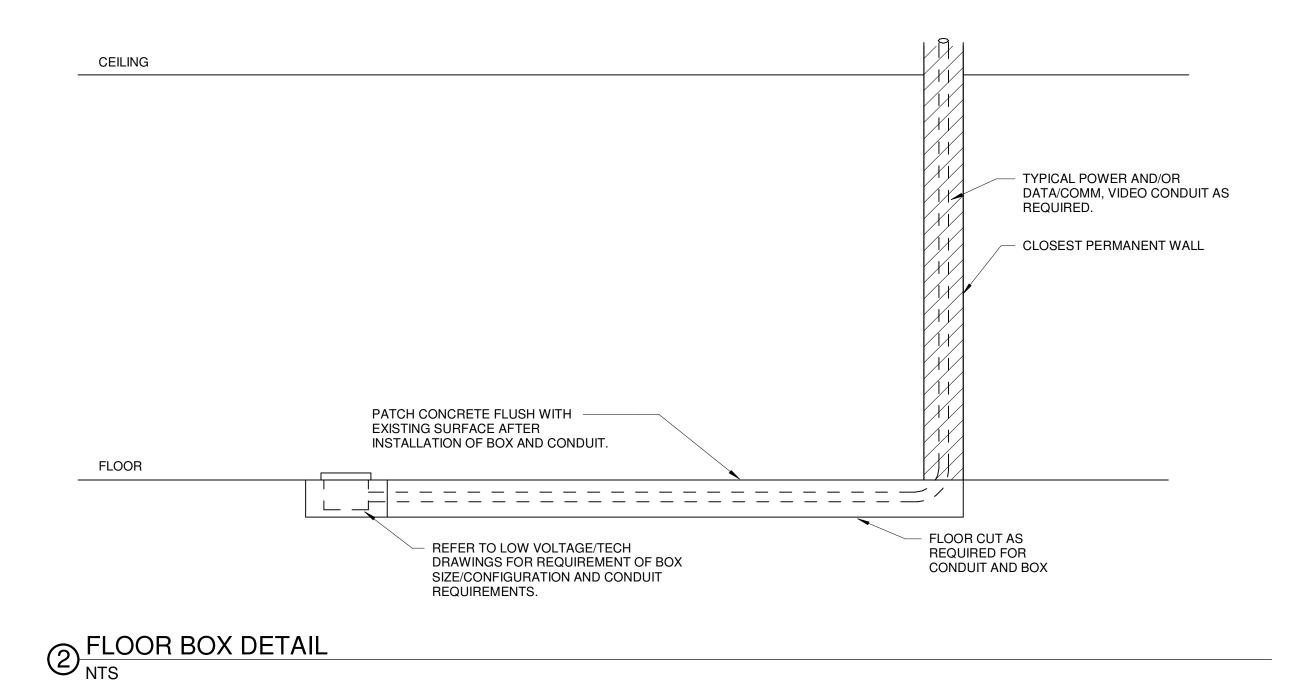

 CABLE TRAY SHALL BE WIRE BASKET TYPE WITH NO CENTER HUNG SUPPORT.

3 CONDUIT TO CABLE TRAY DETAIL

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Piqua, Ohio 45356

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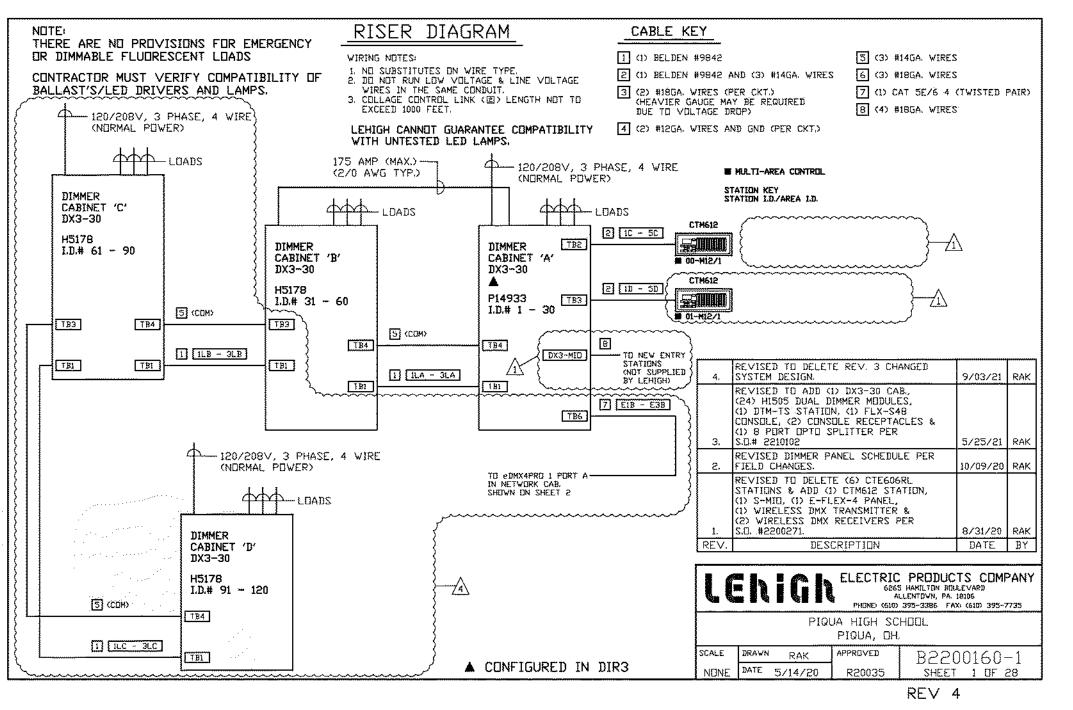
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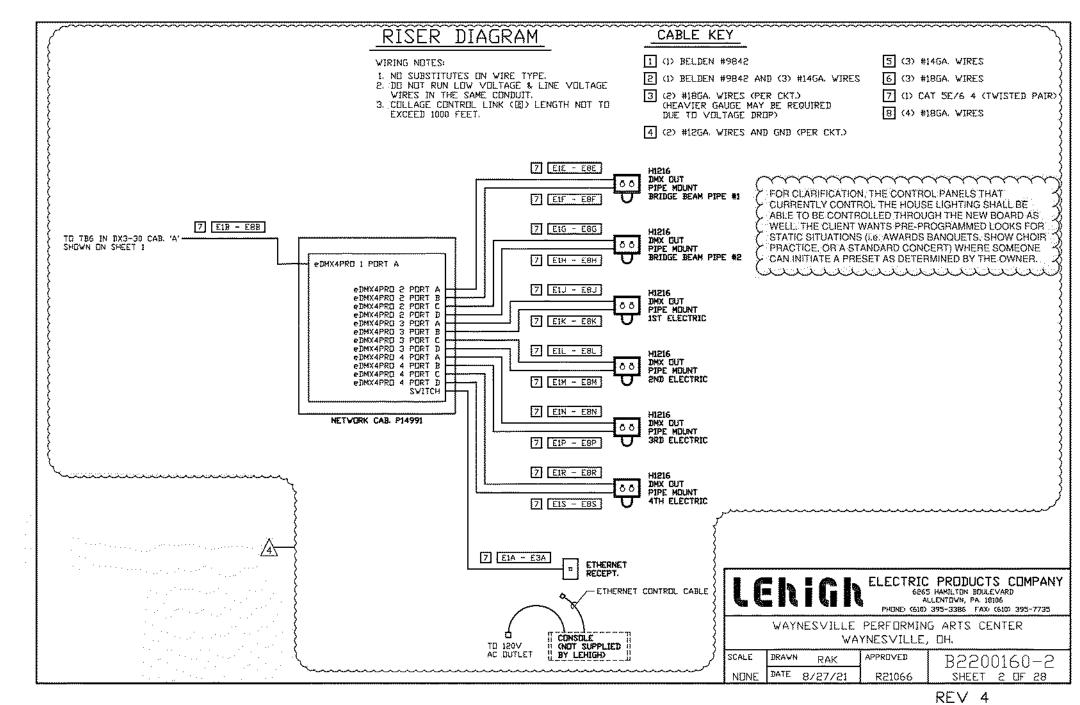
January 24, 2022


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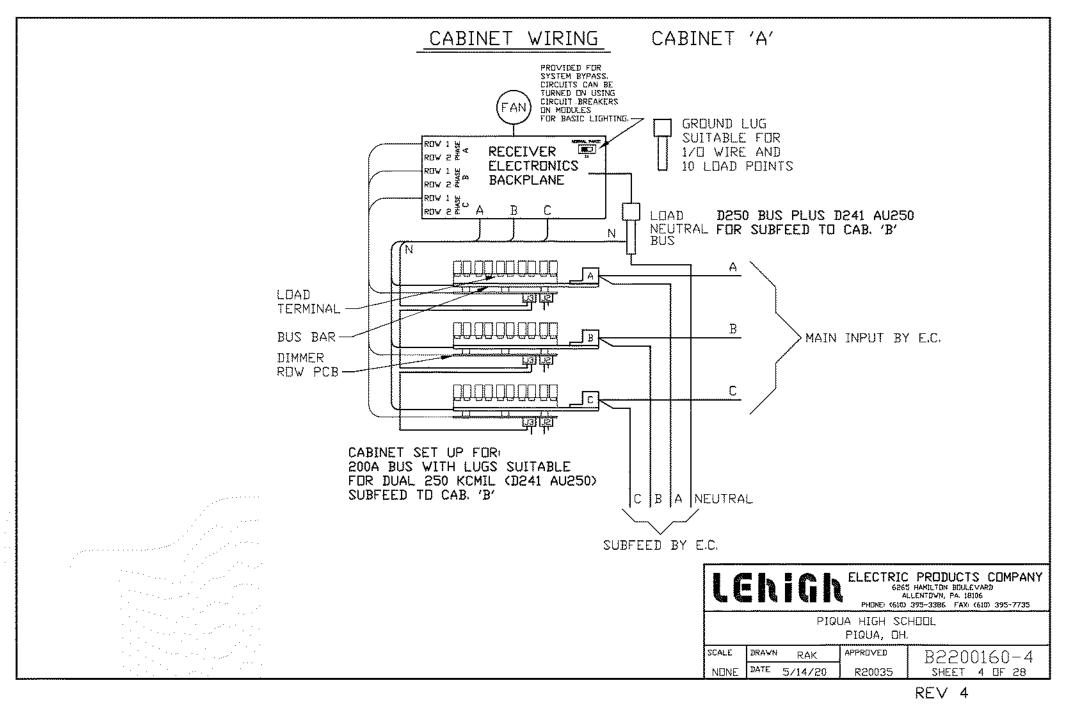
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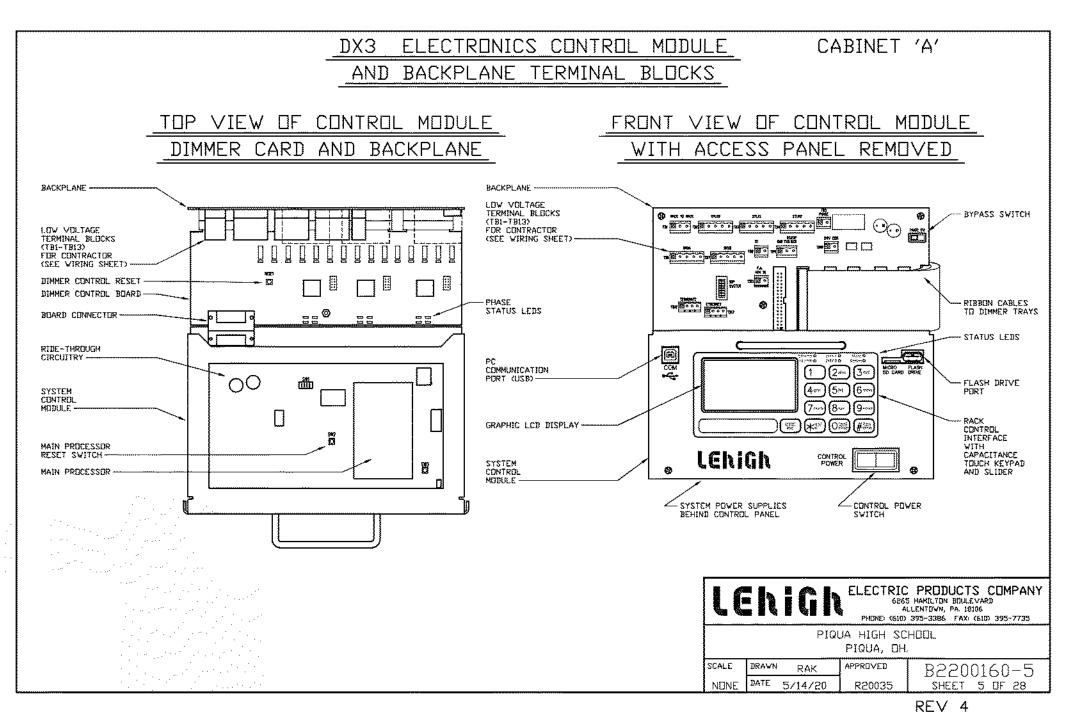
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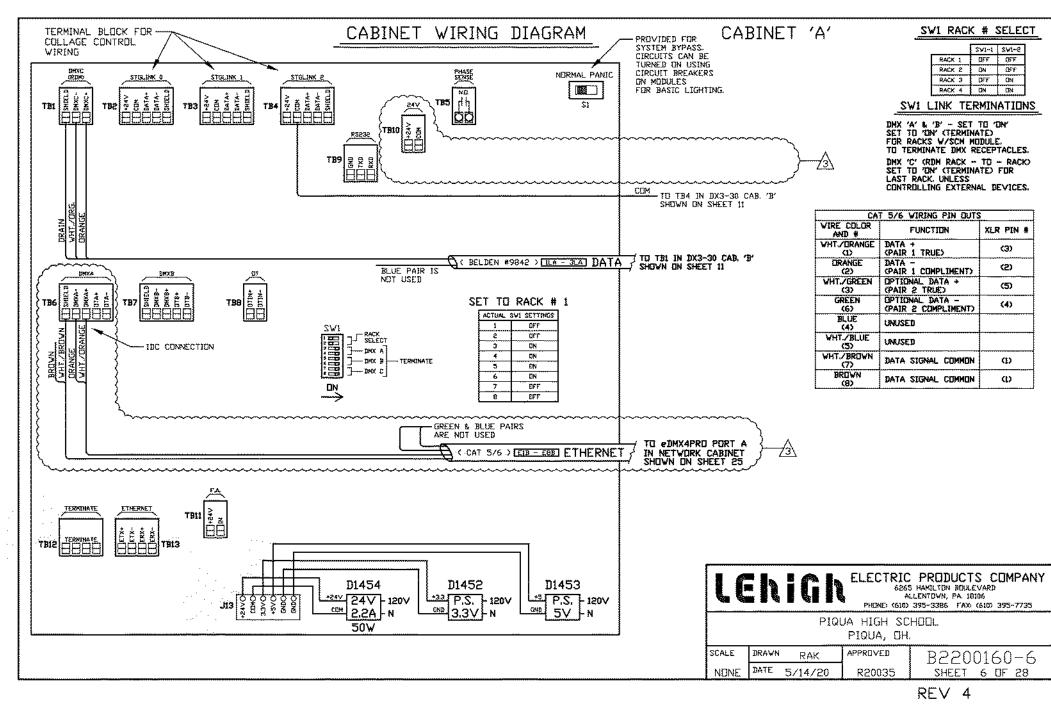
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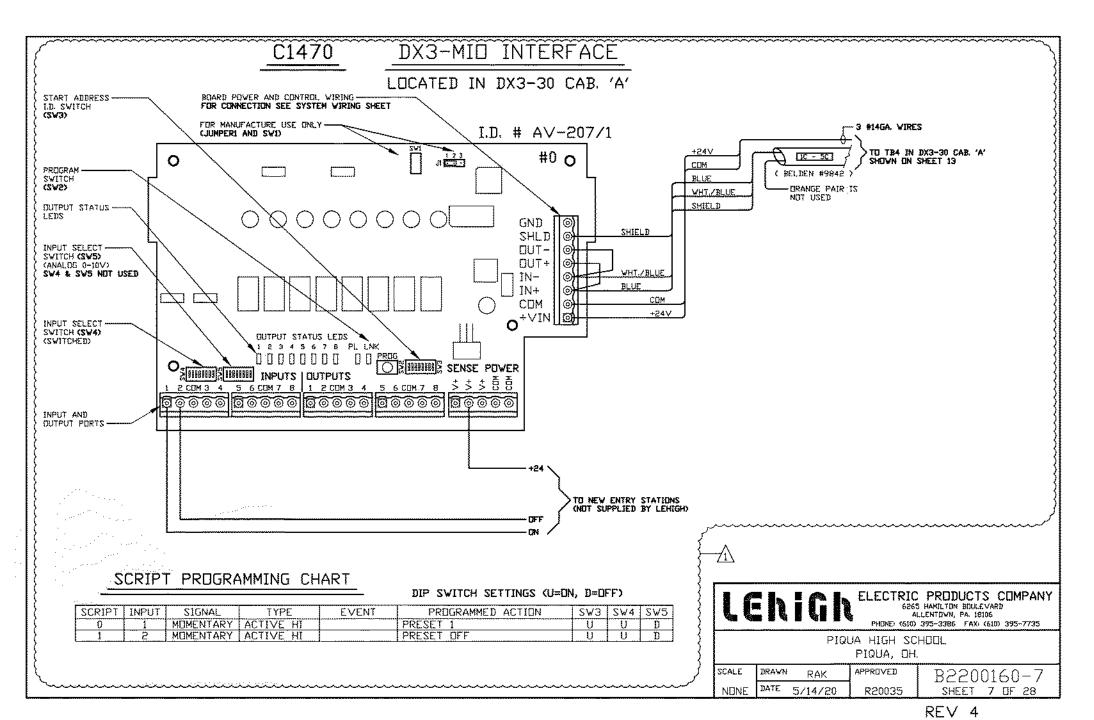
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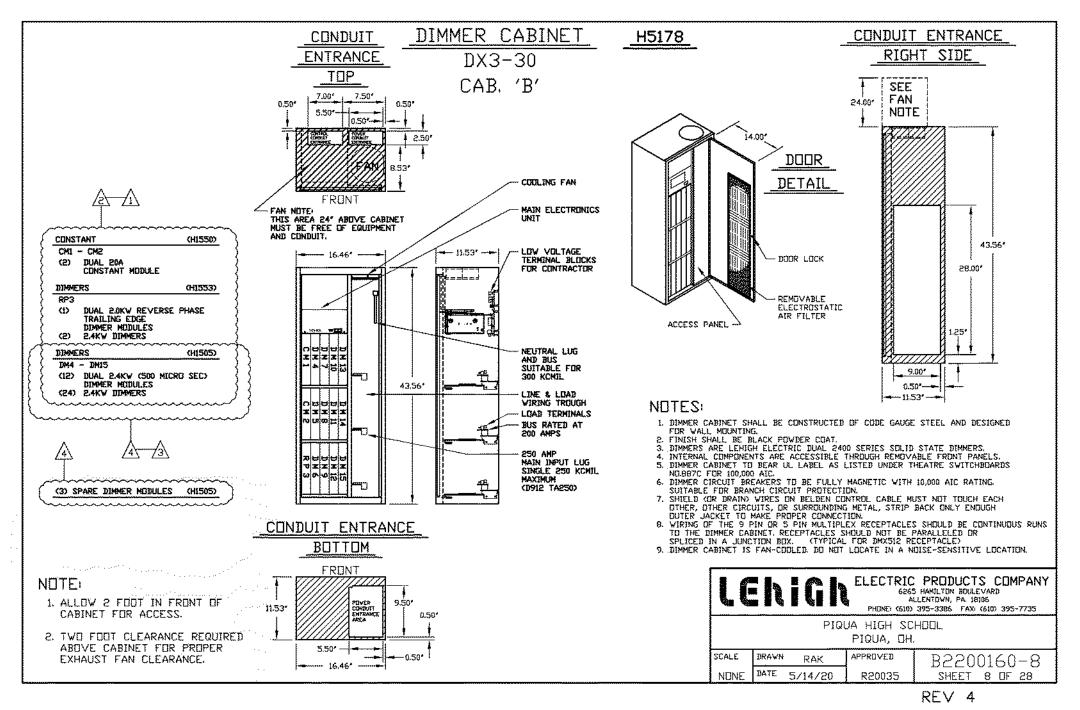
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ations 2022 Project at:

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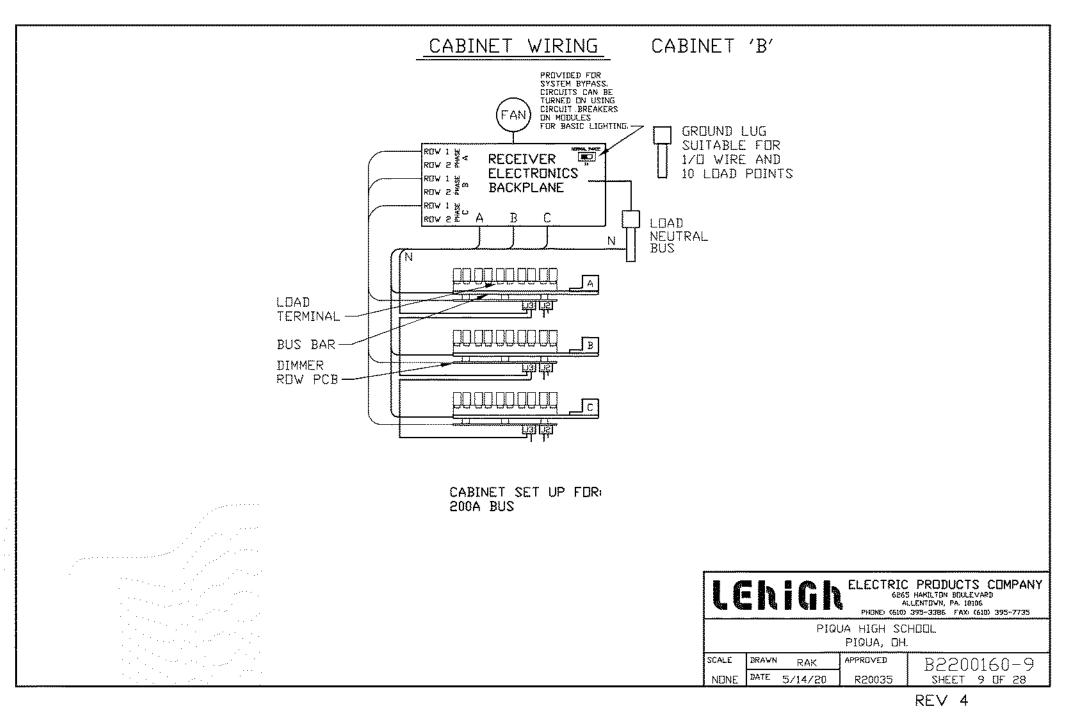
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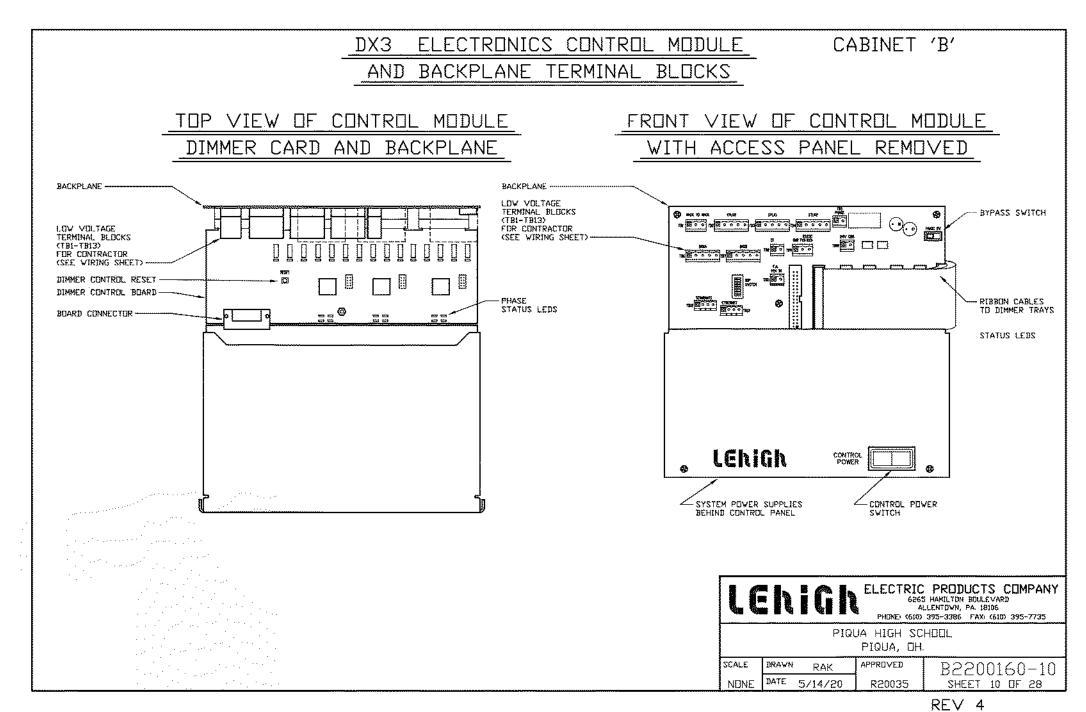
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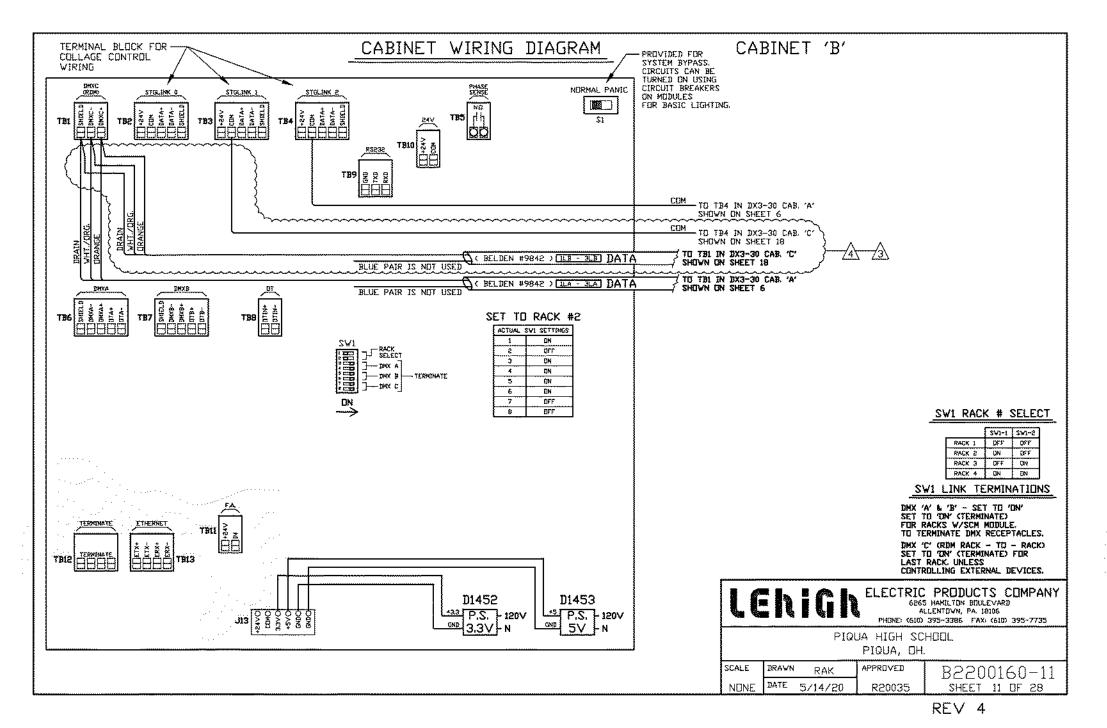
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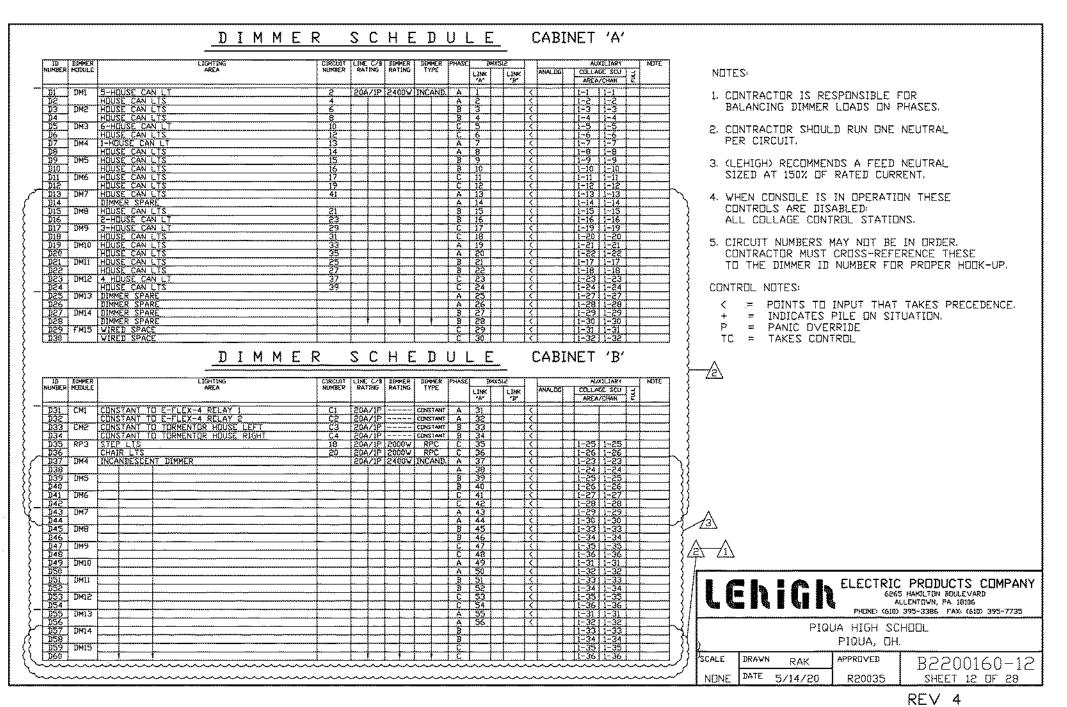
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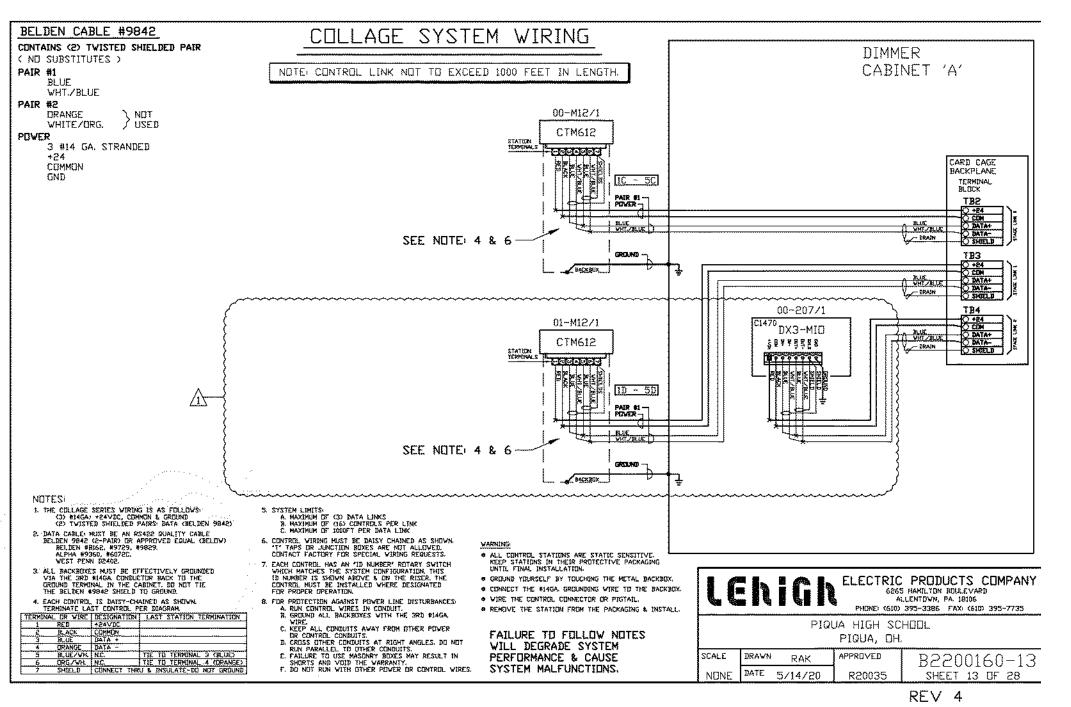
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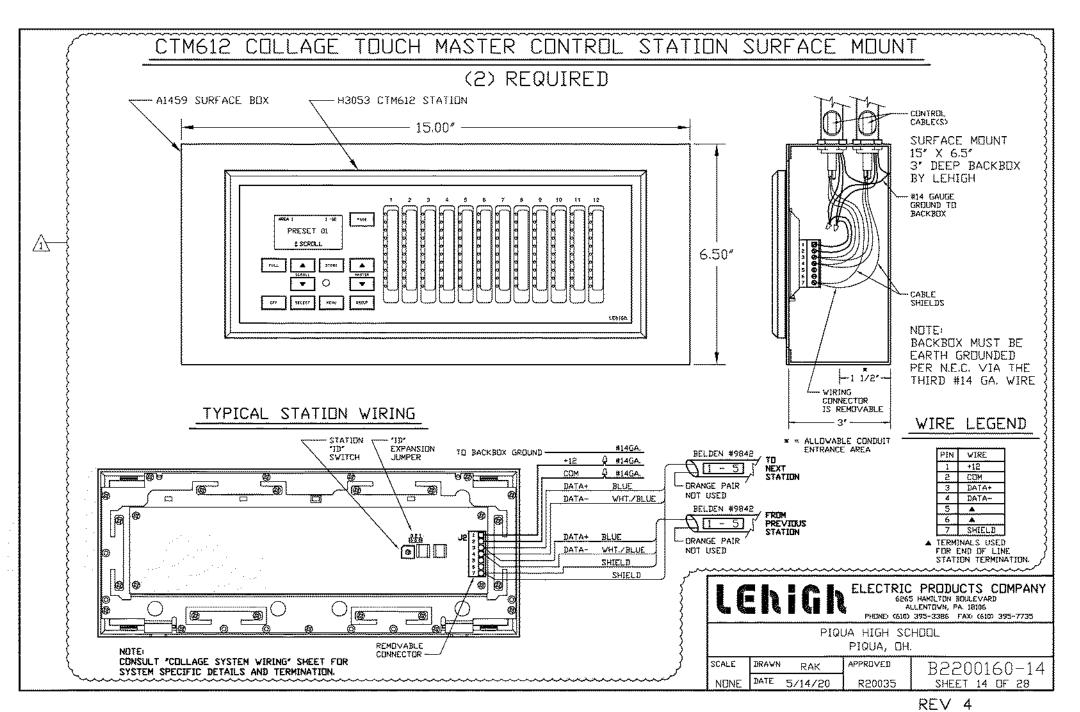
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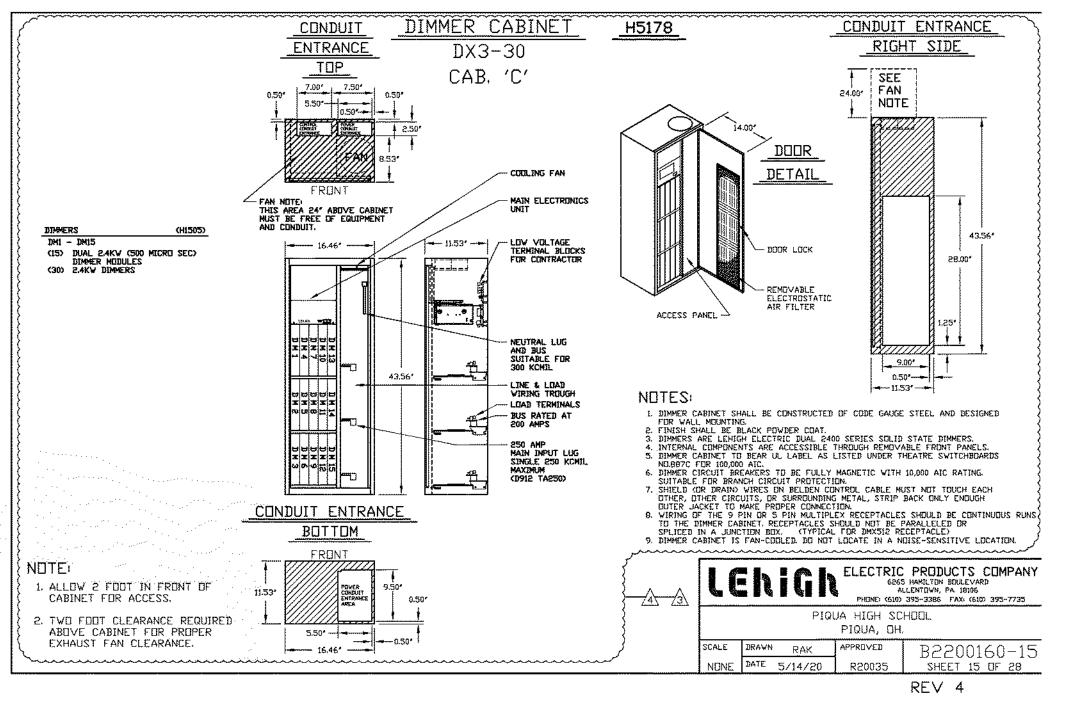
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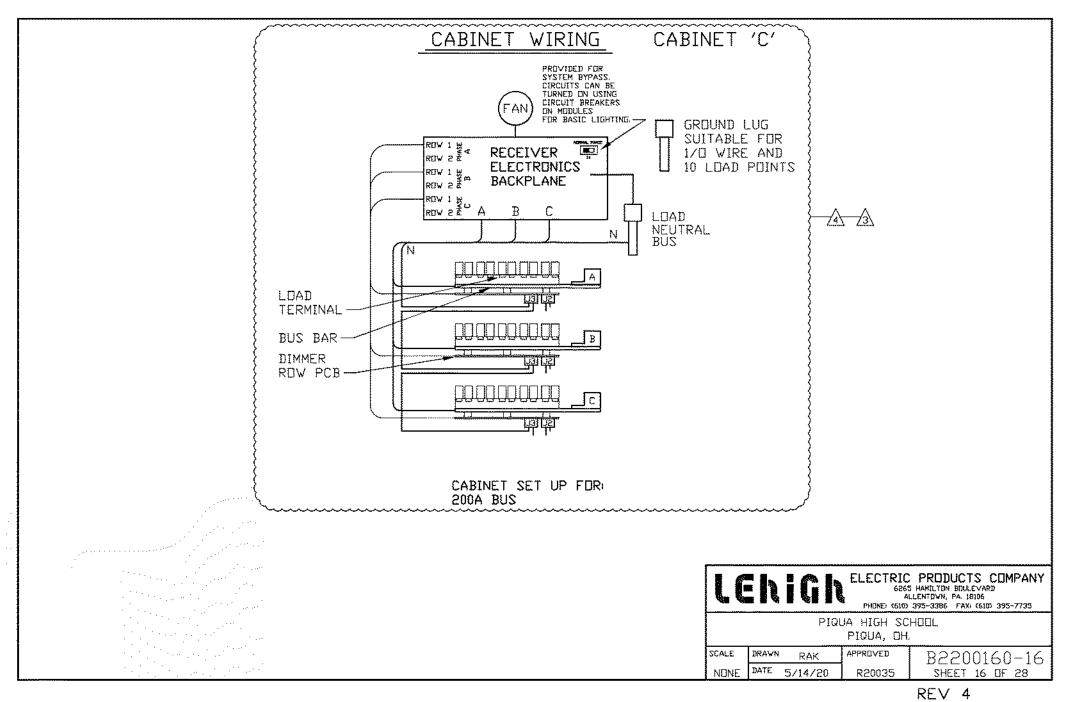
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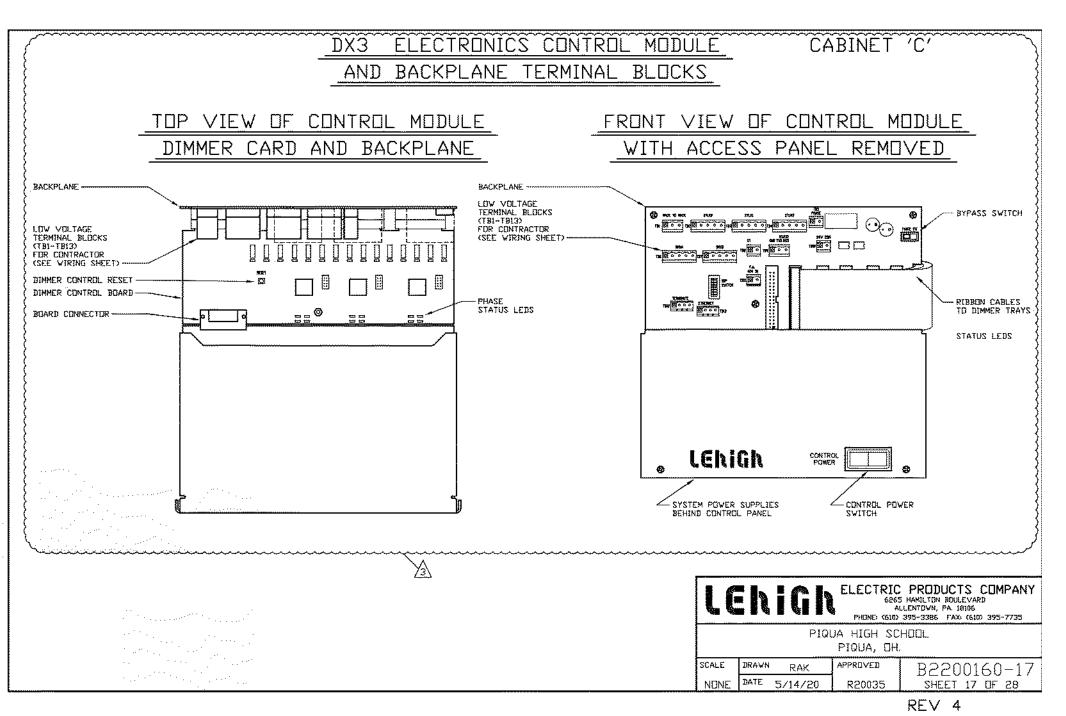
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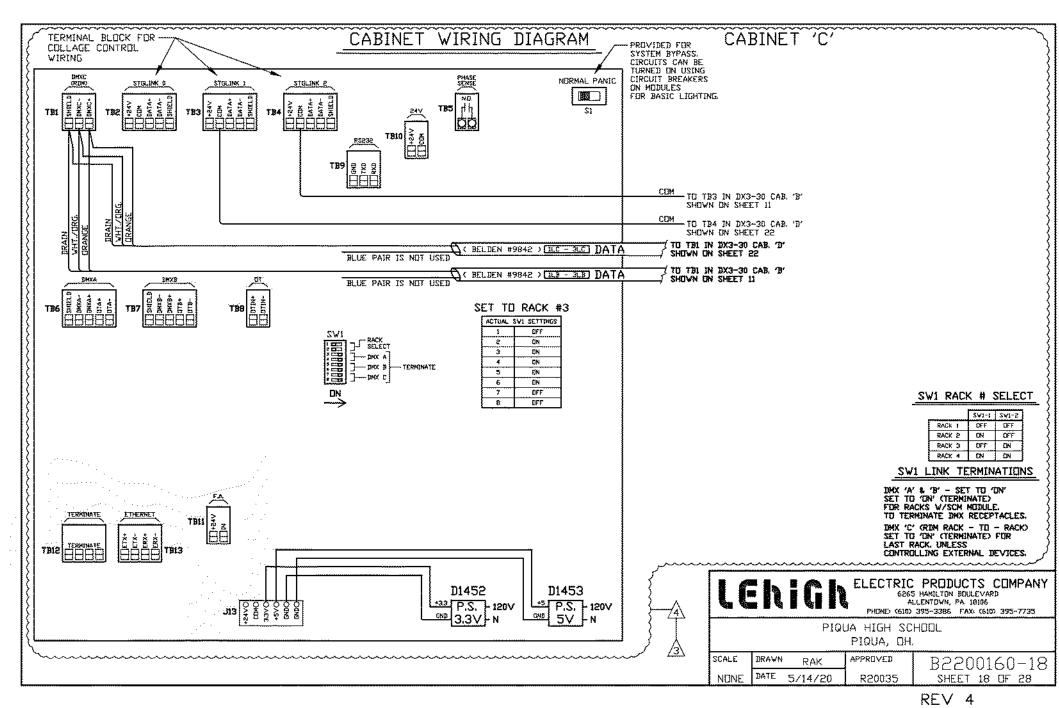
January 24, 2022


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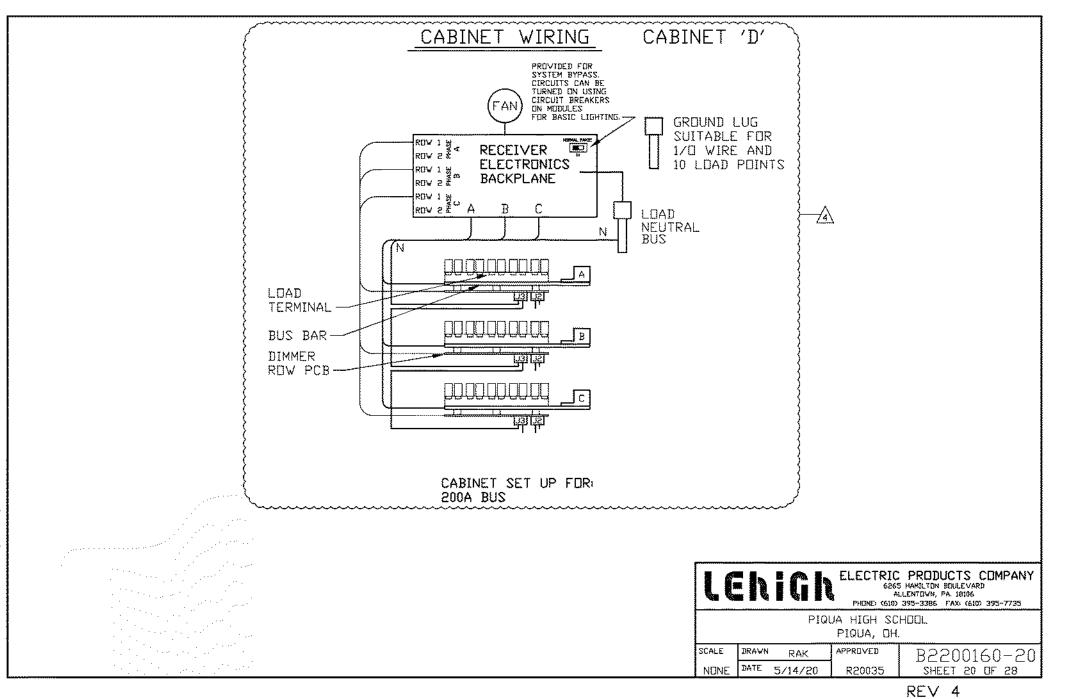
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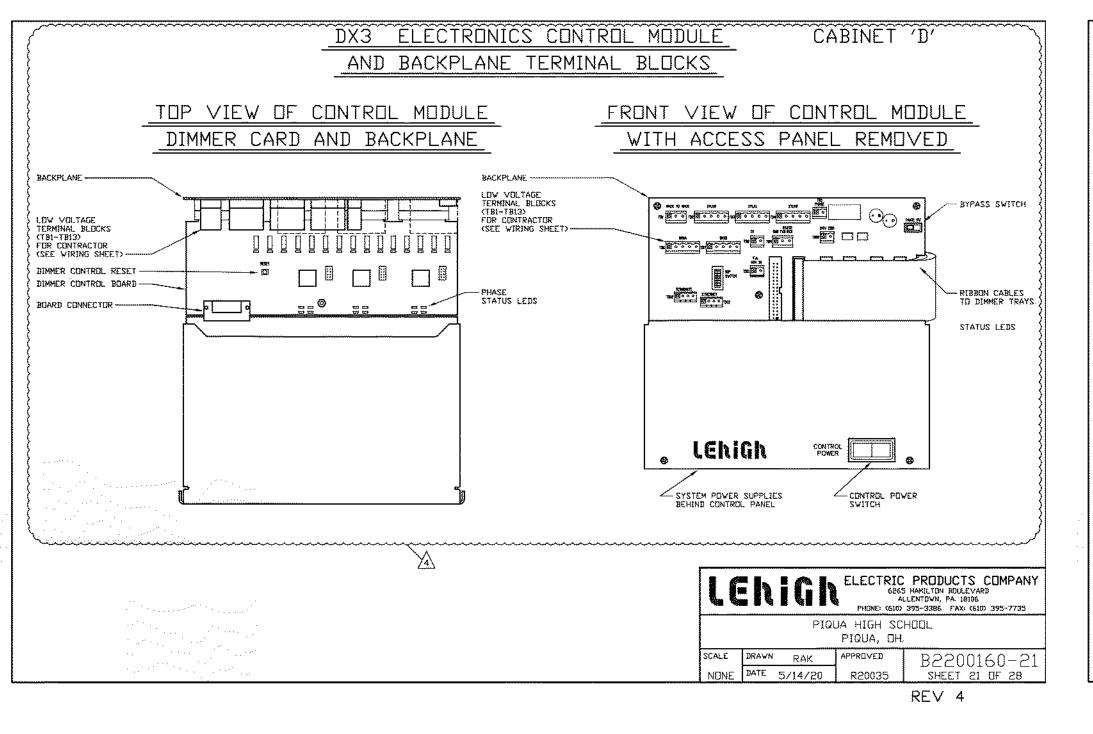
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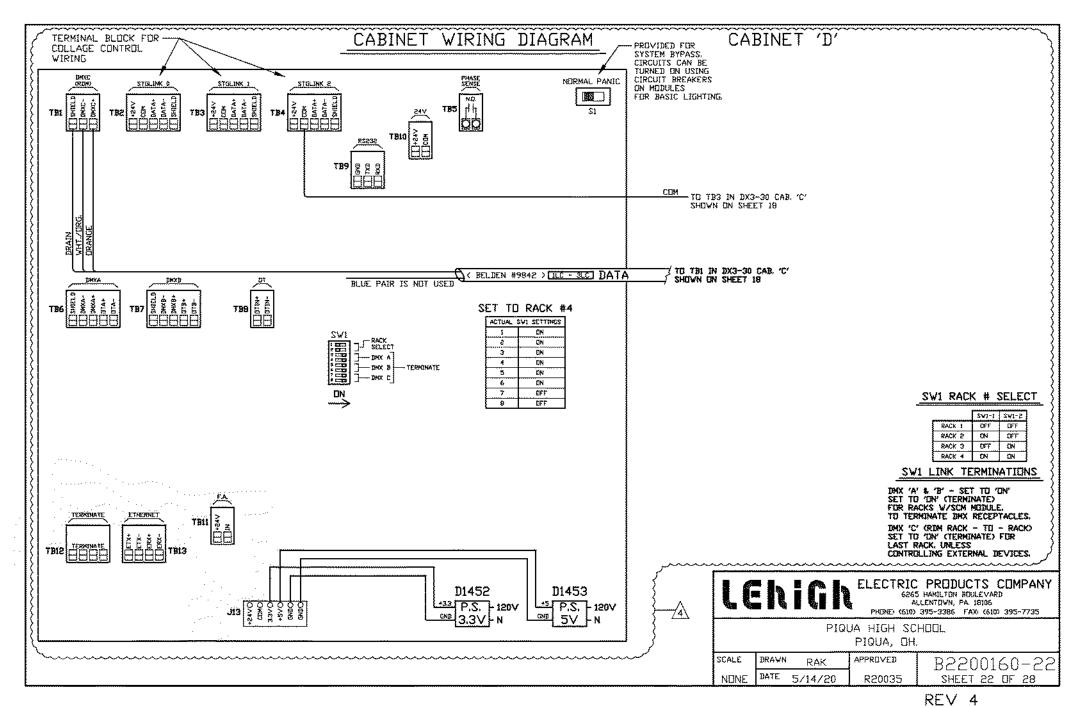
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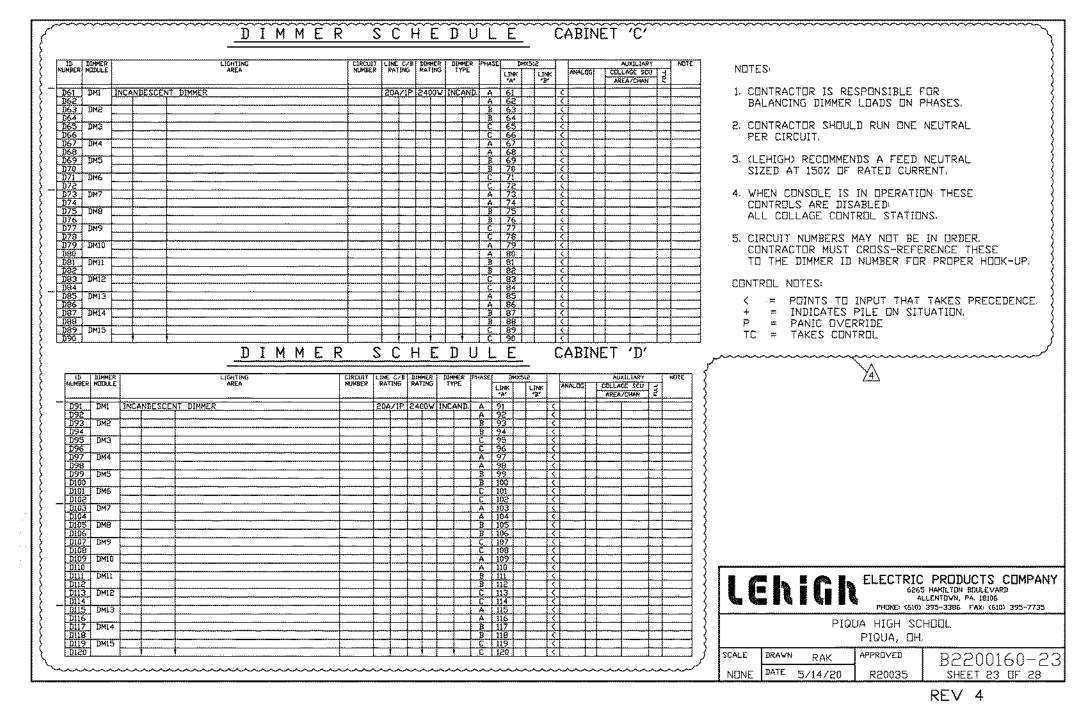
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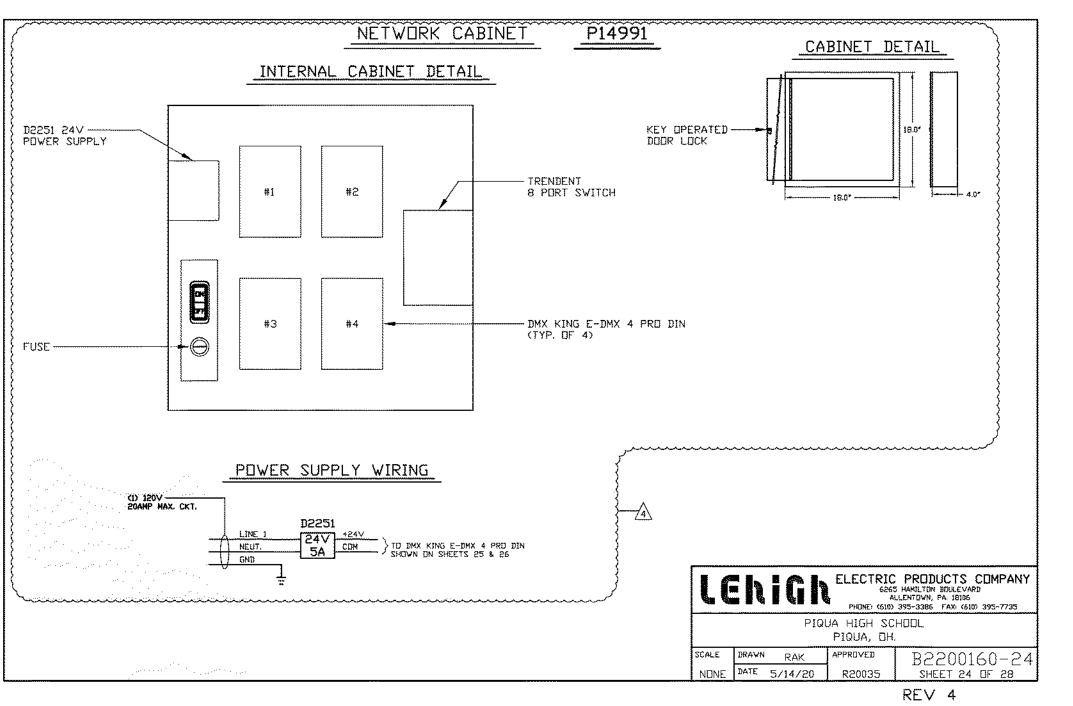
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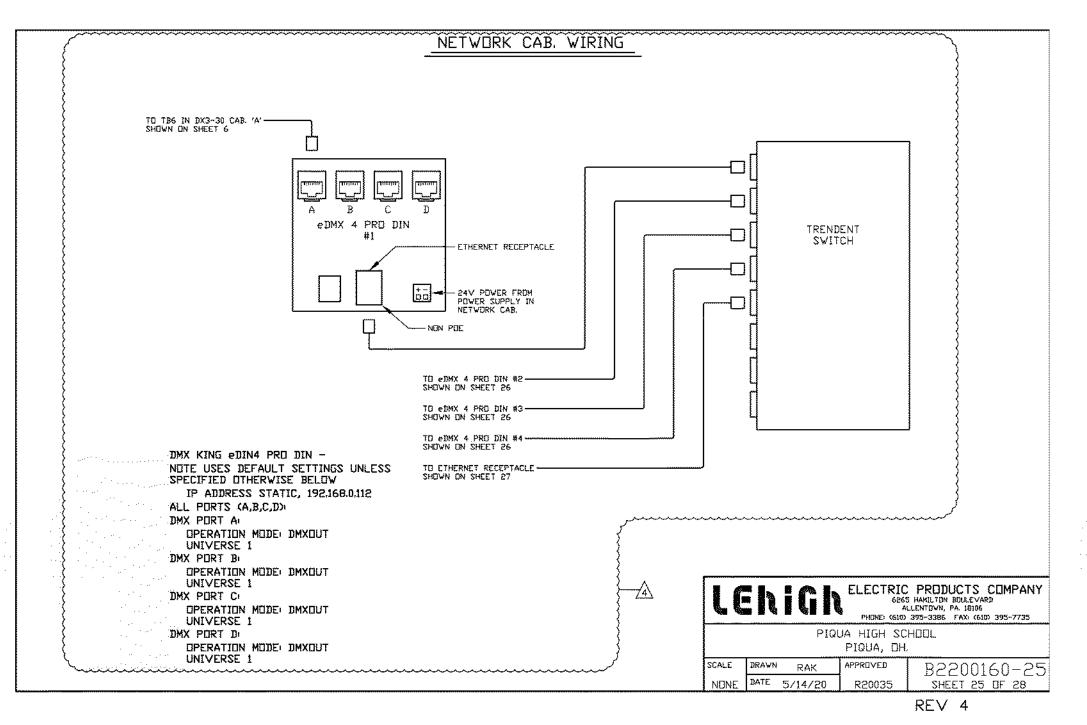
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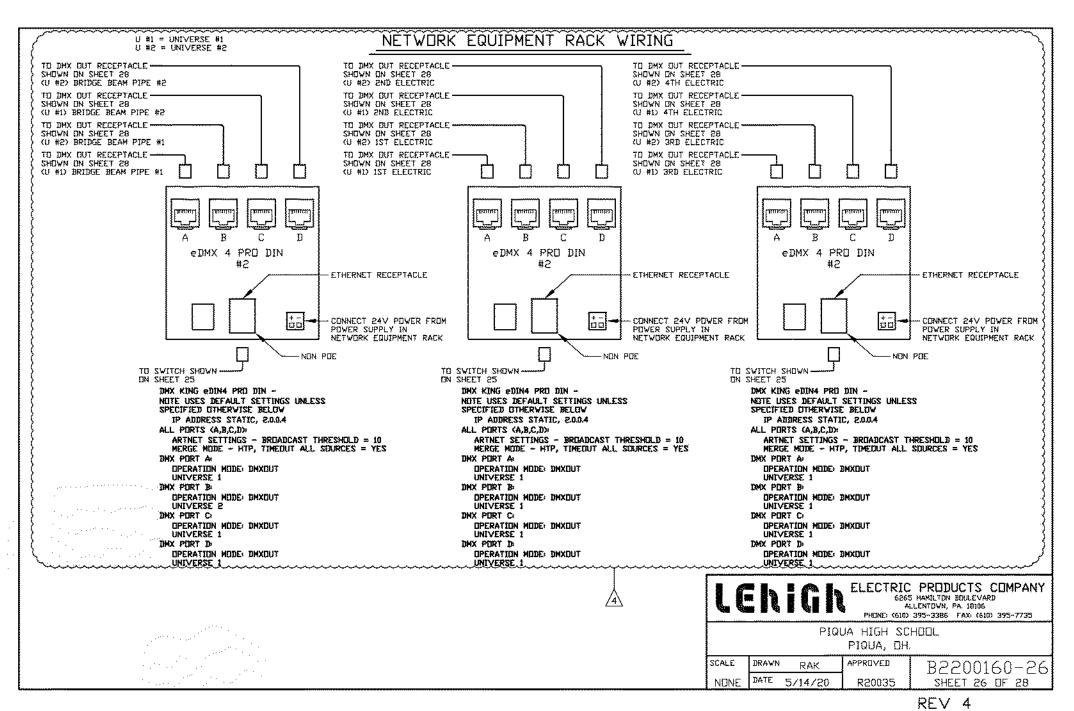
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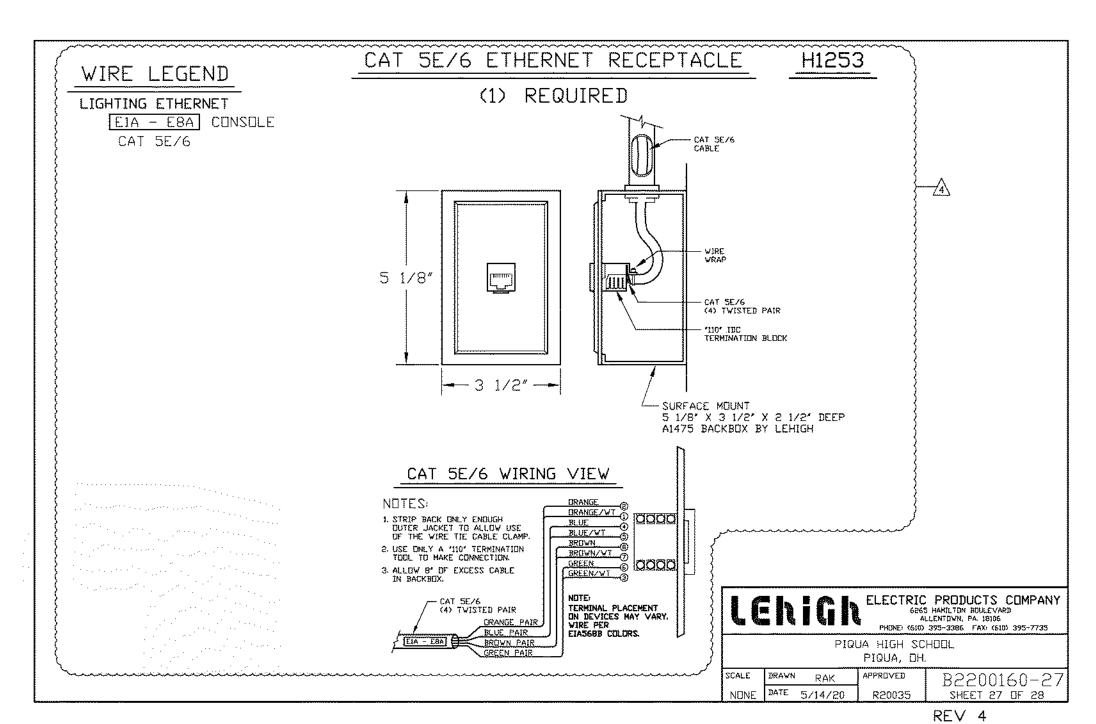
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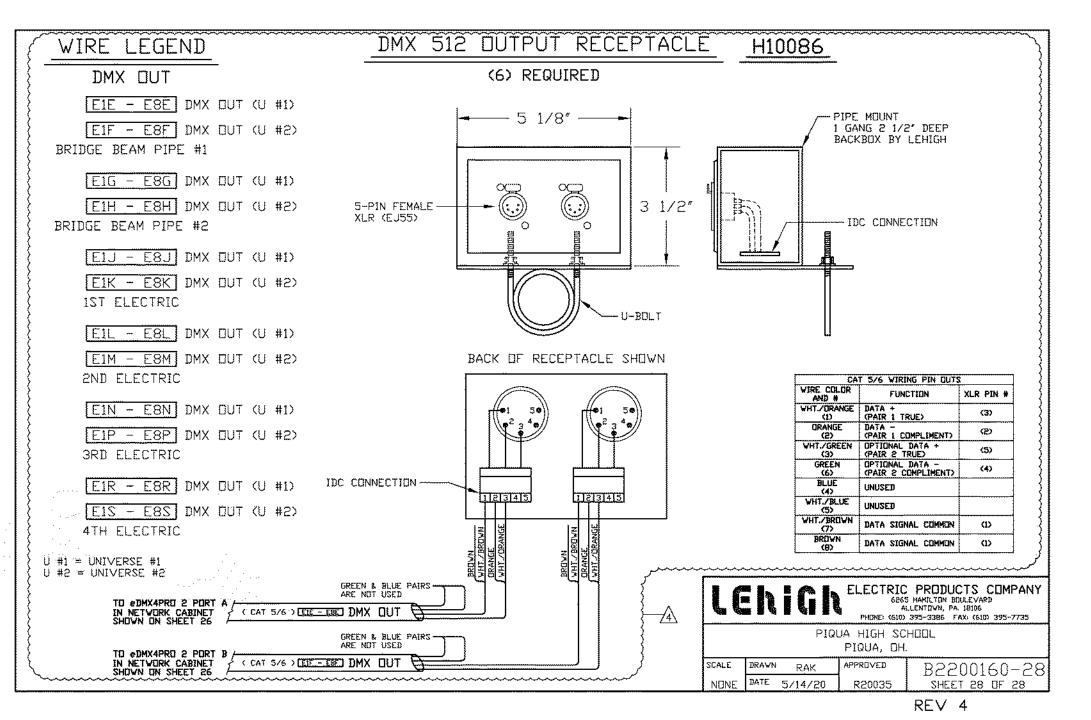
LEHIGH DETAILS

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LEHIGH DETAILS

Sheet Number

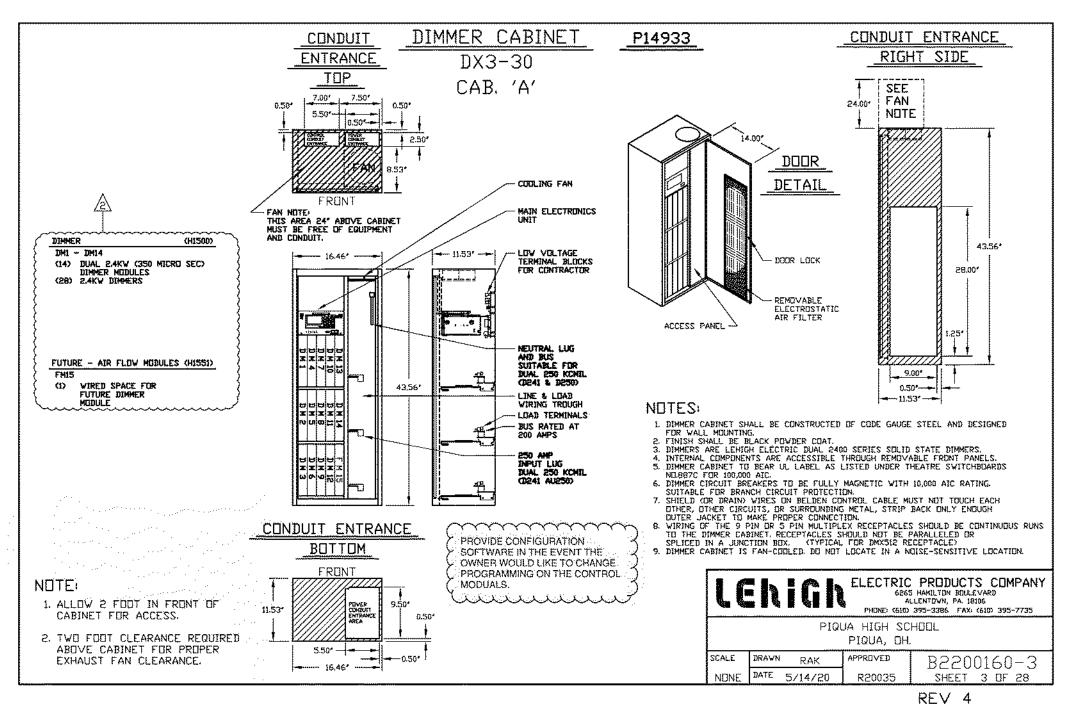	Branch Panel: 101 Location: Supply From: Mounting: Recessed Enclosure: Type 1					Volts: Phases: Wires:		7 Wye				A.I.C. Rating: Mains Type: Mains Rating: 225 A MCB Rating: 1 A		
Notes:														
СКТ	Circuit Description	Trip	Poles		A		В		С	Poles	Trip	Circuit D	escription	СКТ
1	LTS. RMS. 127, 118	20 A	1	0	0					1		LTS. RMS. 128	Soription	2
3	LTS. RMS. 129, 116	20 A	1			0	0			1	20 A			4
5	LTS. RMS. 131, 133	20 A	1					0	0	1	20 A			6
7	LTS. RMS. 134, 135	20 A	1	0	0					1		LTS. RMS. 137		8
9	LTS. RMS. 136	20 A	1			0	0			1		LTS. RMS. 138		10
11	LTS. HALL SOUTHWEST	20 A	1					0	0	1		LTS. RMS. 160		12
13	LTS. RMS. 159	20 A	1	0	0					1		LTS. RMS. 161		14
15	LTS. RMS. 119	20 A	1			0								16
17	COMPRESSOR	20 A	3					0						18
19				0										20
21						0								22
23														24
25														26
27														28
29														30
31														32
33														34
35														36
37	T1	50 A	3	0										38
39						0								40
41								0						42
		Tota	al Load:	0	VA	0	VA	0	VA			-		
		Tota	l Amps:	0	Α	0	Α	0	Α	_				
egeno	l:													
oad C	lassification	Con	nected L	oad		Demand Fa	ctor	Estin	nated De	emand		Panel	Totals	
lotor			0 VA			0.00%			0 VA			. 21101	-	
												Total Conn. Load:	0 VA	
												Total Est. Demand:		
												Total Conn.:		
												Total Est. Demand:		
		- 			1									

Notes:	Branch Panel: 202 Location: Supply From: Mounting: Recessed Enclosure: Type 1					Volts: Phases: Wires:		3 Wye				A.I.C. Rating: Mains Type: MB Mains Rating: 100 A MCB Rating: 1 A	
СКТ	Circuit Description	Trip	Poles		A	ı	В	(0	Poles	Trip	Circuit Description	СКТ
1	RECEP. RM. 130A (EXISTING)	20 A	1	0	0					1	20 A	RECEP. RM 126, 126A (EXISTING)	2
3	RECEP. RM 126,130 (EXISTING)	20 A	1			0	0			1	20 A	RECEP. RM 126A, 126B, 127,128 (EXISTING)	4
5	RECEP. RM. 129,130 (EXISTING)	20 A	1					0	0	1	20 A	LOUNGE RECEP (EXISTING)	6
7	RECEP. RM 126,128 (EXISTING)	20 A	1	0	0					1	20 A	LOUNGE VENDING MACHINE (EXISTING)	8
9	RECEP. RM 102 (EXISTING)	20 A	1			0	0			1	20 A	RECEP. RM 127, 304 (EXISTING)	10
11	RECEP. RM 103 (EXISTING)	20 A	1					0	0	1	20 A	RECEP. RM 304B, 304C (EXISTING)	12
13	RECEP. RM 104 (EXISTING)	20 A	1	0	0					1	20 A	RECEP. RM 304C, 304D (EXISTING)	14
15	HALL	20 A	1			0	0			1	20 A	RECEP. RM 304A (EXISTING)	16
17	RECEP. RM 100,101 (EXISTING)	20 A	1					0	0	1	20 A	RECEP. RM 304A, 304B (EXISTING)	18
19	RECEP. RM 123A, 125 (EXISTING)	20 A	1	0	0					1	20 A	RECEP. RM 304E (EXISTING)	20
21	RECEP. RM 123A, 125 (EXISTING)	20 A	1			0	0			1	20 A	RECEP. RM 121, 124 (EXISTING)	22
23	RECEP. RM 123A, 125 (EXISTING)	20 A	1					0	0	2	20 A	LOUNGE COPIER (EXISTING)	24
25	RECEP. RM 123 (EXISTING)	20 A	1	0	0								26
27	RECEP. RM 123, 123B (EXISTING)	20 A	1			0	0			1	20 A	WATER COOLER (EXISTING)	28
29	ELEVATOR PIT LIGHT (EXISTING)	20 A	1					0	0	1	20 A	WATER COOLER (EXISTING)	30
31	LTS. RM 111, 112, 116,143 (EXISTING)	20 A	1	0	0					1	20 A	ELEVATOR SUMP PUMP (EXISTING)	32
33	ELEVATOR CONTROLS (EXISTING)	20 A	1			0	0			1	20 A	IES TRANSFORMER (EXISTING)	34
35	METER PIT SUMP PUMP (EXISTING)	20 A	1					0	0	1	20 A	RM 126 COMPUTER (EXISTING)	36
37					0					1	20 A	RM 126 COMPUTER (EXISTING)	38
39	RECEP. RM 121, 124 (EXISTING)	20 A	1			0	0			1	20 A	RM 126 COMPUTER (EXISTING)	40
41	RM 120 RACK POWER (EXISTING)	20 A	1					0	0	1	20 A	RM 126 COMPUTER (EXISTING)	42
	,	Tota	al Load:	0	VA	0	VA	0 '	VA			. ,	
			l Amps:	0	Α		Α		Α	_			

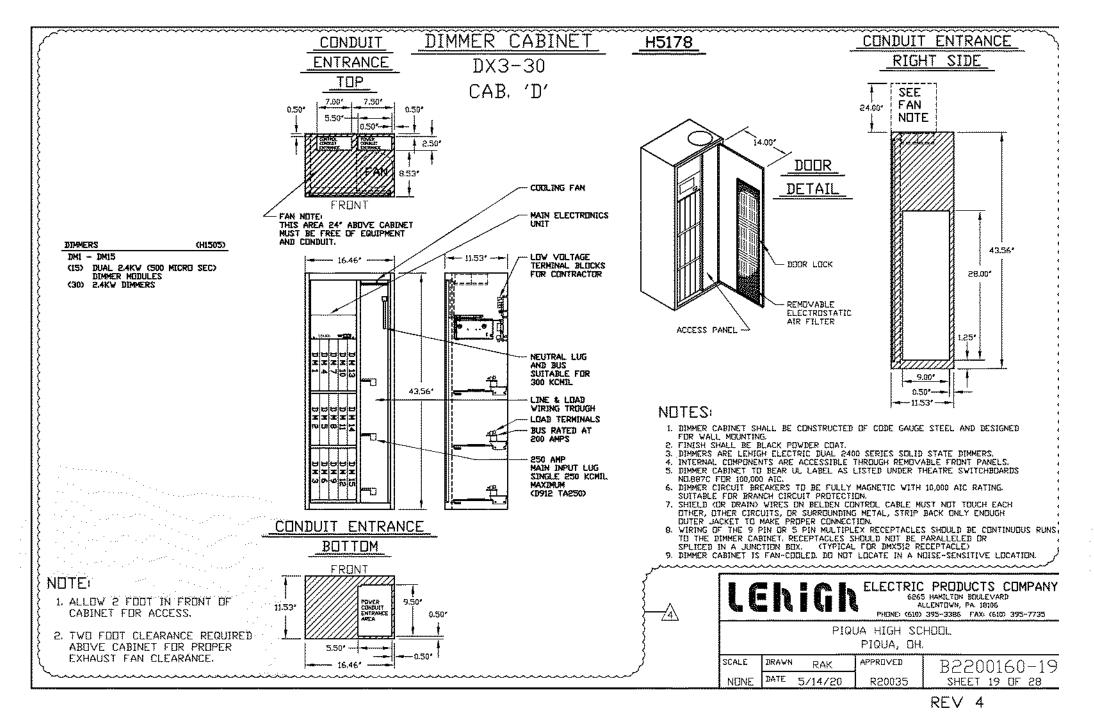oad Classification	Connected Load	Demand Factor	Estimated Demand	Panel	Totals
				Total Conn. Load:	0 VA
				Total Est. Demand:	0 VA
				Total Conn.:	0 A
				Total Est. Demand:	0 A

Branch Panel: 102 Location: Supply From: Mounting: Recessed Enclosure: Type 1				Volts: 480/277 Wye Phases: 3 Wires: 4								A.I.C. Rating: Mains Type: Mains Rating: 225 A MCB Rating: 1 A			
Notes:															
СКТ	Circuit Description	Trip	Poles		A		В		C	Poles	Trip	Circuit De		СК	
1	LTS. RMS. 121,120 (EXISTING)	20 A	1	0	0					1	20 A	LTS. RMS. 103 (EXISTING	G)	2	
3	LTS. RMS. 124 (EXISTING)	20 A	1			0	0			1	20 A	LTS. RMS. 102 (EXISTING	G)	4	
5	LTS. RMS. 126,126A, 126B (EXISTING)	20 A	1					0	0	1	20 A	LTS. RMS. 129 (EXISTING		6	
7	LTS. RMS. 130A, 130 (EXISTING)	20 A	1	0	0					1	20 A	LTS. RMS. 128 (EXISTING	-	8	
9	LTS. HALL (EXISTING)	20 A	1			0	0			1	20 A	LTS. RMS. 127 (EXISTING	•	10	
11	LTS. RMS. 123 (EXISTING)	20 A	1					0	0	1	20 A	LTS. RMS. 113 (EXISTING	G)	12	
13	LTS. RMS. 125 (EXISTING)	20 A	1	0	0					1	20 A	LTS. RMS. 123A, 123B, 1	22 (EXISTING)	14	
15	LTS. RMS. 123 (EXISTING)	20 A	1			0	0			1	20 A	,	-	16	
17	LTS. RMS. 123 (EXISTING)	20 A	1					0	0	1	20 A	LTS. RMS. 141, 142 (EXIS	STING)	18	
19	LTS. RMS. 117, 304 (EXISTING)	20 A	1	0										20	
21														22	
23														24	
25														26	
27														28	
29														30	
31														32	
33														34	
35														36	
37														38	
39														40	
41														42	
		Tota	al Load:	0	VA	0	VA	0 '	VA						
		Tota	I Amps:	() A	C	Α	0	Α						
_egeno	i :														
Load Classification		Con	De	Demand Factor Esti				mand	Panel Totals						
												Total Conn. Load:	0 VA		
												Total Est. Demand:			
												Total Conn.:			
												Total Est. Demand:		-	
												. J Zoti Zotiidildi			

	Branch Panel: 201												
	Location: Supply From: Mounting: Recessed Enclosure: Type 1	Volts: 120/208 Wye Phases: 3 Wires: 4							A.I.C. Rating: Mains Type: MB Mains Rating: 225 A MCB Rating: 1 A				
otes:													
CKT	Circuit Description	Trip	Poles	A		В		c		Poles	Trip	Circuit Description	СКТ
1	RECEPS. RM. 104, 105 (EXISTING)	20 A	1	0	0					1	20 A	OLD LIBRARY RECEPS (EXISTING)	2
3	RECEPS. RM. 105, 106, 107 (EXISTING)	20 A	1			0	0			1	20 A	RECEPS. RM. 115, 122 (EXISTING)	4
5	LIBRARIAN DESK (EXISTING)	20 A	1					0	0	1	20 A	RECEPS. RM. 122 (EXISTING)	6
7	RECEPS. RM. 108 (EXISTING)	20 A	1	0	0					1	20 A	RECEPS. RM. 119 (EXISTING)	8
9	RECEPS. RM. 110, 112 (EXISTING)	20 A	1			0	0			1	20 A	RECEPS. RM. 119, 120, 121	10
11	RECEPS. RM. 109, 110, 112 (EXISTING)	20 A	1					0	0	1	20 A	RECEPS. RM. 118 (EXISTING)	12
13	RECEPS. RM. 109, 100A (EXISTING)	20 A	1	0	0					1	20 A	RECEPS. RM. 117 (EXISTING)	14
15	RECEPS. RM. 109, 116 (EXISTING)	20 A	1			0	0			1	20 A	RECEPS. RM. 117 (EXISTING)	16
17	RECEPS. RM. 112, 114 (EXISTING)	20 A	1					0	0	1	20 A	RECEPS. RM. 117 (EXISTING)	18
19	RECEPS. RM. 114, 116 (EXISTING)	20 A	1	0	0					1	20 A	RECEPS. RM. 113 (EXISTING)	20
21	LIBRARY FLR RECEPS., SCREEN POWER	20 A	1			0	0			1	20 A	RECEPS. RM. 115 (EXISTING)	22
23	RECEPS. RM. 115 COMPUTERS (EXISTING)	20 A	1					0	0	1	20 A	RECEPS. RM 113, 115 (EXISTING)	24
25	RECEPS. RM. 115 COMPUTERS (EXISTING)	20 A	1	0	0					1	20 A	HALLS 105, 112, 118, 119 (EXISTING)	26
27	RECEPS. RM. 115 COMPUTERS (EXISTING)	20 A	1			0	0			1	20 A	AV RECEP. OLD LIBRARY (EXISTING)	28
29	RECEPS. RM. 115 COMPUTERS (EXISTING)	20 A	1					0	0	1	20 A	WATER COOLER RM. 120 (EXISTING)	30
31	RECEPS. RM. 115 COMPUTERS (EXISTING)	20 A	1	0	0					1	20 A	WATER COOLER RM. 112 (EXISTING)	32
33	RECEPS. RM. 115 COMPUTERS (EXISTING)	20 A	1			0	0			1	20 A	EF 2,3 (EXISTING)	34
35	DIGITAL LAB (EXISTING)	20 A	1					0	0	1	20 A	24 VOLT TRASNSFORMER (EXISTING)	36
37	DIGITAL LAB (EXISTING)	20 A	1	0	180					1	20 A	COMPUTER REC. OLD LIBRARY (EXISTING)	38
39	RECEPS. RM. 120 (EXISTING)	20 A	1			0	0			1	20 A	COMPUTER REC. OLD LIBRARY (EXISTING)	40
41	COMPUTER RECEP (EXISTING)	20 A	1					0	0	1	20 A	COMPUTER REC. OLD LIBRARY (EXISTING)	42
		Tota	al Load:	180	O VA	0 \	/A	0 \	/A				
		Tota	ا Amps: ُ	2	2 A	0	A	0 .	A	•			
egeno	:												
oad Classification			Connected Load				Demand Factor		Estimated Demand			Panel Totals	
eceptacle			180 VA		100.00%		180 VA						
												Total Conn. Load: 180 VA	
												Total Est. Demand: 180 VA	
												Total Conn.: 0 A	
												Total Est. Demand: 0 A	





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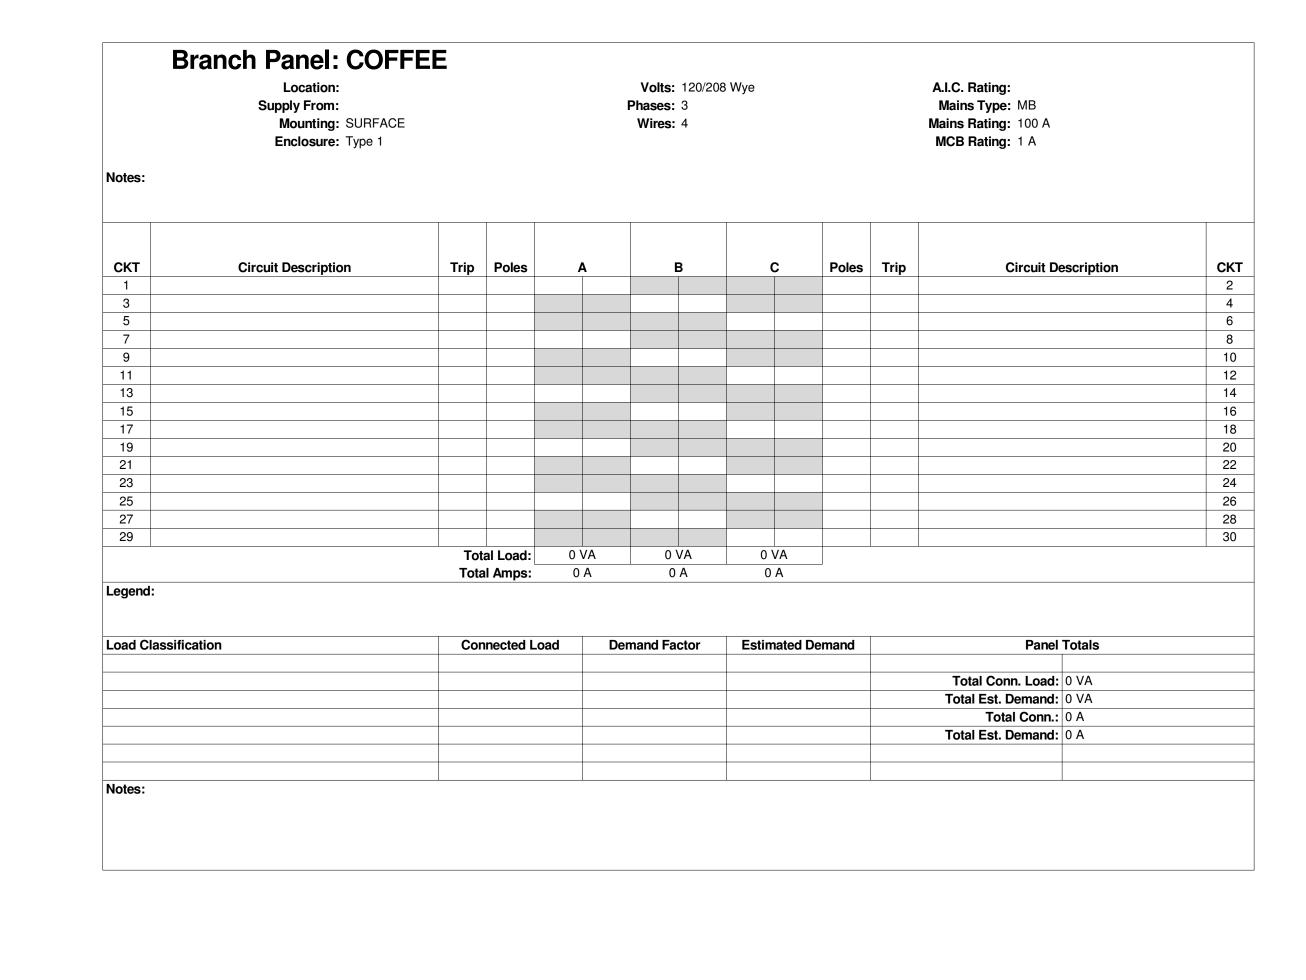
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January 24, 2022 Sheet Title

Sheet Number

E4.01

PANELBOARD SCHEDULES







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Sheet Number

E4.02



- 1. SURFACE MOUNTED DEVICES TO BE REMOVED AND ALL CABLING IS TO BE CAREFULLY PULLED TO DATA ROOM. ALL CAT5E/CAT6/6A CABLES ARE TO BE SAVED. CONTRACTOR IS RESPONSIBLE FOR ANY DAMAGED OR CUT CABLES.
- ALL EXISTING WAP AND CAMERAS ARE TO REMAIN.
- 3. REMOVE ALL OUTLETS AND LOW VOLTAGE DEVICES AND ALL ASSOCIATED WIRE, CONDUIT, AND BACK BOXES ASSOCIATED WITH TV OUTLETS. ALL LOCATIONS MAY NOT BE SHOWN.



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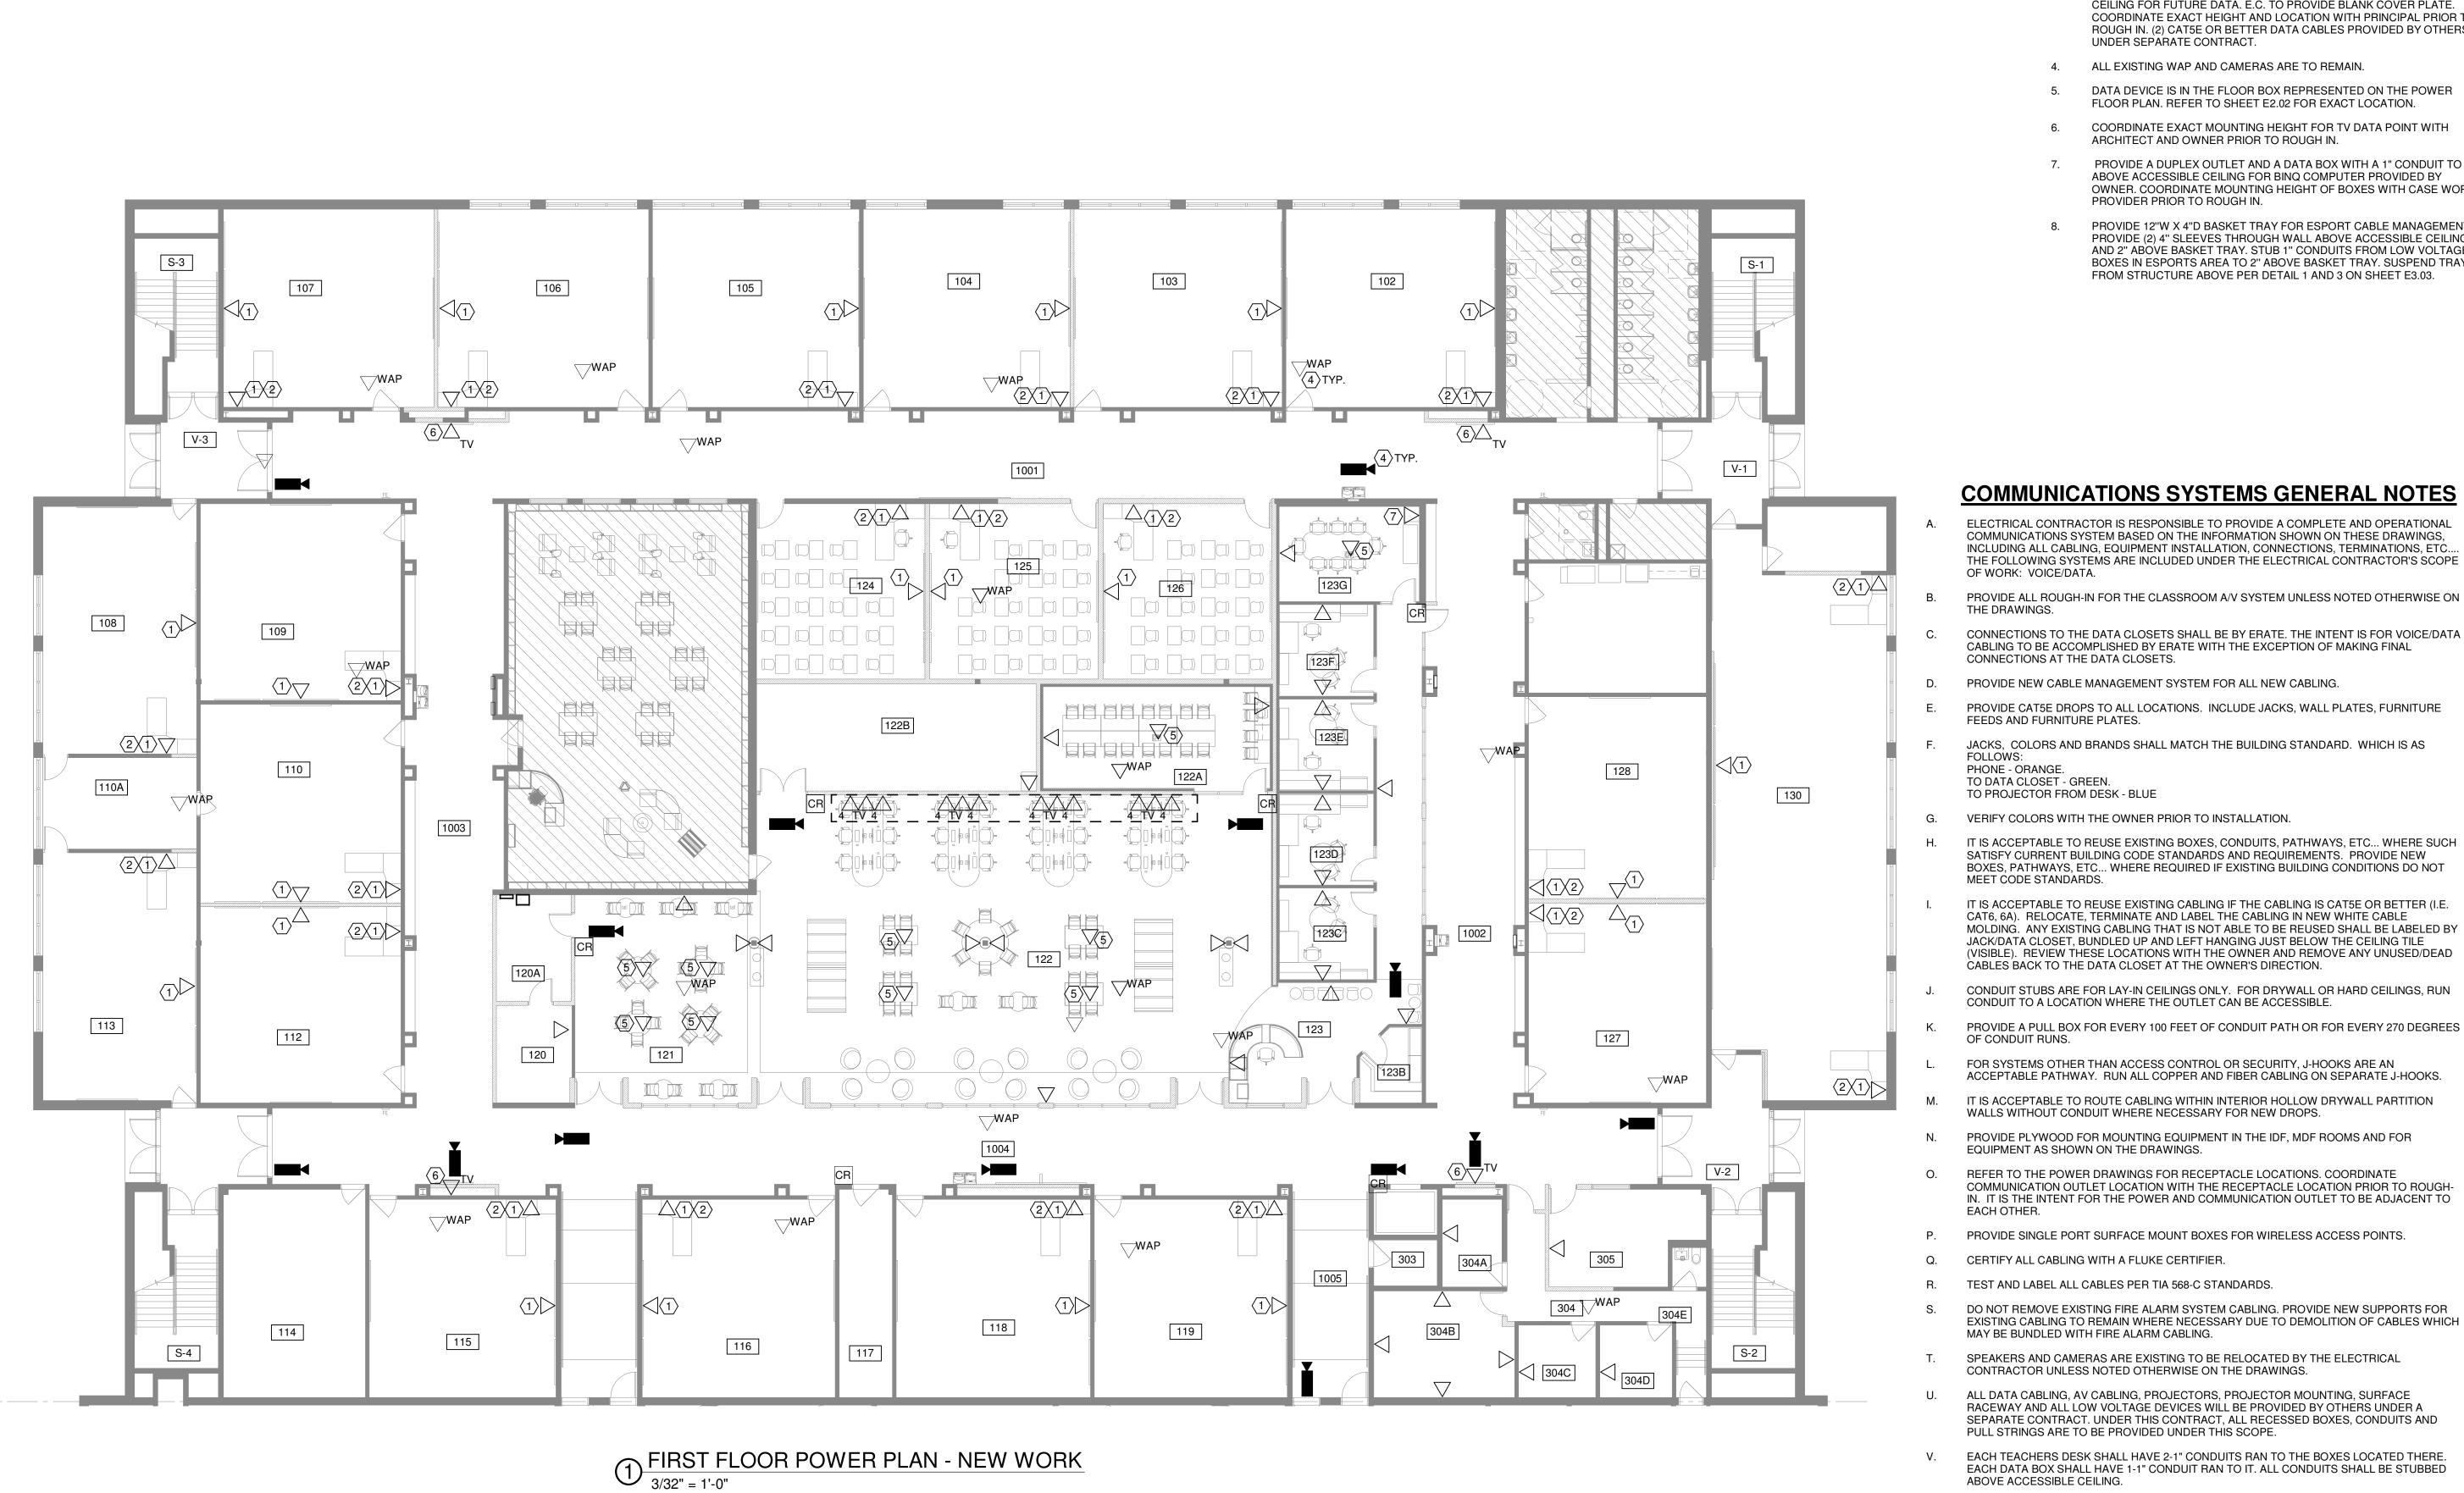
January 24, 2022

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FIRST FLOOR OVERALL DATA PLAN - DEMO

Sheet Number

T1.01



- VERIFY DEVICE MOUNTING HEIGHT WITH THE OWNER PRIOR TO ROUGH IN. PROVIDE CONDUIT BETWEEN THE PROJECTOR AND THE TEACHERS DESK. AV CABLES SHALL BE (1) CAT5E, (1) CAT6A SHIELDED, (1) HDMI, (1) 3.5MM CABLE AND PROVIDED BY OTHERS. PROVIDE CONDUIT FOR (1) CAT5E BETWEEN THE PROJECTOR AND THE DATA CLOSET. CABLE BY OTHERS UNDER SEPARATE CONTRACT.
- E.C. TO PROVIDE BACK BOX AND CONDUIT TO ABOVE ACCESSIBLE CEILING FOR FUTURE DATA. E.C. TO PROVIDE BLANK COVER PLATE. COORDINATE EXACT HEIGHT AND LOCATION WITH PRINCIPAL PRIOR TO ROUGH IN. (2) CAT5E OR BETTER DATA CABLES PROVIDED BY OTHERS UNDER SEPARATE CONTRACT.
- ALL EXISTING WAP AND CAMERAS ARE TO REMAIN.
- DATA DEVICE IS IN THE FLOOR BOX REPRESENTED ON THE POWER
- PROVIDE A DUPLEX OUTLET AND A DATA BOX WITH A 1" CONDUIT TO ABOVE ACCESSIBLE CEILING FOR BINQ COMPUTER PROVIDED BY OWNER. COORDINATE MOUNTING HEIGHT OF BOXES WITH CASE WORK PROVIDER PRIOR TO ROUGH IN.
- PROVIDE 12"W X 4"D BASKET TRAY FOR ESPORT CABLE MANAGEMENT. PROVIDE (2) 4" SLEEVES THROUGH WALL ABOVE ACCESSIBLE CEILING AND 2" ABOVE BASKET TRAY. STUB 1" CONDUITS FROM LOW VOLTAGE BOXES IN ESPORTS AREA TO 2" ABOVE BASKET TRAY. SUSPEND TRAY FROM STRUCTURE ABOVE PER DETAIL 1 AND 3 ON SHEET E3.03.

- PROVIDE (3) CAT5E OR BETTER DATA CABLES BETWEEN THE TEACHER'S DESK TO THE NEAREST DATA CLOSET HOMERUNS PROVIDED BY OTHERS. PROVIDE QUAD ELECTRICAL OUTLET UNDER DESK. IF THERE ARE EXISTING DATA CABLES AT THESE LOCATIONS, THEY MAY BE ABLE TO BE MAINTAINED, HOWEVER, THIS WILL BE DETERMINED IN THE FIELD.

- FLOOR PLAN. REFER TO SHEET E2.02 FOR EXACT LOCATION.
- COORDINATE EXACT MOUNTING HEIGHT FOR TV DATA POINT WITH ARCHITECT AND OWNER PRIOR TO ROUGH IN.



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THE DRAWINGS.

CONNECTIONS TO THE DATA CLOSETS SHALL BE BY ERATE. THE INTENT IS FOR VOICE/DATA CABLING TO BE ACCOMPLISHED BY ERATE WITH THE EXCEPTION OF MAKING FINAL CONNECTIONS AT THE DATA CLOSETS.

- PROVIDE NEW CABLE MANAGEMENT SYSTEM FOR ALL NEW CABLING.
- PROVIDE CAT5E DROPS TO ALL LOCATIONS. INCLUDE JACKS, WALL PLATES, FURNITURE
- JACKS, COLORS AND BRANDS SHALL MATCH THE BUILDING STANDARD. WHICH IS AS FOLLOWS:

TO DATA CLOSET - GREEN. TO PROJECTOR FROM DESK - BLUE

- VERIFY COLORS WITH THE OWNER PRIOR TO INSTALLATION.
- IT IS ACCEPTABLE TO REUSE EXISTING BOXES, CONDUITS, PATHWAYS, ETC... WHERE SUCH SATISFY CURRENT BUILDING CODE STANDARDS AND REQUIREMENTS. PROVIDE NEW BOXES, PATHWAYS, ETC... WHERE REQUIRED IF EXISTING BUILDING CONDITIONS DO NOT MEET CODE STANDARDS.
- IT IS ACCEPTABLE TO REUSE EXISTING CABLING IF THE CABLING IS CAT5E OR BETTER (I.E. CAT6, 6A). RELOCATE, TERMINATE AND LABEL THE CABLING IN NEW WHITE CABLE MOLDING. ANY EXISTING CABLING THAT IS NOT ABLE TO BE REUSED SHALL BE LABELED BY JACK/DATA CLOSET, BUNDLED UP AND LEFT HANGING JUST BELOW THE CEILING TILE (VISIBLE). REVIEW THESE LOCATIONS WITH THE OWNER AND REMOVE ANY UNUSED/DEAD CABLES BACK TO THE DATA CLOSET AT THE OWNER'S DIRECTION.
- CONDUIT STUBS ARE FOR LAY-IN CEILINGS ONLY. FOR DRYWALL OR HARD CEILINGS, RUN CONDUIT TO A LOCATION WHERE THE OUTLET CAN BE ACCESSIBLE.
- PROVIDE A PULL BOX FOR EVERY 100 FEET OF CONDUIT PATH OR FOR EVERY 270 DEGREES OF CONDUIT RUNS.
- FOR SYSTEMS OTHER THAN ACCESS CONTROL OR SECURITY, J-HOOKS ARE AN ACCEPTABLE PATHWAY. RUN ALL COPPER AND FIBER CABLING ON SEPARATE J-HOOKS.
- IT IS ACCEPTABLE TO ROUTE CABLING WITHIN INTERIOR HOLLOW DRYWALL PARTITION WALLS WITHOUT CONDUIT WHERE NECESSARY FOR NEW DROPS.
- PROVIDE PLYWOOD FOR MOUNTING EQUIPMENT IN THE IDF, MDF ROOMS AND FOR EQUIPMENT AS SHOWN ON THE DRAWINGS.
- REFER TO THE POWER DRAWINGS FOR RECEPTACLE LOCATIONS. COORDINATE COMMUNICATION OUTLET LOCATION WITH THE RECEPTACLE LOCATION PRIOR TO ROUGH-IN. IT IS THE INTENT FOR THE POWER AND COMMUNICATION OUTLET TO BE ADJACENT TO
- PROVIDE SINGLE PORT SURFACE MOUNT BOXES FOR WIRELESS ACCESS POINTS.
- CERTIFY ALL CABLING WITH A FLUKE CERTIFIER.
- TEST AND LABEL ALL CABLES PER TIA 568-C STANDARDS.
- DO NOT REMOVE EXISTING FIRE ALARM SYSTEM CABLING. PROVIDE NEW SUPPORTS FOR EXISTING CABLING TO REMAIN WHERE NECESSARY DUE TO DEMOLITION OF CABLES WHICH MAY BE BUNDLED WITH FIRE ALARM CABLING.
- SPEAKERS AND CAMERAS ARE EXISTING TO BE RELOCATED BY THE ELECTRICAL CONTRACTOR UNLESS NOTED OTHERWISE ON THE DRAWINGS.
- ALL DATA CABLING, AV CABLING, PROJECTORS, PROJECTOR MOUNTING, SURFACE RACEWAY AND ALL LOW VOLTAGE DEVICES WILL BE PROVIDED BY OTHERS UNDER A SEPARATE CONTRACT. UNDER THIS CONTRACT, ALL RECESSED BOXES, CONDUITS AND PULL STRINGS ARE TO BE PROVIDED UNDER THIS SCOPE.
- EACH TEACHERS DESK SHALL HAVE 2-1" CONDUITS RAN TO THE BOXES LOCATED THERE. EACH DATA BOX SHALL HAVE 1-1" CONDUIT RAN TO IT. ALL CONDUITS SHALL BE STUBBED ABOVE ACCESSIBLE CEILING.

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FIRST FLOOR OVERALL DATA PLAN - NEW WORK

Sheet Number